


# TOWN OF DUDLEY, MA STEVENS MILL SEWER AND SIDEWALK REPLACEMENT PROJECT

## APRIL 2024

### LIST OF DRAWINGS


SHEET NO.	DRAWING TITLE	SHEET DESCRIPTION
1	G-001	COVER
2	G-002	LEGEND AND ABBREVIATIONS
3	G-003	GENERAL NOTES
4	C-100	OVERALL SITE KEY PLAN
5	C-101	EXISTING CONDITIONS AND DEMOLITION PLAN - 1
6	C-101A	EXISTING CONDITIONS AND DEMOLITION PLAN - 1 ALTERNATE 1 SCOPE
7	C-102	EXISTING CONDITIONS AND DEMOLITION PLAN - 2
8	C-102A	EXISTING CONDITIONS AND DEMOLITION PLAN - 2 ALTERNATE 1 SCOPE
9	C-103A	EXISTING CONDITIONS AND DEMOLITION PLAN - 3 ALTERNATE 2 SCOPE
10	C-104	EXISTING CONDITIONS AND DEMOLITION PLAN - 4
11	C-105	EXISTING CONDITIONS AND DEMOLITION PLAN - 5
12	C-106	EXISTING CONDITIONS AND DEMOLITION PLAN - 6
13	C-201	SITE LAYOUT AND IMPROVEMENTS PLAN - 1
14	C-201A	SITE LAYOUT AND IMPROVEMENTS PLAN - 1 ALTERNATE 1 SCOPE
15	C-202	SITE LAYOUT AND IMPROVEMENTS PLAN - 2
16	C-202A	SITE LAYOUT AND IMPROVEMENTS PLAN - 2 ALTERNATE 1 SCOPE
17	C-203A	SITE LAYOUT AND IMPROVEMENTS PLAN - 3 ALTERNATE 2 SCOPE
18	C-204	SITE LAYOUT AND IMPROVEMENTS PLAN - 4
19	C-205	SITE LAYOUT AND IMPROVEMENTS PLAN - 5
20	C-206	SITE LAYOUT AND IMPROVEMENTS PLAN - 6
21	C-300	SEWER LAYOUT OVERALL SITE PLAN
22	C-301	VILLAGE STREET SEWER PLAN AND PROFILE
23	C-302	MILL STREET SEWER PLAN AND PROFILE
24	C-303	WEST MAIN STREET SEWER PLAN AND PROFILE - 1
25	C-304	WEST MAIN STREET SEWER PLAN AND PROFILE - 2
26	C-305	ARDLOCK PLACE SEWER PLAN AND PROFILE - 1
27	C-306	ARDLOCK PLACE SEWER PLAN AND PROFILE - 2
28	C-501	SITE DETAILS - 1
29	C-502	SITE DETAILS - 2
30	C-503	SITE DETAILS - 3
31	C-504	SITE DETAILS - 4
32	C-505	SITE DETAILS - 5
33	C-506	TRAFFIC MANAGEMENT PLAN

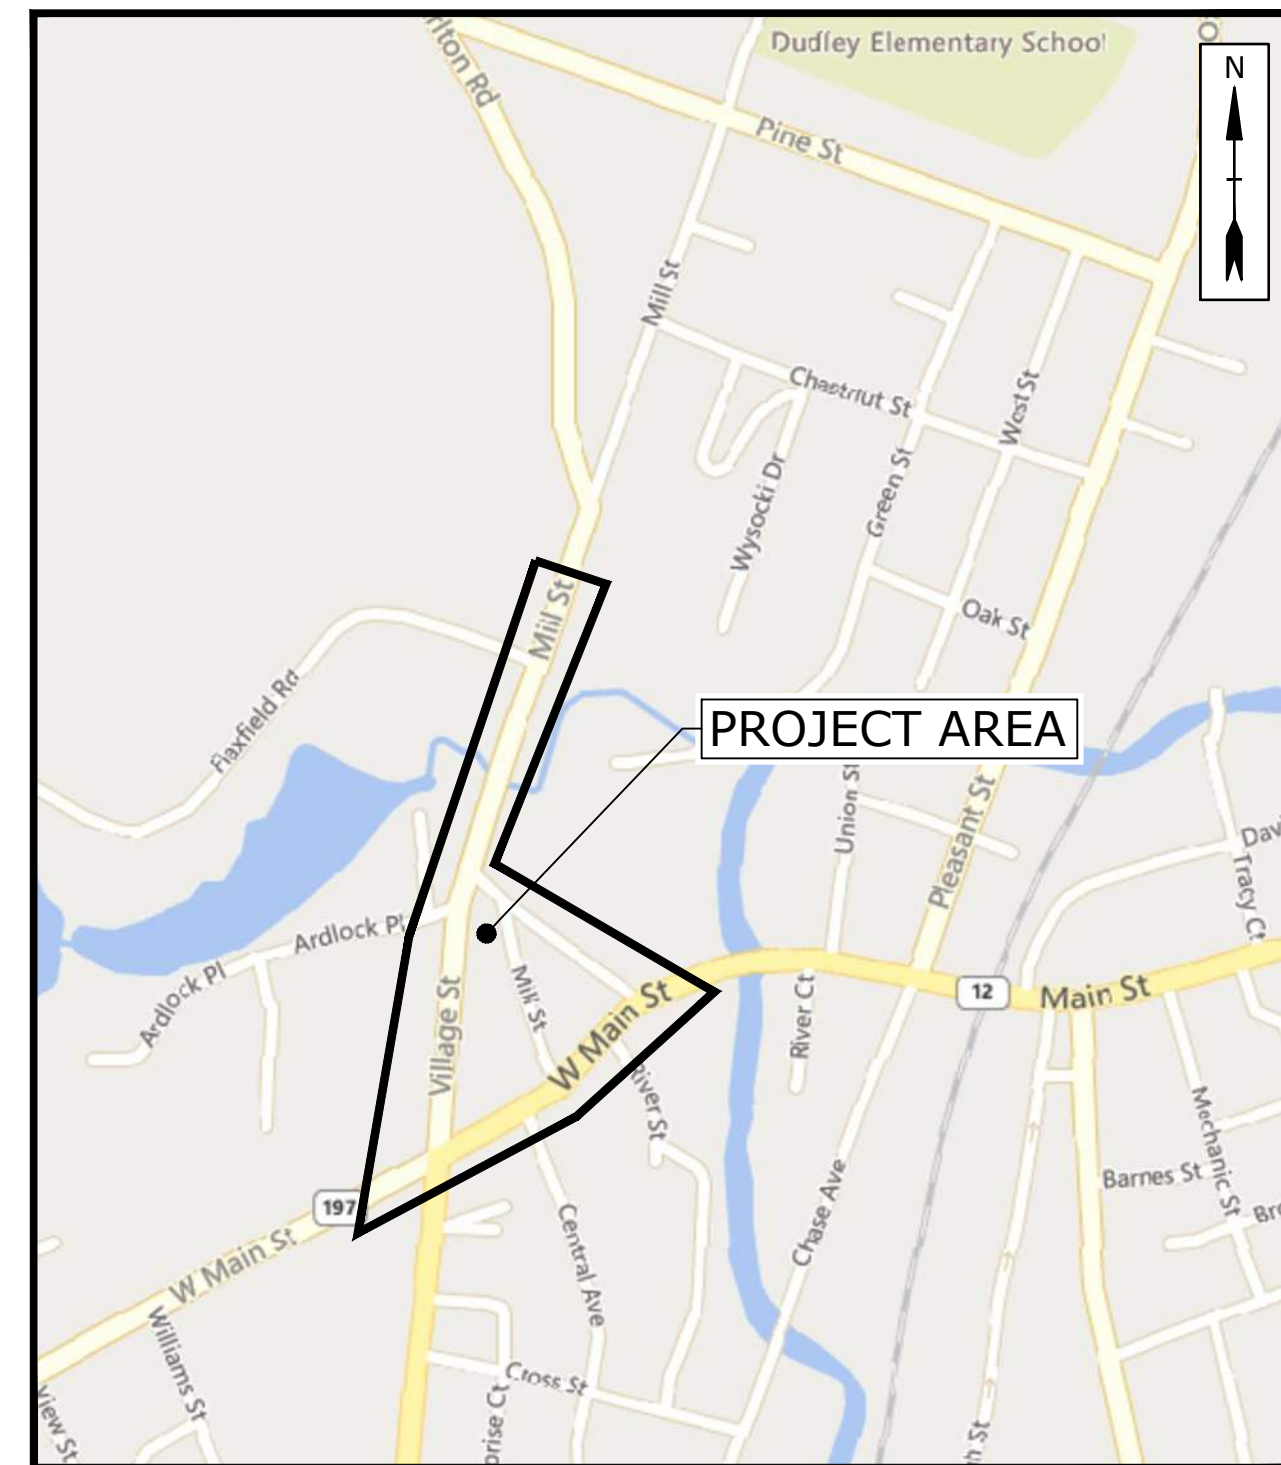


LOCATION MAP  
SCALE: 1" = 500'

PREPARED BY:

**Tighe&Bond**

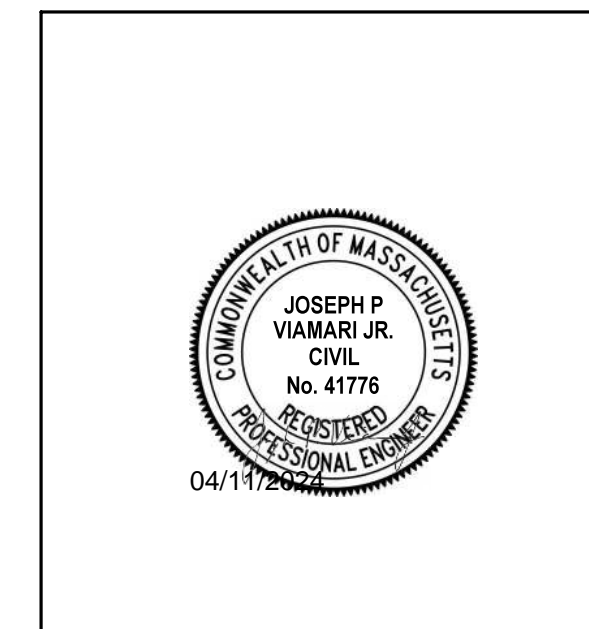

JOSEPH P. VIAMARI JR, PE

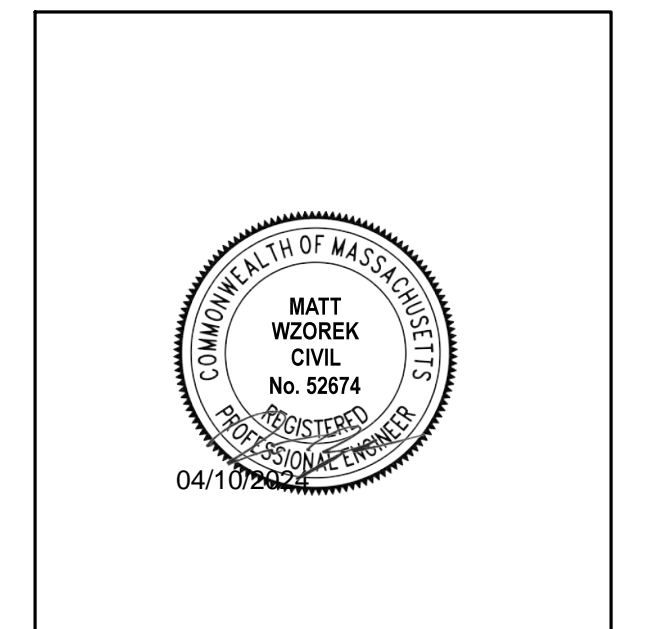

MATTHEW P. WZOREK, PE

PREPARED FOR:

TOWN OF DUDLEY  
JONATHAN RUDA, TOWN ADMINISTRATOR

MASSWORKS INFRASTRUCTURE PROGRAM  
MASSACHUSETTS EXECUTIVE OFFICE OF HOUSING AND ECONOMIC DEVELOPMENT  
1 ASHBURTON PLACE, ROOM 2101  
BOSTON, MA 02108

**COMPLETE SET 33 SHEETS**

**LEGEND**



DESCRIPTION	EXISTING	PROPOSED
PROPERTY LINE	-----	-----
RIGHT-OF-WAY LINE	-----	-----
EASEMENT LINE	-----	-----
LIMITS OF WORK	-----	-----
INTERMEDIATE CONTOURS	-----	-----
INDEX CONTOURS	-----	-----
SPOT GRADE	X 141.2	+ 32.0
STORM DRAIN	SD	SD
GRAVITY SANITARY SEWER	SS	SS
WATER SERVICE	W	W
UNDERGROUND ELECTRIC	E	E
TELEPHONE SERVICE	T	T
GAS SERVICE	G	G
CURB	=====	=====
EDGE OF PAVEMENT	=====	=====
SIDEWALK	=====	=====
GUARDRAIL	=====	=====
STORM DRAIN STRUCTURES	MANHOLE (M) CATCH BASIN (CB)	
SANITARY SEWER MANHOLE	(S)	(S)
WATER SERVICE STRUCTURES	HYDRANT (H) MANHOLE (M) VALVE (V)	
GAS SERVICE STRUCTURES	MANHOLE (G) VALVE (GV)	
ELECTRIC SERVICE STRUCTURES	UTILITY CO. POLE (P) MANHOLE (E) LIGHT (L)	
TELECOMMUNICATIONS MANHOLE	(T)	
TREELINE	~~~~~	~~~~~
TREE	(E) EVERGREEN (D) DECIDUOUS	
SIGN	(S)	
TRAFFIC SIGNAL	(TS)	
ELECTRIC HANDHOLE	(EH)	
SHUT OFF (UNKNOWN)	(SO)	
POST	(P)	
FLAG POLE	(FP)	
EMERGENCY CALL BOX	(ECB)	
IRRIGATION CONTROL VALVE	(ICV)	

**ABBREVIATIONS**

ABDN('D)	ABANDON(ED)
AC	ASBESTOS CEMENT PIPE
BC	BITUMINOUS CURB
BFP	BACK FLOW PREVENTOR
BIT	BITUMINOUS
BOC	BOTTOM OF CURB
BOT	BOTTOM
CB	CATCH BASIN
CEM	CEMENT
CI	CAST IRON PIPE
CL	CENTERLINE
CO	CLEAN OUT
CONC	CONCRETE
CPP	CORRUGATED POLYETHYLENE PIPE
CY	CUBIC YARD
DI	DUCTILE IRON PIPE
DIA	DIAMETER
DMH	DRAIN MANHOLE
E	EAST
EG	EXISTING GRADE
EL/ELEV	ELEVATION
ELEC	ELECTRIC
EMH	ELECTRIC MANHOLE
EOP	EDGE OF PAVEMENT
EXIST	EXISTING
G	GAS
GG	GAS GATE
GRAN	GRANITE
HC	HANDICAP
HDPE	HIGH DENSITY POLYETHYLENE
HSE	HOUSE
HMA	HOT MIX ASPHALT
HYD	HYDRANT
IN	INCHES
INV	INVERT
L	LENGTH OF CURB
LP	LIGHT POLE
LT	LEFT
MAX	MAXIMUM
MH	MANHOLE
MIN	MINIMUM
MISC	MISCELLANEOUS
MON	MONUMENT
MTD	MOUNTED

**ABBREVIATIONS CONT'D**

MJ	MECHANICAL JOINT
N	NORTH
NITC	NOT IN THIS CONTRACT
NTS	NOT TO SCALE
N/A	NOT APPLICABLE
N/F	NOW OR FORMERLY
OC	ON CENTER
OCS	OUTLET CONTROL STRUCTURE
OH	OVERHEAD
PC	POINT OF CURVATURE
PCC	POINT OF COMPOUND CURVATURE
PCPP	PERFORATED CORRUGATED POLYETHYLENE PIPE
PERF	PERFORATED
PI	POINT OF INTERSECTION
PRC	POINT OF REVERSE CURVATURE
PSF	POUNDS PER SQUARE FOOT
PSI	POUNDS PER SQUARE INCH
PT	POINT OF TANGENCY
PVC	POLYVINYLCHLORIDE
PVMT	PAVEMENT
R	RADIUS
RCP	REINFORCED CONCRETE PIPE
RD	ROAD DRAIN
REV	REVISION
ROW	RIGHT OF WAY
RT	RIGHT
R&D	REMOVE AND DISPOSE OF
R&R	REMOVE AND RESET
R&S	REMOVE AND STACK
S	SOUTH
SAN	SANITARY
SCH	SCHEDULE
SF	SQUARE FOOT
SMH	SEWER MANHOLE
STA	STATION
TC	TOP OF CURB
TEL	TEL-DATA
TP	TEST PIT
TYP	TYPICAL
UP	UTILITY POLE
W	WATER
WG	WATER GATE
WV	WATER VALVE

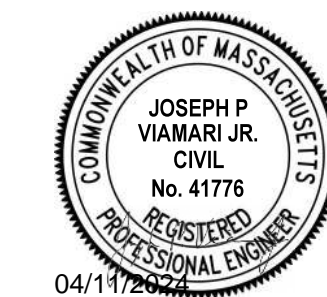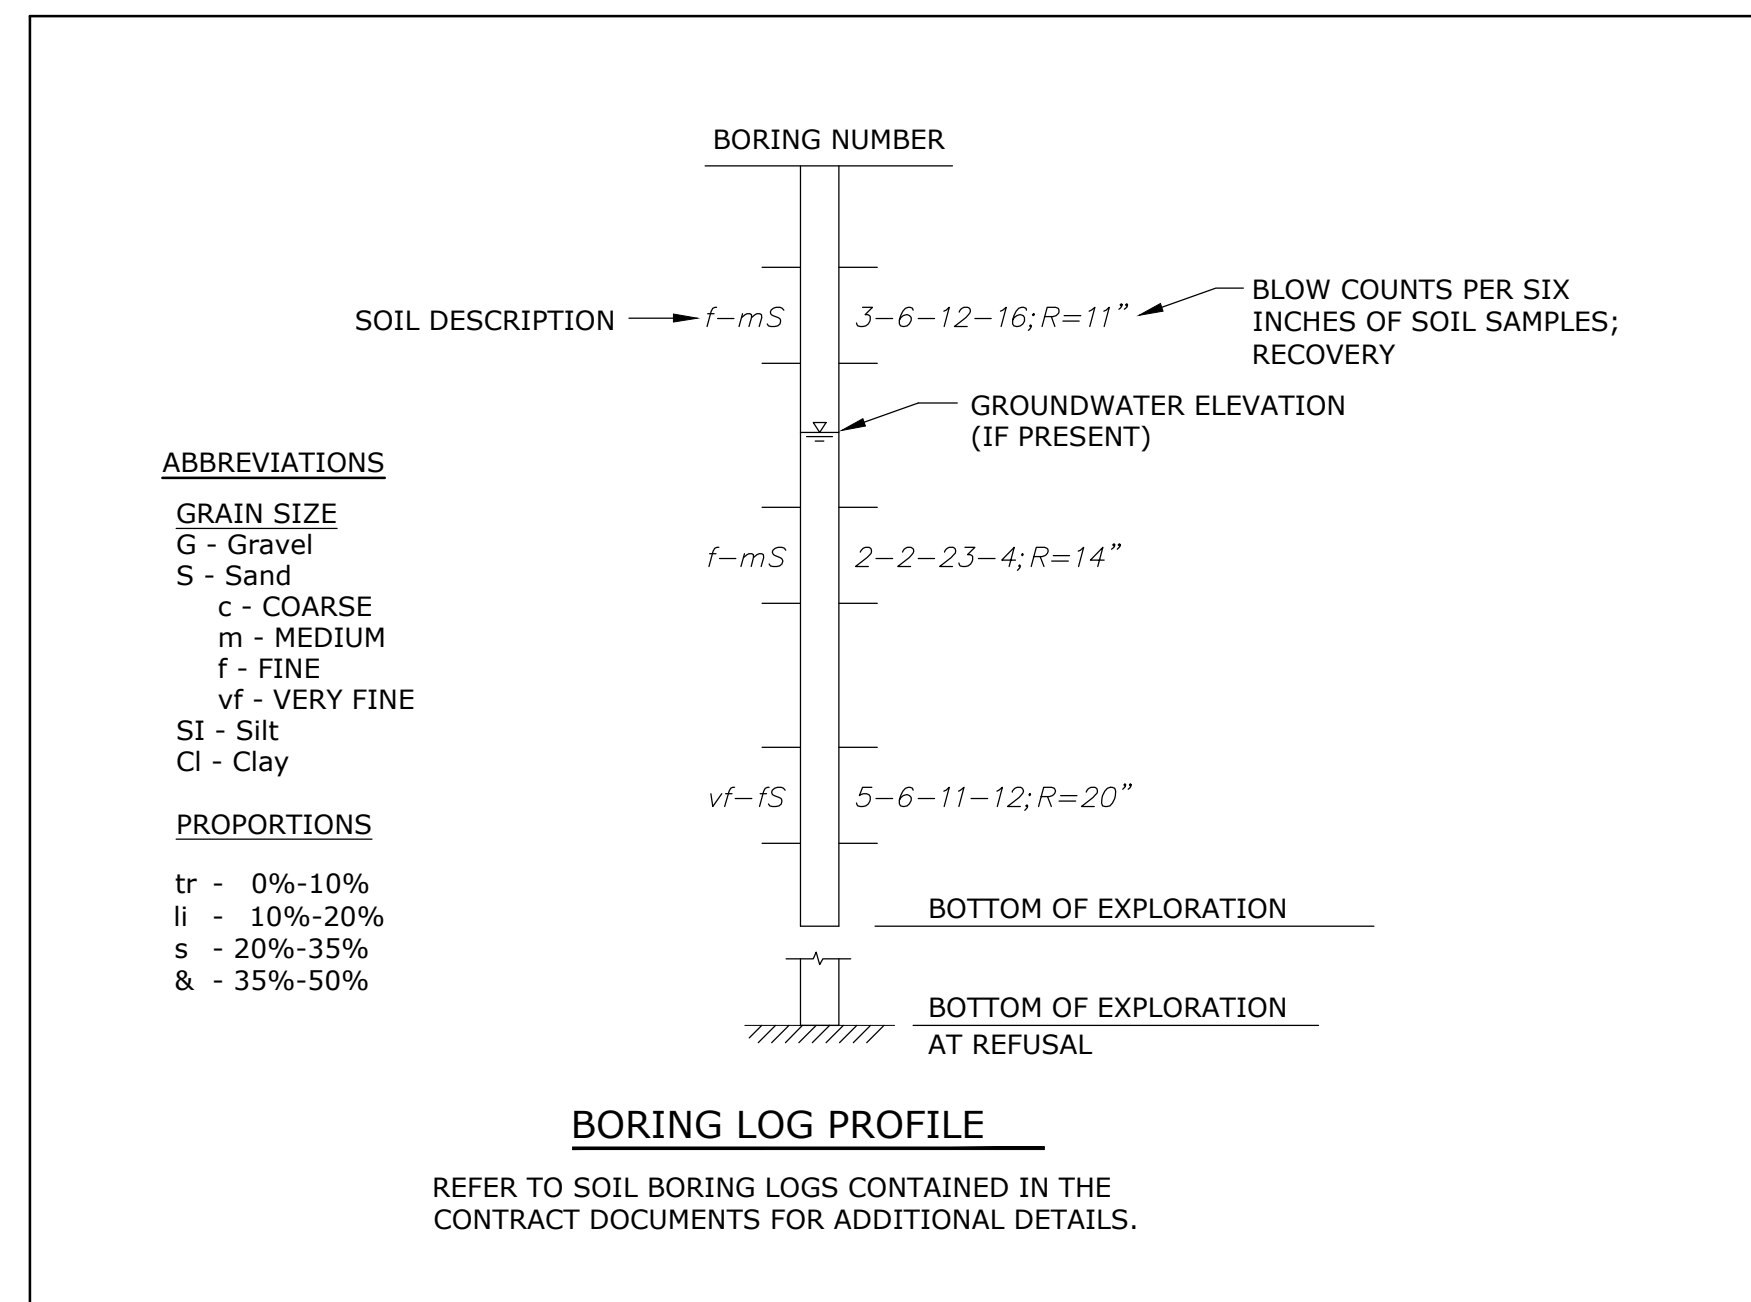

**LEGEND**

RESOURCE AREAS	
VEGETATED WETLAND LIMIT	-----
100-FOOT BUFFER ZONE	-----
200-FOOT RIVERFRONT AREA	-----
25-FOOT WETLAND PROTECTION SET BACK (LOCAL)	-----
TOP OF BANK / MEAN ANNUAL HIGH WATER (MAHW)	-----
BORDERING LAND SUBJECT TO FLOODING (BLSF)	-----
100-FOOT BUFFER ZONE TO BLSF (LOCAL)	-----
WETLAND FLAG	(WF)

**LEGEND**

DEMOLITION / GEOTECHNICAL	
EROSION & SEDIMENT CONTROL	-----
PAVEMENT SAWCUT LINE	-----
UTILITY TO BE DEMOLISHED	-----
ITEM TO BE DEMOLISHED	-----
TEST PIT	(TP)
MONITORING WELL	(MW)
BORING	(B)

**Stevens Mill Sewer and Sidewalk Replacement Project**

Town of Dudley

Dudley, MA

0	04/10/2024	ISSUED FOR BIDDING
MARK	DATE	DESCRIPTION
PROJECT NO:	D5011-018	
DATE:	04/2024	
FILE:	Cover.dwg	
DRAWN BY:	ND/ABS	
CHECKED BY:	MPW	
APPROVED BY:	JPV	

**LEGEND AND ABBREVIATIONS**

SCALE: NO SCALE

G-002

GENERAL NOTES

- 1. NOTIFY DIGSAFE AT 1-888-344-7233 AND OTHER UTILITY OWNERS IN THE AREA NOT ON THE DIGSAFE LIST AT LEAST 72 HOURS PRIOR TO ANY DIGGING, TRENCHING, ROCK REMOVAL, DEMOLITION, BORING, BACKFILLING, GRADING, LANDSCAPING, OR ANY OTHER EARTH MOVING OPERATIONS.
2. LOCATIONS OF EXISTING UTILITIES ARE APPROXIMATE. IN ADDITION, SOME UTILITIES MAY NOT BE SHOWN. DETERMINE THE EXACT LOCATION OF UTILITIES BY TEST PIT OR OTHER METHODS, AS NECESSARY TO PREVENT DAMAGE TO UTILITIES AND/OR INTERRUPTIONS IN UTILITY SERVICE.
3. NOT ALL OF THE UTILITY SERVICES TO BUILDINGS ARE SHOWN. THE CONTRACTOR SHALL ANTICIPATE THAT EACH PROPERTY HAS SERVICE CONNECTIONS FOR THE VARIOUS UTILITIES.
4. BOLD TEXT AND LINES INDICATE PROPOSED WORK. LIGHT TEXT AND LINES INDICATE APPROXIMATE EXISTING CONDITIONS.
5. TIGHE & BOND ASSUMES NO RESPONSIBILITY FOR ANY ISSUES, LEGAL OR OTHERWISE, RESULTING FROM CHANGES MADE TO THESE DRAWINGS WITHOUT WRITTEN AUTHORIZATION FROM TIGHE & BOND.
6. EXCAVATE ADDITIONAL TEST PITS TO LOCATE EXISTING UTILITIES AS DIRECTED OR APPROVED BY THE ENGINEER.
7. NOTIFY THE ENGINEER OF ANY UTILITIES IDENTIFIED DURING CONSTRUCTION THAT ARE NOT SHOWN ON THE DRAWINGS OR THAT DIFFER IN SIZE OR MATERIAL.
8. THE CONTRACTOR IS RESPONSIBLE FOR SITE SAFETY; COORDINATION WITH THE OWNER, ALL SUBCONTRACTORS, AND WITH OTHER CONTRACTORS WORKING WITHIN THE LIMITS OF WORK, AND THE MEANS AND METHODS OF CONSTRUCTING THE PROPOSED WORK.
9. OBTAIN, PAY FOR AND COMPLY WITH PERMITS, NOTICES, AND FEES NECESSARY TO COMPLETE THE WORK. ARRANGE AND PAY FOR NECESSARY INSPECTIONS AND APPROVALS FROM THE JURISDICTIONAL AUTHORITIES.
10. SHORE UTILITY TRENCHES WHERE FIELD CONDITIONS DICTATE AND/OR WHERE REQUIRED BY LOCAL, STATE, AND FEDERAL HEALTH AND SAFETY CODES.
11. FIELD VERIFY ALL EXISTING CONDITIONS PRIOR TO CONSTRUCTION. IF FIELD CONDITIONS ARE OBSERVED THAT VARY SIGNIFICANTLY FROM THOSE SHOWN ON THE DRAWINGS, IMMEDIATELY NOTIFY THE ENGINEER IN WRITING FOR RESOLUTION OF THE CONFLICTING INFORMATION.
12. PROTECT AND MAINTAIN ALL UTILITIES IN THE AREAS UNDER CONSTRUCTION DURING THE WORK. LEAVE ALL PIPES AND STRUCTURES WITHIN THE LIMITS OF THE CONTRACT IN A CLEAN AND OPERABLE CONDITION AT THE COMPLETION OF THE WORK.
13. NOTIFY THE ENGINEER IN WRITING OF ANY CONFLICT, ERROR, AMBIGUITY, OR DISCREPANCY WITH THE PLANS OR BETWEEN THE PLANS AND ANY APPLICABLE LAW, REGULATION, CODE, STANDARD SPECIFICATION, OR MANUFACTURER'S INSTRUCTIONS.
14. THE CONTRACTOR IS RESPONSIBLE FOR SUPPORT OF EXISTING UTILITIES AND REPAIR OR REPLACEMENT COSTS OF UTILITIES DAMAGED DURING CONSTRUCTION, WHETHER ABOVE OR BELOW GRADE.
15. TAKE NECESSARY MEASURES AND PROVIDE CONTINUOUS BARRIERS OF SUFFICIENT TYPE, SIZE, AND STRENGTH TO PREVENT ACCESS TO ALL WORK AND STAGING AREAS AT THE COMPLETION OF EACH DAYS WORK.
16. NO OPEN TRENCHES WILL BE ALLOWED OVER NIGHT. THE USE OF ROAD PLATES TO PROTECT THE EXCAVATION WILL BE CONSIDERED UPON REQUEST, BUT BACKFILLING IS PREFERRED.
17. THE CONTRACTOR IS RESPONSIBLE FOR ALL NECESSARY TRAFFIC CONTROL/SAFETY DEVICES TO ENSURE SAFE VEHICULAR AND PEDESTRIAN ACCESS THROUGH THE WORK AREA, OR FOR SAFELY IMPLEMENTING DETOURS AROUND THE WORK AREA.
18. MAINTAIN EMERGENCY ACCESS TO ALL PROPERTIES WITHIN THE PROJECT AREA AT ALL TIMES DURING CONSTRUCTION.
19. WHEN WORKING IN THE ROAD, PROVIDE THE OWNER AND LOCAL FIRE/POLICE/SCHOOL AUTHORITIES A DETAILED PLAN OF APPROACH INDICATING METHODS OF PROPOSED TRAFFIC ROUTING ON A DAILY BASIS.
20. REMOVE AND DISPOSE OF ALL CONSTRUCTION-RELATED WASTE MATERIALS AND DEBRIS IN STRICT ACCORDANCE WITH ALL APPLICABLE LOCAL, STATE, AND FEDERAL LAWS.
21. THE TERM "DEMOLISH" USED ON THE DRAWINGS MEANS TO REMOVE AND DISPOSE OF IN ACCORDANCE WITH LOCAL, STATE, AND FEDERAL REQUIREMENTS.
22. THE TERM "ABANDON" USED ON THE DRAWINGS MEANS TO LEAVE IN PLACE AND TAKE APPROPRIATE MEASURES TO DECOMMISSION AS SPECIFIED OR NOTED ON THE DRAWINGS.
23. ALL PROPOSED WORK MAY BE ADJUSTED IN THE FIELD BY THE OWNER'S PROJECT REPRESENTATIVE TO MEET EXISTING CONDITIONS.

SEWER / DRAINAGE SYSTEM IMPROVEMENTS NOTES

- 1. LOCATIONS OF PROPOSED SANITARY SEWER MAINS, SANITARY SEWER SERVICES, AND STRUCTURES ARE APPROXIMATE AND MAY BE ADJUSTED DURING CONSTRUCTION AFTER INVESTIGATIVE WORK. FINAL SANITARY SEWER MAIN LOCATIONS, AND ASSOCIATED STRUCTURES, WILL BE DETERMINED IN THE FIELD BY THE ENGINEER.
2. ADJUSTMENTS TO THE PROPOSED SANITARY SEWER LAYOUTS AND ELEVATIONS SHALL NOT BE CONSIDERED CAUSE FOR ADDITIONAL PAYMENTS. THE CONTRACTOR SHALL NOT MAKE PROPOSED SANITARY SEWER/ STORM DRAIN LAYOUT AND ELEVATION ADJUSTMENTS WITHOUT APPROVAL FROM THE ENGINEER.
3. MANHOLES SHALL BE 48-INCH DIAMETER, UNLESS NOTED OTHERWISE.
4. PROPOSED SANITARY SEWER SERVICE LATERALS FOR NEW SERVICES SHALL BE 6-INCH DIAMETER PVC, UNLESS NOTED OTHERWISE, AND INSTALLED FROM THE PROPOSED SANITARY SEWER MAIN TO THE PROPERTY LINE FOR EACH PROPERTY IDENTIFIED AS REQUIRING A SANITARY SEWER SERVICE ON THE DRAWINGS.
5. PROPOSED SANITARY SEWER CONNECTIONS TO EXISTING SERVICE LATERALS SHALL BE PVC AND SHALL MATCH THE SIZE OF THE EXISTING SERVICE, CONNECT TO EXISTING SERVICE AT PROPERTY LINE WITH A PVC CLEANOUT.
6. MINIMUM PITCH FOR SERVICE LATERALS SHALL BE 1/4 INCH PER FOOT, UNLESS OTHERWISE APPROVED BY THE ENGINEER.
7. DISTANCES AND SLOPES OF PROPOSED SANITARY SEWERS ARE BASED ON DISTANCES FROM CENTERLINE TO CENTERLINE OF STRUCTURES.
8. THERE ARE PROPERTIES WITHIN THE PROJECT AREA FOR WHICH THE LOCATION OF THE SANITARY SEWER SERVICE IS UNKNOWN. AT THESE PROPERTIES, THERE IS EITHER NO AVAILABLE INFORMATION ON THE SANITARY SEWER SERVICE OR THERE ARE MULTIPLE SANITARY SEWER SERVICES IN FRONT OF THE PROPERTY. AT THESE LOCATIONS, THE FOLLOWING PROCEDURES SHALL BE FOLLOWED:
- WHERE THE SANITARY SEWER SERVICE LATERAL(S) FOR A PROPERTY WILL BE CROSSED/EXPOSED DURING THE INSTALLATION OF THE PROPOSED SANITARY SEWER MAIN, LOCATE/INVESTIGATE THE LATERAL(S) DURING CONSTRUCTION OF THE PROPOSED SANITARY SEWER MAIN.
- WHERE THE SANITARY SEWER SERVICE LATERAL(S) TO A PROPERTY WILL NOT BE CROSSED DURING EXCAVATION FOR THE PROPOSED SANITARY SEWER MAIN, CONDUCT A SERVICE INVESTIGATION IN ACCORDANCE WITH THE CONTRACT DOCUMENTS PRIOR TO CONSTRUCTION OF THE PROPOSED SANITARY SEWER MAIN AT THIS LOCATION.
9. MAINTAIN UNINTERRUPTED SANITARY SEWER SERVICE DURING CONSTRUCTION. PROVIDE BYPASS PUMPING OF SEWAGE FLOWS AND/OR TEMPORARY CONNECTIONS, AS NECESSARY.
10. MAINTAIN A MINIMUM HORIZONTAL DISTANCE OF AT LEAST 10 FEET FROM ANY EXISTING OR PROPOSED WATER MAIN. IF SITE CONDITIONS PREVENT A HORIZONTAL SEPARATION OF AT LEAST 18 INCHES BELOW THE BOTTOM OF THE WATER MAIN, A LESSER DISTANCE WILL BE ALLOWED IF THE SANITARY SEWER/STORM DRAIN IS CONSTRUCTED IN A SEPARATE TRENCH WITH THE TOP OF THE SANITARY SEWER AT LEAST 18 INCHES BELOW THE BOTTOM OF THE WATER MAIN.
11. WHENEVER A PROPOSED SANITARY SEWER MUST CROSS A WATER MAIN, CONSTRUCT THE SANITARY SEWER/STORM DRAIN SO THE TOP OF THE SANITARY SEWER/STORM DRAIN IS AT LEAST 18 INCHES BELOW THE BOTTOM OF THE WATER MAIN. THE SANITARY SEWER JOINTS SHALL BE EQUIDISTANT AND LOCATED AS FAR AWAY AS POSSIBLE FROM THE WATER MAIN JOINTS. WHEN THE PROPOSED SANITARY SEWER CANNOT MEET THE ABOVE REQUIREMENTS, ENCASE THE PROPOSED SANITARY SEWER IN CONCRETE.

UTILITY CONTACTS

Table with utility contact information including GAS, NATIONAL GRID, ELECTRIC, NATIONAL GRID, CABLE, CHARTER, WATER-SEWER DUDLEY WATER-SEWER SUPERINTENDENT, TELEPHONE VERIZON, DUDLEY HIGHWAY DEPARTMENT, DUDLEY POLICE DEPARTMENT, DUDLEY FIRE DEPARTMENT, and contact numbers for MELISSA OWENS, JACK SARAIVA, RICK MOLNAR, GEORGE PATRINOS, and KAREN MEALEY.

EROSION CONTROL NOTES


- 1. PROVIDE ALL EROSION CONTROL MEASURES SHOWN, SPECIFIED, REQUIRED BY PERMIT, AND/OR REQUIRED BY THE ENGINEER PRIOR TO ANY CONSTRUCTION OR IMMEDIATELY UPON REQUEST. MAINTAIN SUCH CONTROL MEASURES UNTIL FINAL SURFACE TREATMENTS ARE IN PLACE AND/OR UNTIL PERMANENT VEGETATION IS ESTABLISHED.
2. INSTALL SILT SACKS OR OTHER APPROVED SEDIMENTATION BARRIERS IN/AT ALL CATCH BASINS IN THE PROJECT AREA.
3. COMPACT, STABILIZE, AND LOAM AND SEED SIDE SLOPES, SHOULDER AREAS AND DISTURBED VEGETATED AREAS IN ACCORDANCE WITH THE CONTRACT DOCUMENTS AND AS REQUIRED BY PERMITS.
4. SETTLE OR FILTER ALL SILT-LADEN WATER FROM DEWATERING ACTIVITIES IN A SEDIMENTATION OR FILTER BAG TO REMOVE SEDIMENTS PRIOR TO RELEASE USING A SEDIMENTATION OR FILTER BAG LOCATED DOWN-GRADIENT OF THE DEWATERED AREA.
5. UTILIZE APPROPRIATE DEWATERING SYSTEMS AND TECHNIQUES TO MAINTAIN EXCAVATIONS SUFFICIENTLY DRY FROM GROUNDWATER AND/OR SURFACE RUNOFF SO AS NOT TO ADVERSELY AFFECT CONSTRUCTION PROCEDURES OR CAUSE EXCESSIVE DISTURBANCE OF UNDERLYING NATURAL GROUND.
6. WATER FROM THE TRENCHES AND EXCAVATIONS SHALL BE DISPOSED OF IN SUCH A MANNER AS TO AVOID PUBLIC NUISANCE, INJURY TO PUBLIC HEALTH OR THE ENVIRONMENT, DAMAGE TO PUBLIC OR PRIVATE PROPERTY, OR DAMAGE TO THE WORK COMPLETED OR IN PROGRESS.
7. WATER FROM TRENCHES AND EXCAVATIONS SHALL NOT BE DISCHARGED DIRECTLY TO STORM DRAIN SYSTEMS.
8. PRECAUTIONS SHALL BE TAKEN TO PROTECT NEW WORK FROM FLOODING DURING STORMS.
9. REMOVE AND PROPERLY DISPOSE OF SILT TRAPPED AT BARRIERS IN UPLAND AREAS OUTSIDE BUFFER ZONES.
10. THE AREAS OF CONSTRUCTION SHALL REMAIN IN A STABLE CONDITION AT THE CLOSE OF EACH CONSTRUCTION DAY.
11. LOAM AND SEED ALL DISTURBED VEGETATED AREAS TO ESTABLISH COVER AND STABILIZATION AS SOON AS POSSIBLE FOLLOWING DISTURBANCE.
12. TEMPORARY STOCKPILES OF MATERIALS RELATED TO THE CONSTRUCTION ACTIVITIES ARE TO BE PROPERLY STABILIZED, PROTECTED AND DEMARCATED TO PREVENT MOVEMENT OF MATERIAL INTO THE STORM DRAIN SYSTEM OR ON TO ADJACENT PROPERTIES.
13. MAINTAIN AN ADDITIONAL SUPPLY OF EROSION CONTROL MEASURES ON-SITE FOR EMERGENCY REPAIRS.
14. REFUELING AND ANY WORK ASSOCIATED WITH THE MAINTENANCE OF CONSTRUCTION EQUIPMENT SHALL BE PERFORMED IN COMPLIANCE WITH ALL PERTINENT REGULATIONS.
15. STORE FUEL, OIL, PAINT, OR OTHER HAZARDOUS MATERIALS IN A SECONDARY CONTAINER AND REMOVE TO A SECURE LOCKED AND COVERED AREA DURING NON-WORK HOURS.
16. PROVIDE A SUPPLY OF ABSORBENT SPILL RESPONSE MATERIALS SUCH AS BOOMS, BLANKETS, AND OIL ABSORBENT MATERIALS AT THE CONSTRUCTION SITE AT ALL TIMES TO CLEAN UP POTENTIAL SPILLS OF HAZARDOUS MATERIALS.

BASE PLAN NOTES

- 1. THE EXISTING CONDITIONS INFORMATION SHOWN ON THE DRAWINGS IS BASED ON THE FOLLOWING:
- SURVEY DRAWINGS PROVIDED BY SHERMAN & FRYDRYK, LLC TITLED EXISTING CONDITIONS PLAN AND DATED JANUARY 21, 2021 AND APRIL 27, 2022.
- FIELD INVESTIGATIONS PERFORMED BY TIGHE & BOND ON JUNE 24 AND 29, AND JULY 21, 2022.
2. UTILITY LOCATIONS SHOWN WERE PLOTTED FROM INFORMATION SUPPLIED BY RESPECTIVE UTILITY COMPANIES AND DATA OBTAINED FROM FIELD SURVEYS AND RECORD DRAWINGS. THE ACCURACY AND COMPLETENESS OF SUBSURFACE INFORMATION SHOWN ON THESE DRAWINGS IS NOT GUARANTEED.
3. SUB-SURFACE EXPLORATIONS WERE PERFORMED BY MARTIN GEO-ENVIRONMENTAL, LLC ON AUGUST 16, 2022.
4. THE DRAWINGS ARE BASED ON THE FOLLOWING DATUMS: HORIZONTAL - NAD83 ; VERTICAL - NAVD88
5. THE EXISTING CONDITIONS SHOWN ARE APPROXIMATE. FIELD VERIFY EXISTING CONDITIONS.
6. THE PROPERTY LINES SHOWN ON THE DRAWINGS ARE APPROXIMATE AND ARE NOT BASED ON DEED OR PLAN RESEARCH.

SURFACE RESTORATION NOTES

- 1. ALL PAVEMENT DAMAGED BY THE CONTRACTOR'S OPERATIONS SHALL BE REPLACED IN ACCORDANCE WITH THE CONTRACT DOCUMENTS.
2. PROVIDE SITE GRADING AT HANDICAPPED RAMPS, SIDEWALKS, AND BUILDING ENTRANCES THAT IS CONSISTENT WITH THE RELEVANT ACCESS REQUIREMENTS OF THE ARCHITECTURAL BARRIERS ACT (ABA), THE AMERICANS WITH DISABILITIES ACT (ADA), AND MA ARCHITECTURAL ACCESS BOARD REQUIREMENTS (AAB).
3. PROTECT PROJECT FEATURES (E.G., WALLS, FENCES, MAIL BOXES, SIGNS, SIDEWALKS, CURBING, STAIRS, WALKWAYS, TREES, ETC.) FROM DAMAGE DURING CONSTRUCTION.
4. IF REMOVAL OF PROJECT FEATURES IS REQUIRED IN ORDER TO PERFORM THE PROPOSED WORK, REMOVE THOSE SITE FEATURES ONLY UPON APPROVAL OF ENGINEER.
5. EXISTING SURVEY MONUMENTS DISTURBED BY THE CONTRACTOR SHALL BE REPLACED BY A LAND SURVEYOR LICENSED IN THE STATE IN WHICH THE WORK IS PERFORMED AT NO ADDITIONAL COST TO THE OWNER.
6. COORDINATE THE ADJUSTMENT OF EXISTING UTILITY STRUCTURES WITH EACH RESPONSIBLE UTILITY OWNER PRIOR TO RECONSTRUCTION AND/OR PAVING OPERATIONS.
7. REPAIR DISTURBED PAVED SURFACES AT THE END OF EACH WORK WEEK, UNLESS OTHERWISE APPROVED/REQUIRED BY THE OWNER.
8. PLACE TEMPORARY BITUMINOUS CONCRETE PAVEMENT AT DISTURBED PORTLAND CEMENT CONCRETE SIDEWALKS AND DRIVEWAYS AT THE END OF EACH WORK WEEK.
9. TRANSFER ALL TEMPORARY BENCHMARKS, AS NECESSARY.
10. ACCOMMODATE PEDESTRIAN TRAFFIC WHERE A SIDEWALK IS TO BE CLOSED FOR SAFETY.
11. RESTORE ALL AREAS DISTURBED BY THE CONTRACTOR BEYOND THE PAYLINE LIMITS TO ORIGINAL CONDITIONS AT NO ADDITIONAL COST TO THE OWNER.
12. REGRADE ALL UNPAVED AREAS DISTURBED BY THE WORK AS REQUIRED.
13. PROVIDE A SMOOTH, FLUSH TRANSITION BETWEEN ALL NEW AND EXISTING PAVEMENTS AND WALKING SURFACES.

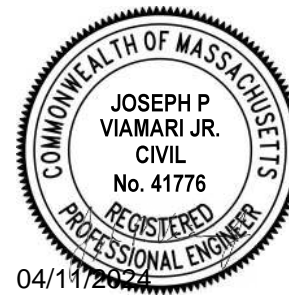

Stevens Mill Sewer and Sidewalk Replacement Project

Town of Dudley

Dudley, MA




Table with 2 columns and 10 rows, likely a revision or schedule table.

Table with 3 columns: MARK, DATE, DESCRIPTION. Includes project number D5011-018, date 04/2024, and drawing cover.dwg.

GENERAL NOTES

SCALE: NO SCALE

G-003

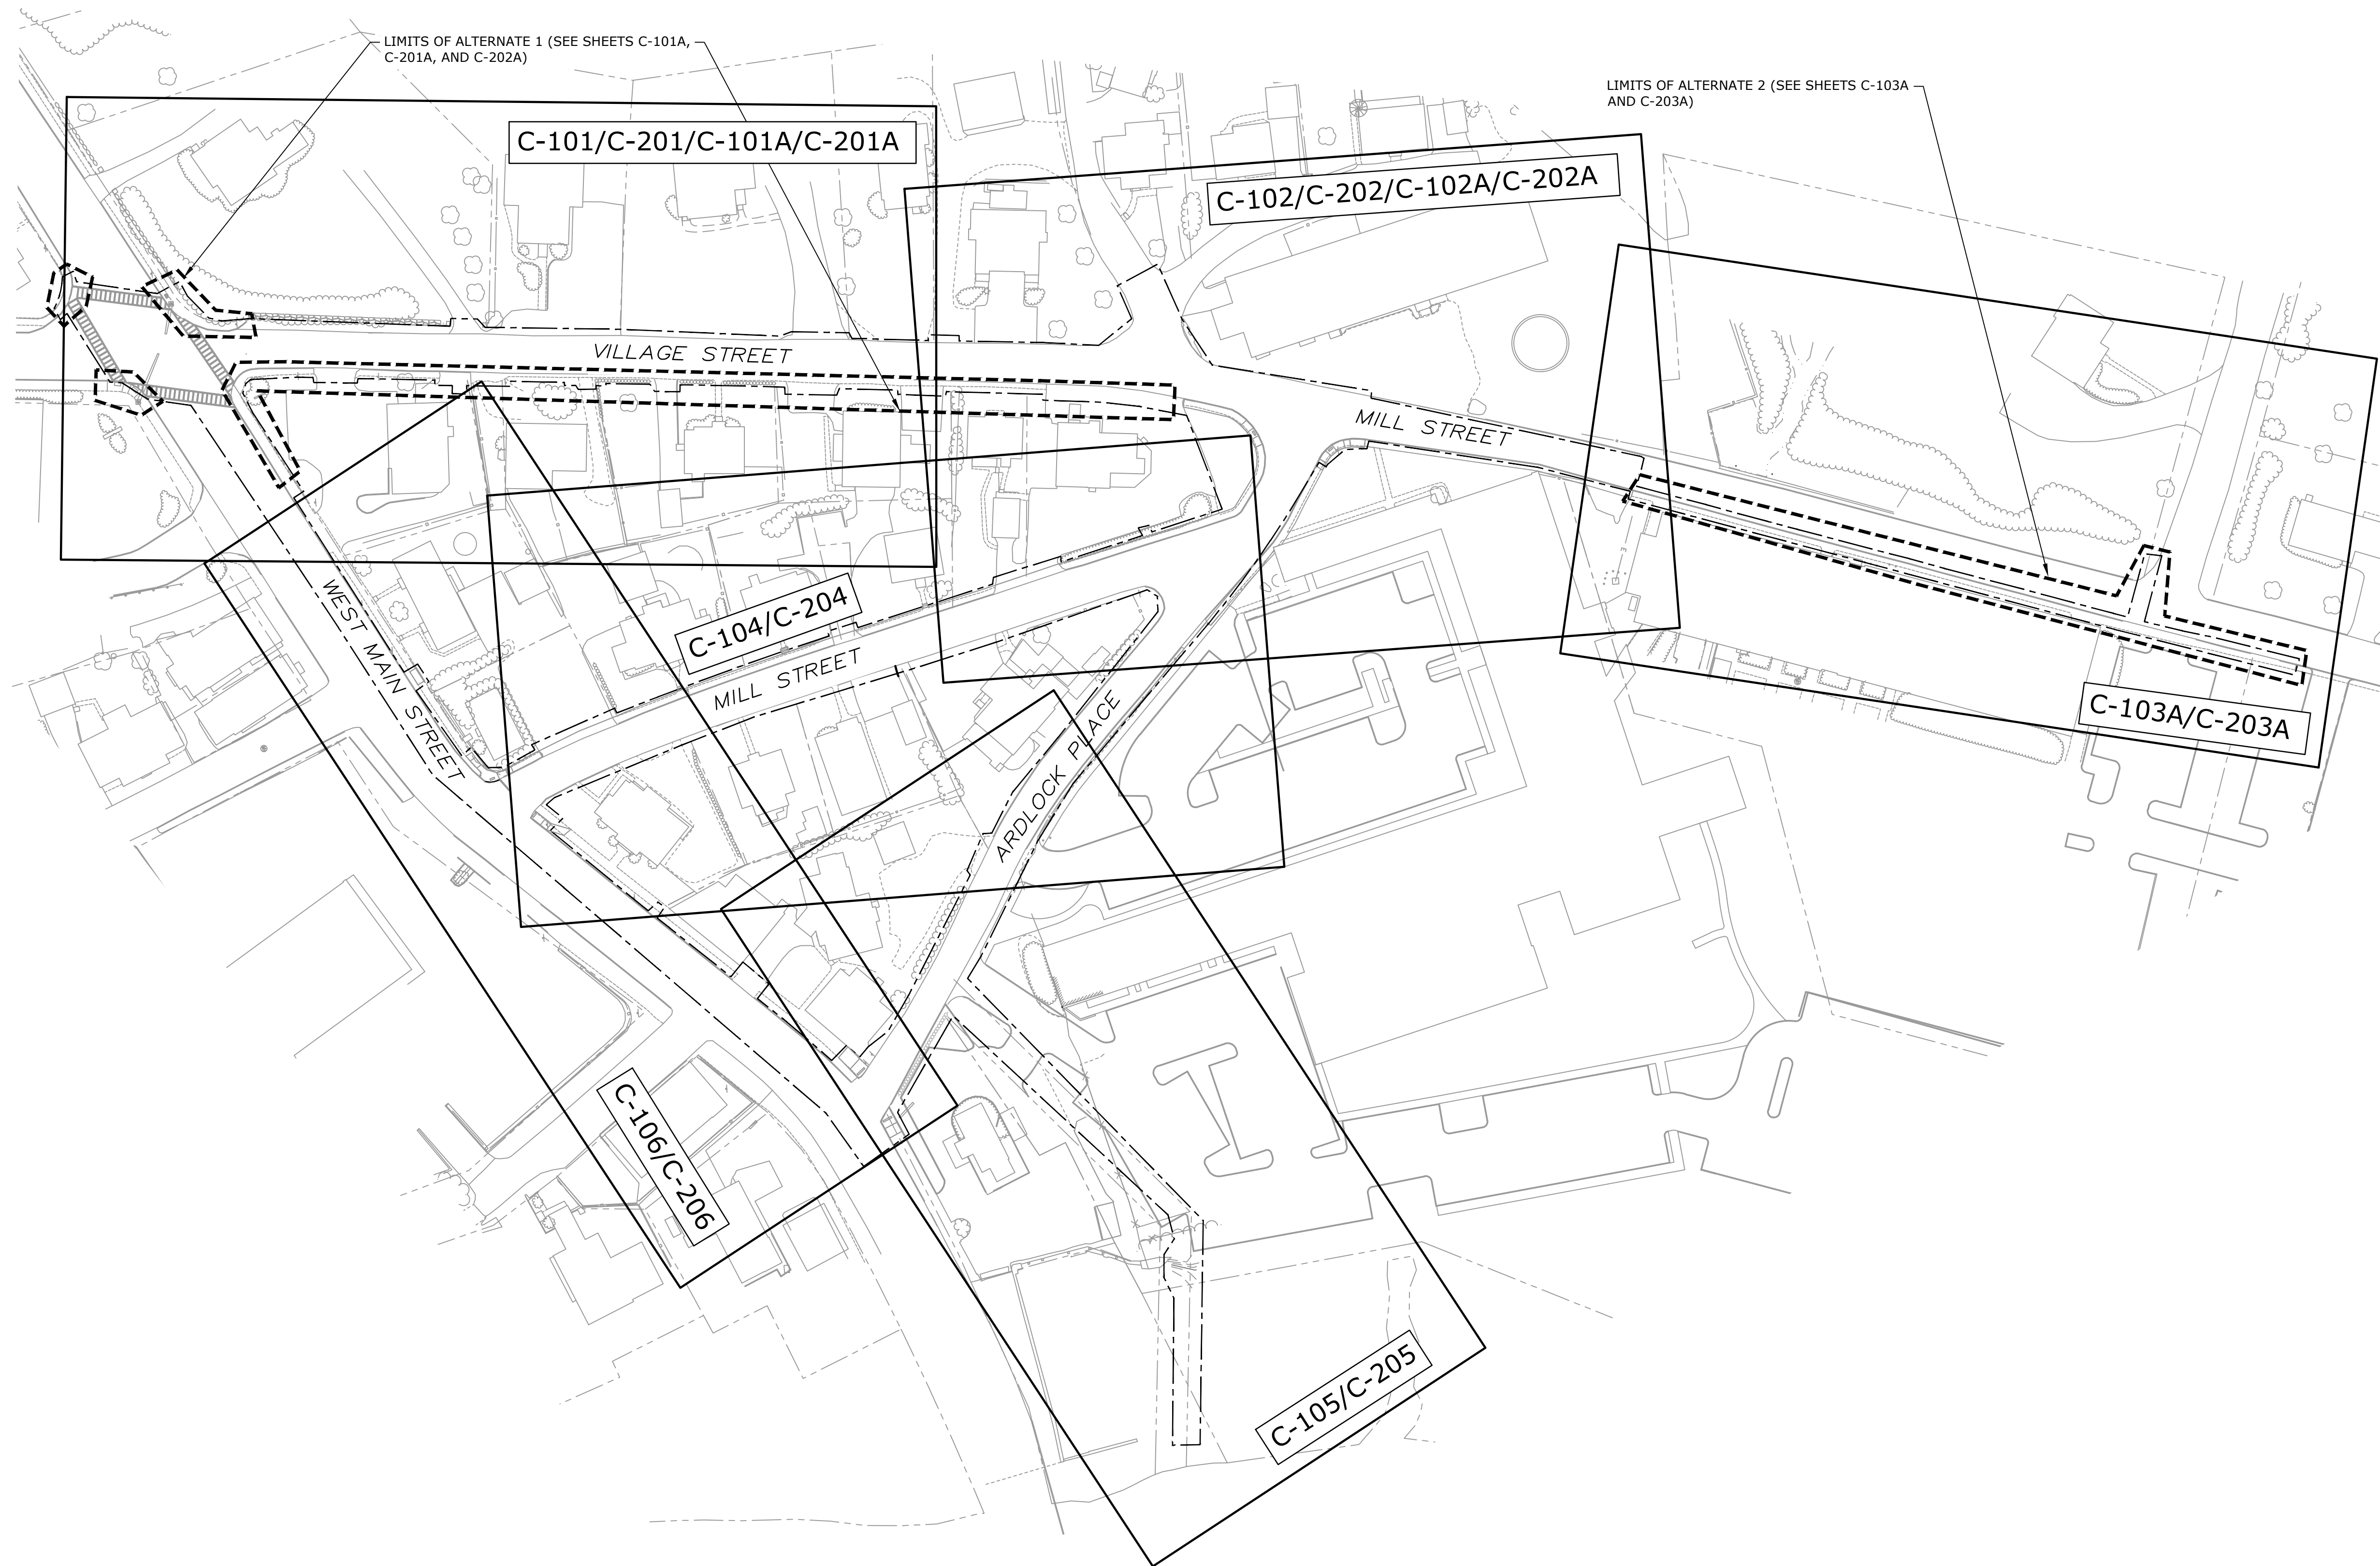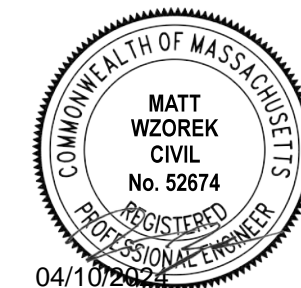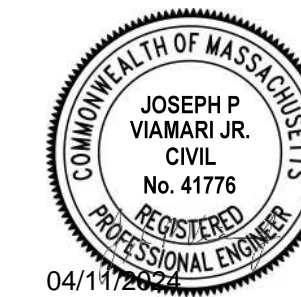

**LEGEND**

C-###

PLAN SHEET

----- APPROX LIMITS OF BASE BID WORK

----- APPROX LIMITS OF ALTERNATE WORK

**Stevens Mill Sewer and Sidewalk Replacement Project**


Town of Dudley

Dudley, MA





0	04/10/2024	ISSUED FOR BIDDING
MARK	DATE	DESCRIPTION
PROJECT NO:		D5011-018
DATE:		04/2024
FILE:		D5011-018 ExeCn.dwg
DRAWN BY:		ND/ABS
CHECKED BY:		MPW
APPROVED BY:		JPV

OVERALL SITE PLAN

SCALE: AS SHOWN

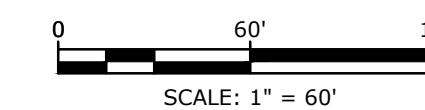

**C-100**

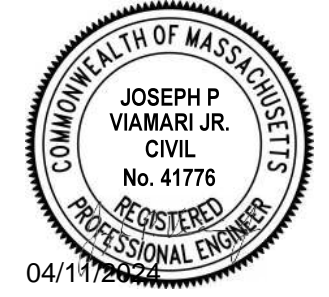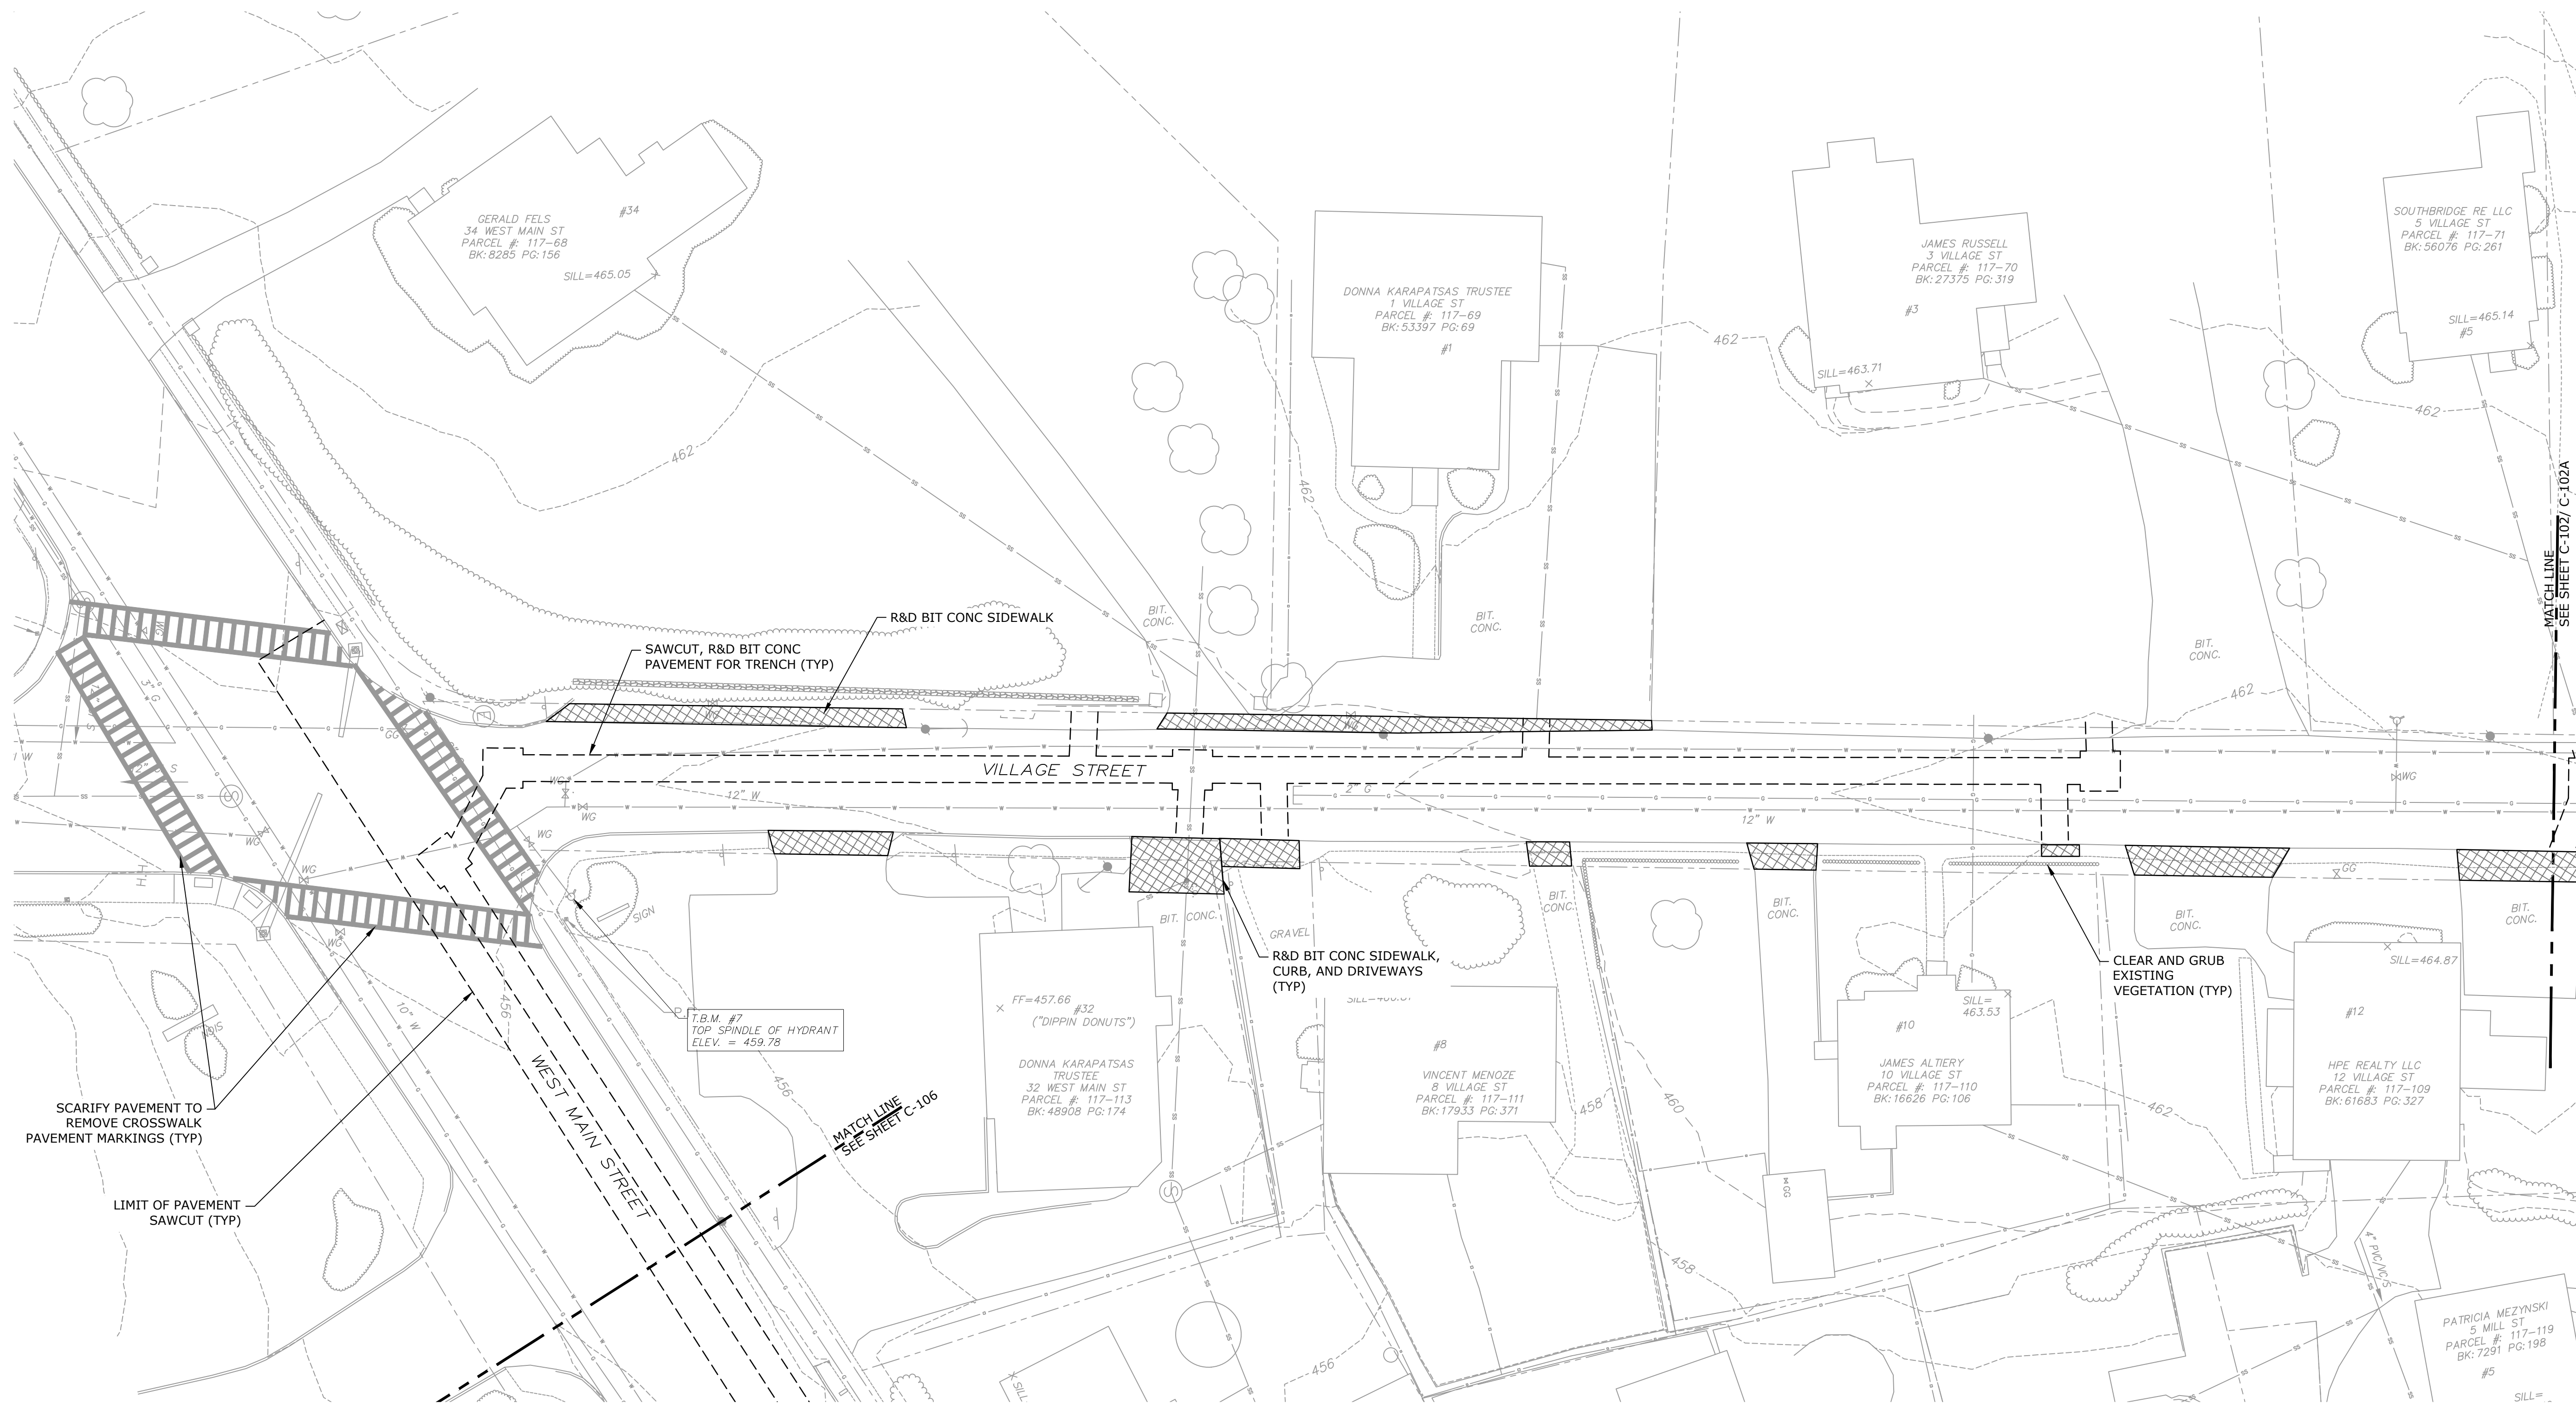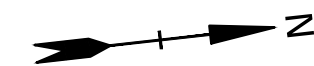

### Stevens Mill Sewer and Sidewalk Replacement Project


Town of Dudley

Dudley, MA





0	04/10/2024	ISSUED FOR BIDDING
MARK	DATE	DESCRIPTION
PROJECT NO:	D5011-018	
DATE:	04/2024	
FILE:	D5011-018 ExeCn.dwg	
DRAWN BY:	ND/ABS	
CHECKED BY:	MPW	
APPROVED BY:	JPV	

EXISTING CONDITIONS AND DEMOLITION PLAN - 1

SCALE: AS SHOWN

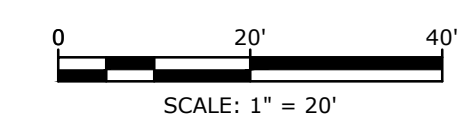

Last Saved: 4/9/2024 11:53am By: NBay  
Plotted On: Apr 10, 2024 11:53am By: NBay  
Figure & Legend: 3, 10, D5011 1 Drawing 02 Stevens Mill Sewer and Sidewalk Replacement - Figures AutoCAD Sheet D5011\_018 ExeCn.dwg

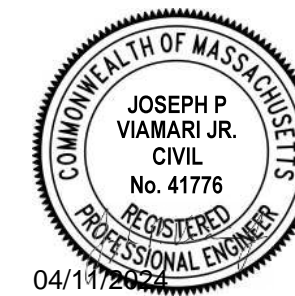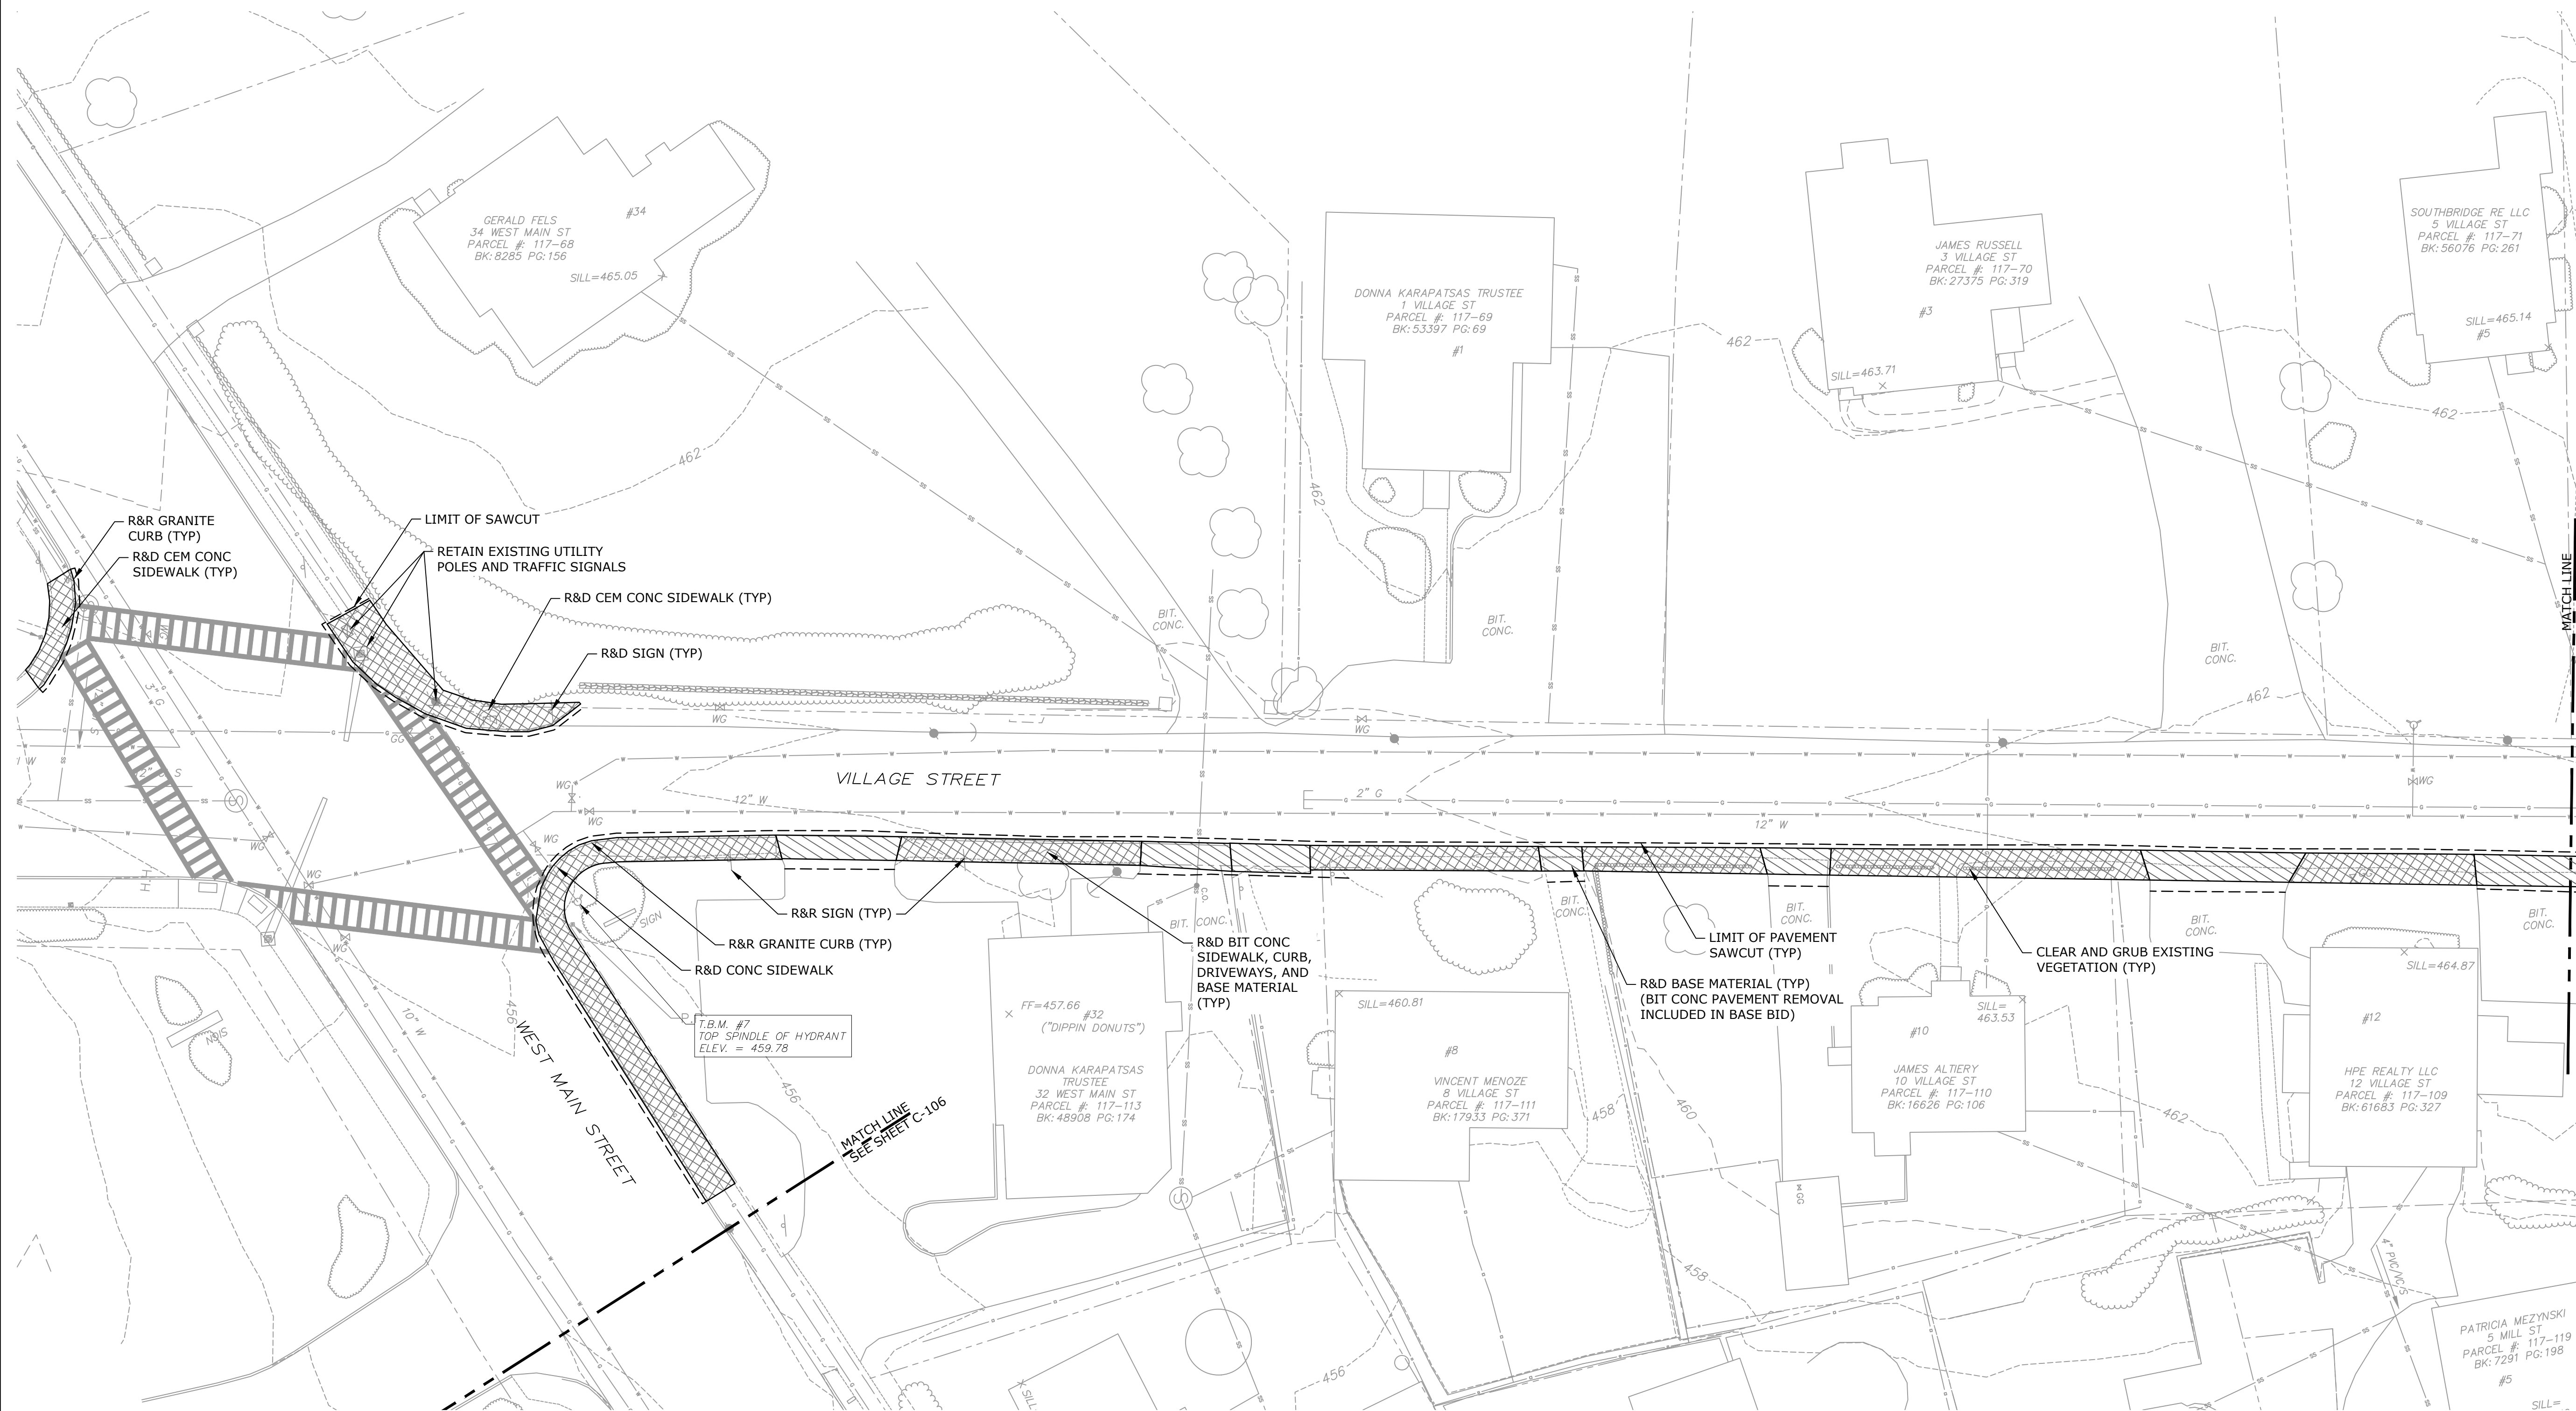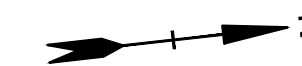

**Stevens Mill  
Sewer and  
Sidewalk  
Replacement  
Project**

Town of Dudley

Dudley, MA


- NOTE**
1. ALL WORK SHOWN ON THIS SHEET IS TO BE INCLUDED IN BID ALTERNATE 1.

MARK	DATE	DESCRIPTION
0	04/10/2024	ISSUED FOR BIDDING

PROJECT NO: D5011-018  
 DATE: 04/2024  
 FILE: D5011-018 ExeCn.dwg  
 DRAWN BY: ND/ABS  
 CHECKED BY: MPW  
 APPROVED BY: JPV




EXISTING CONDITIONS AND DEMOLITION PLAN - 1 ALTERNATE 1 SCOPE

SCALE: AS SHOWN

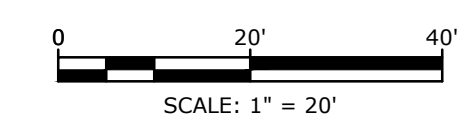

**C-101A**

Last Saved: 4/9/2024 11:53am By: NWay  
 Plotted On: Apr 10, 2024 11:53am By: SWay  
 File & Save Path: D:\Projects\2024\11-D5011-Dudley\10-Stevens Mill\MassWorks\Drawings\_Figures\AutoCAD\Sheet\DS011\_018\_ExcCn.dwg

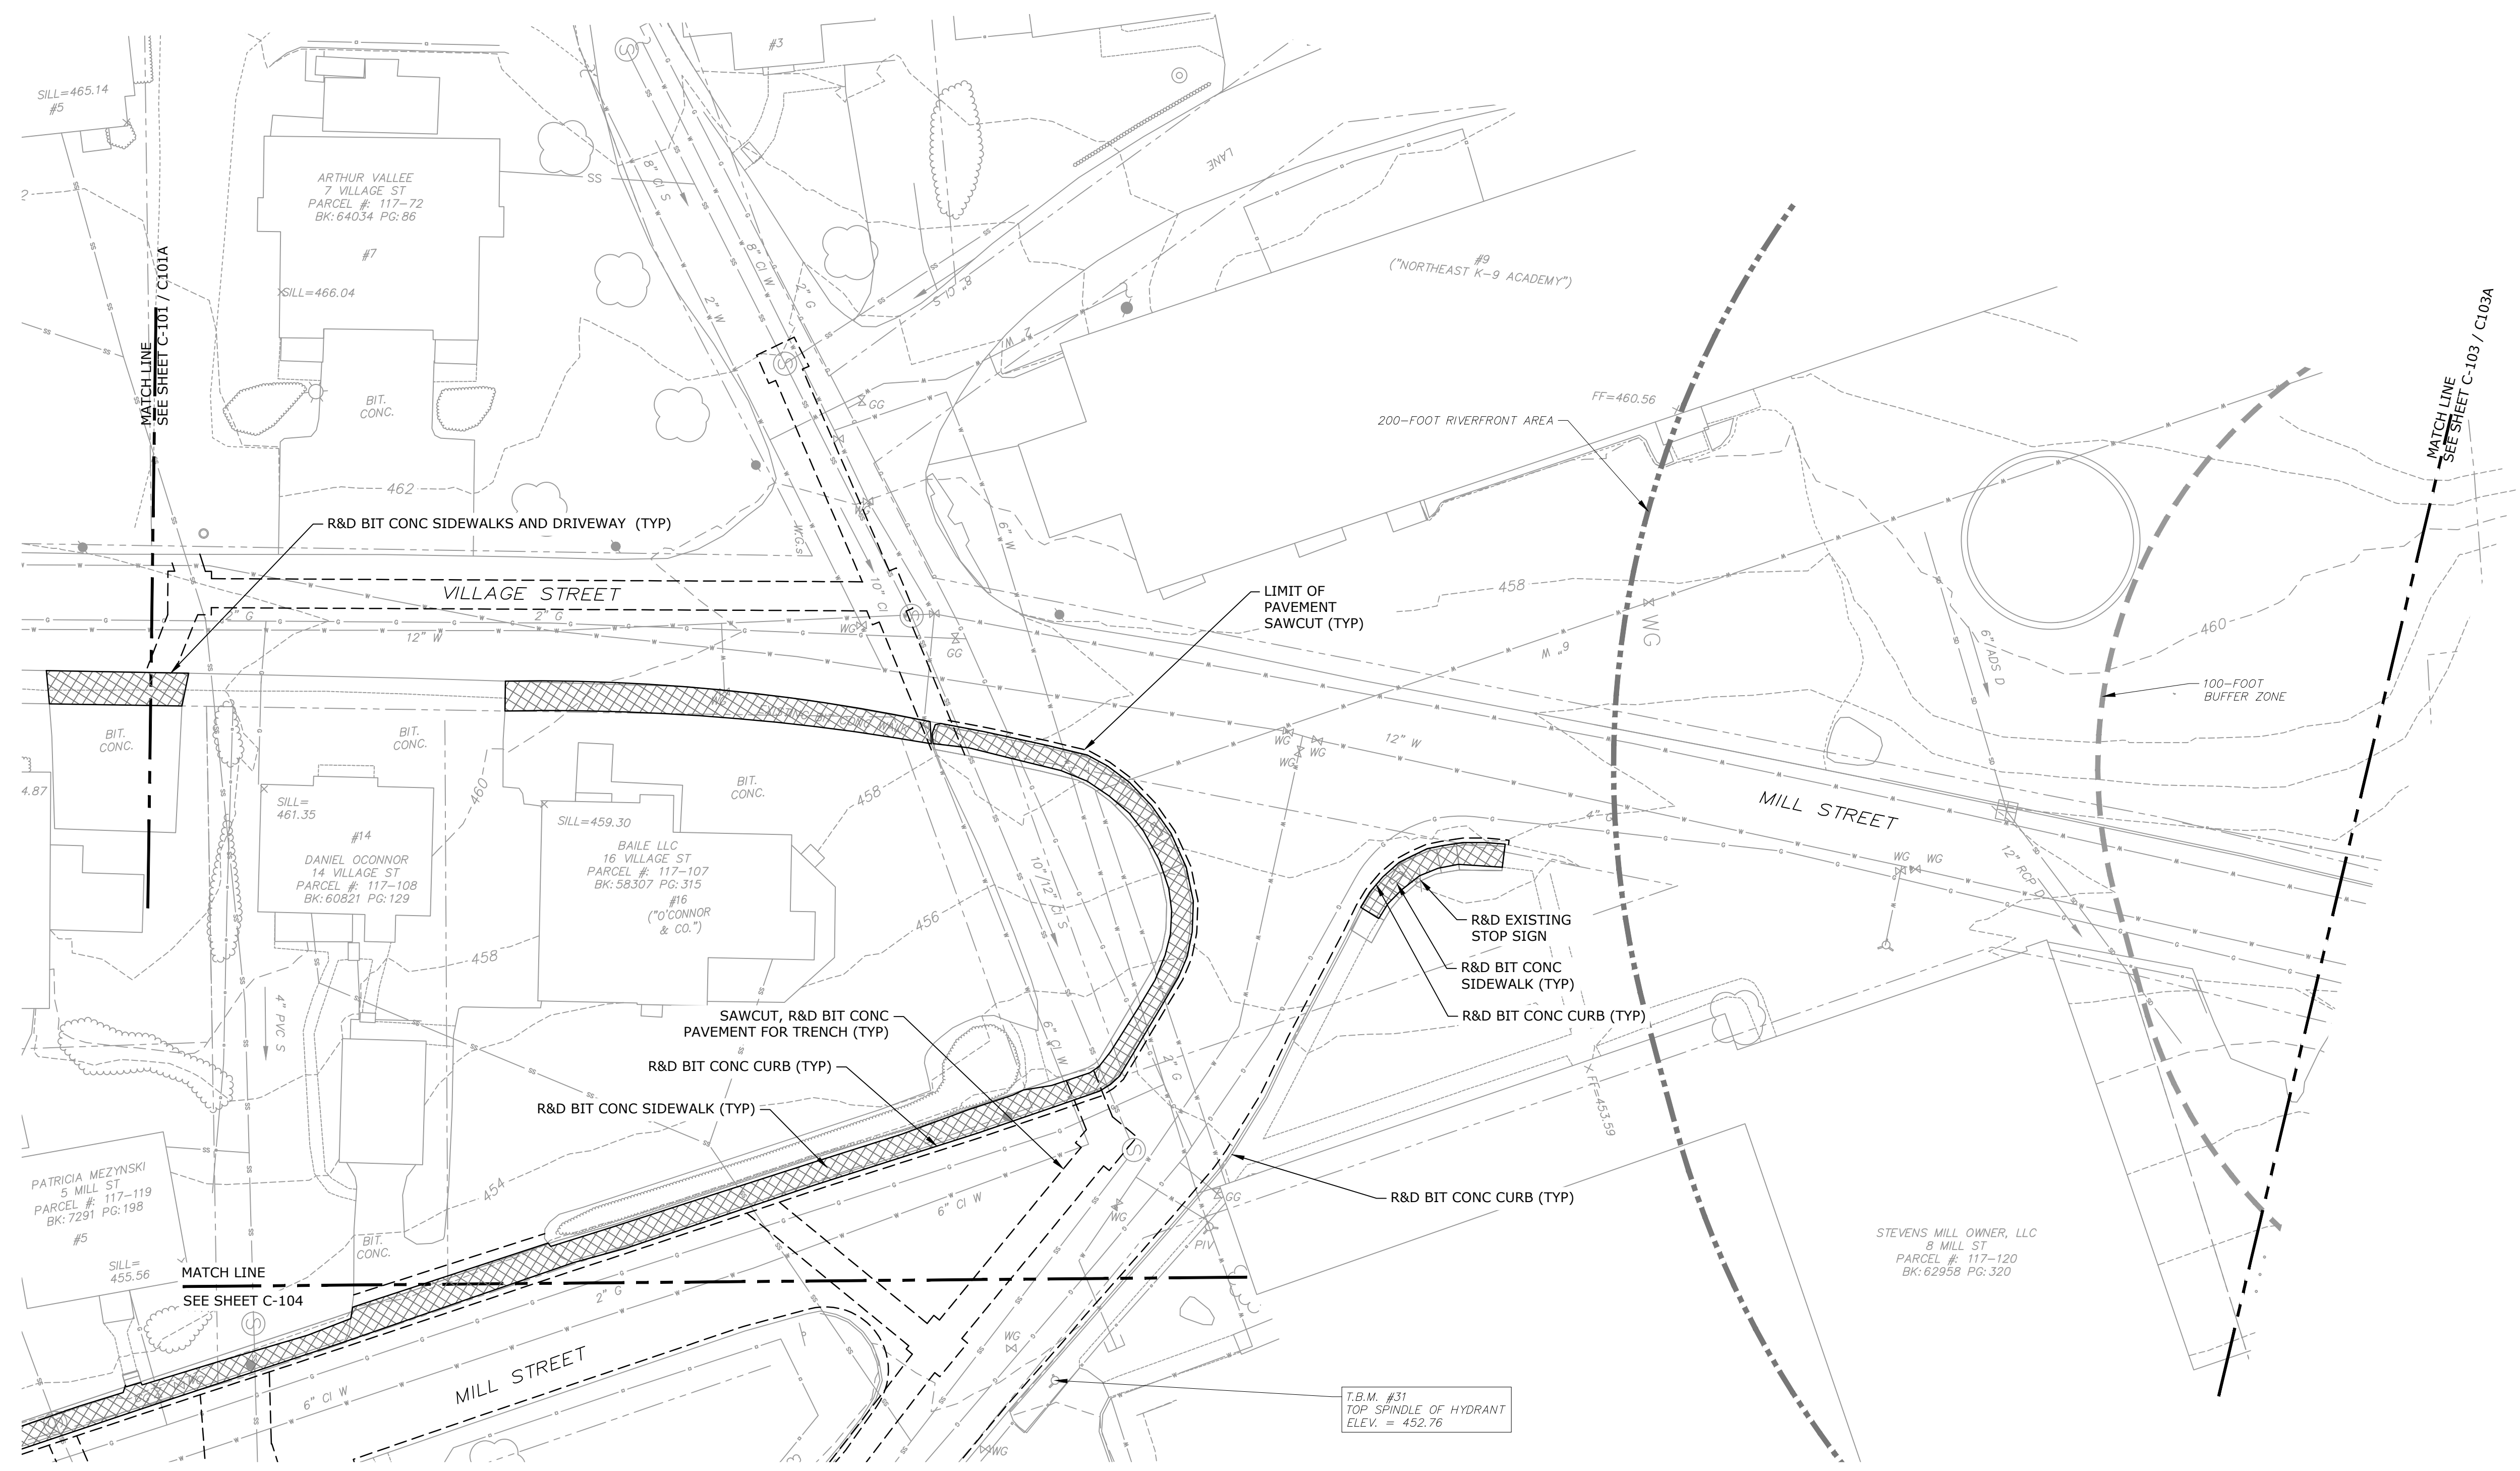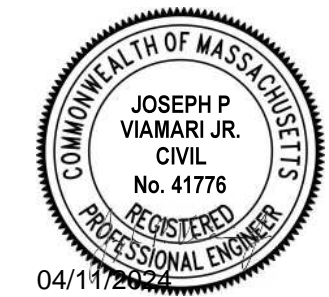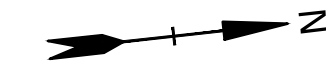

**Stevens Mill  
Sewer and  
Sidewalk  
Replacement  
Project**

Town of Dudley


Dudley, MA

MARK	DATE	DESCRIPTION
0	04/10/2024	ISSUED FOR BIDDING

PROJECT NO: D5011-018  
 DATE: 04/2024  
 FILE: D5011-018 ExeCn.dwg  
 DRAWN BY: ND/ABS  
 CHECKED BY: MPW  
 APPROVED BY: JPV



EXISTING CONDITIONS AND  
DEMOLITION PLAN - 2

SCALE: AS SHOWN

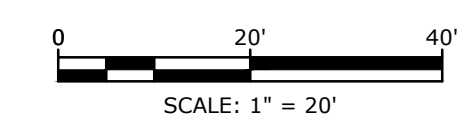

**C-102**

Last Saved: 4/9/2024 11:53am By: NBay  
 Plotted On: Apr 10, 2024 11:53am By: NBay  
 Figure & Legend: 3:10:05:211 Dudley 0211 Stevens Mill MassWorksDrawings\_FiguresAutoCAD\_SheetD5011-018\_Exec.dwg

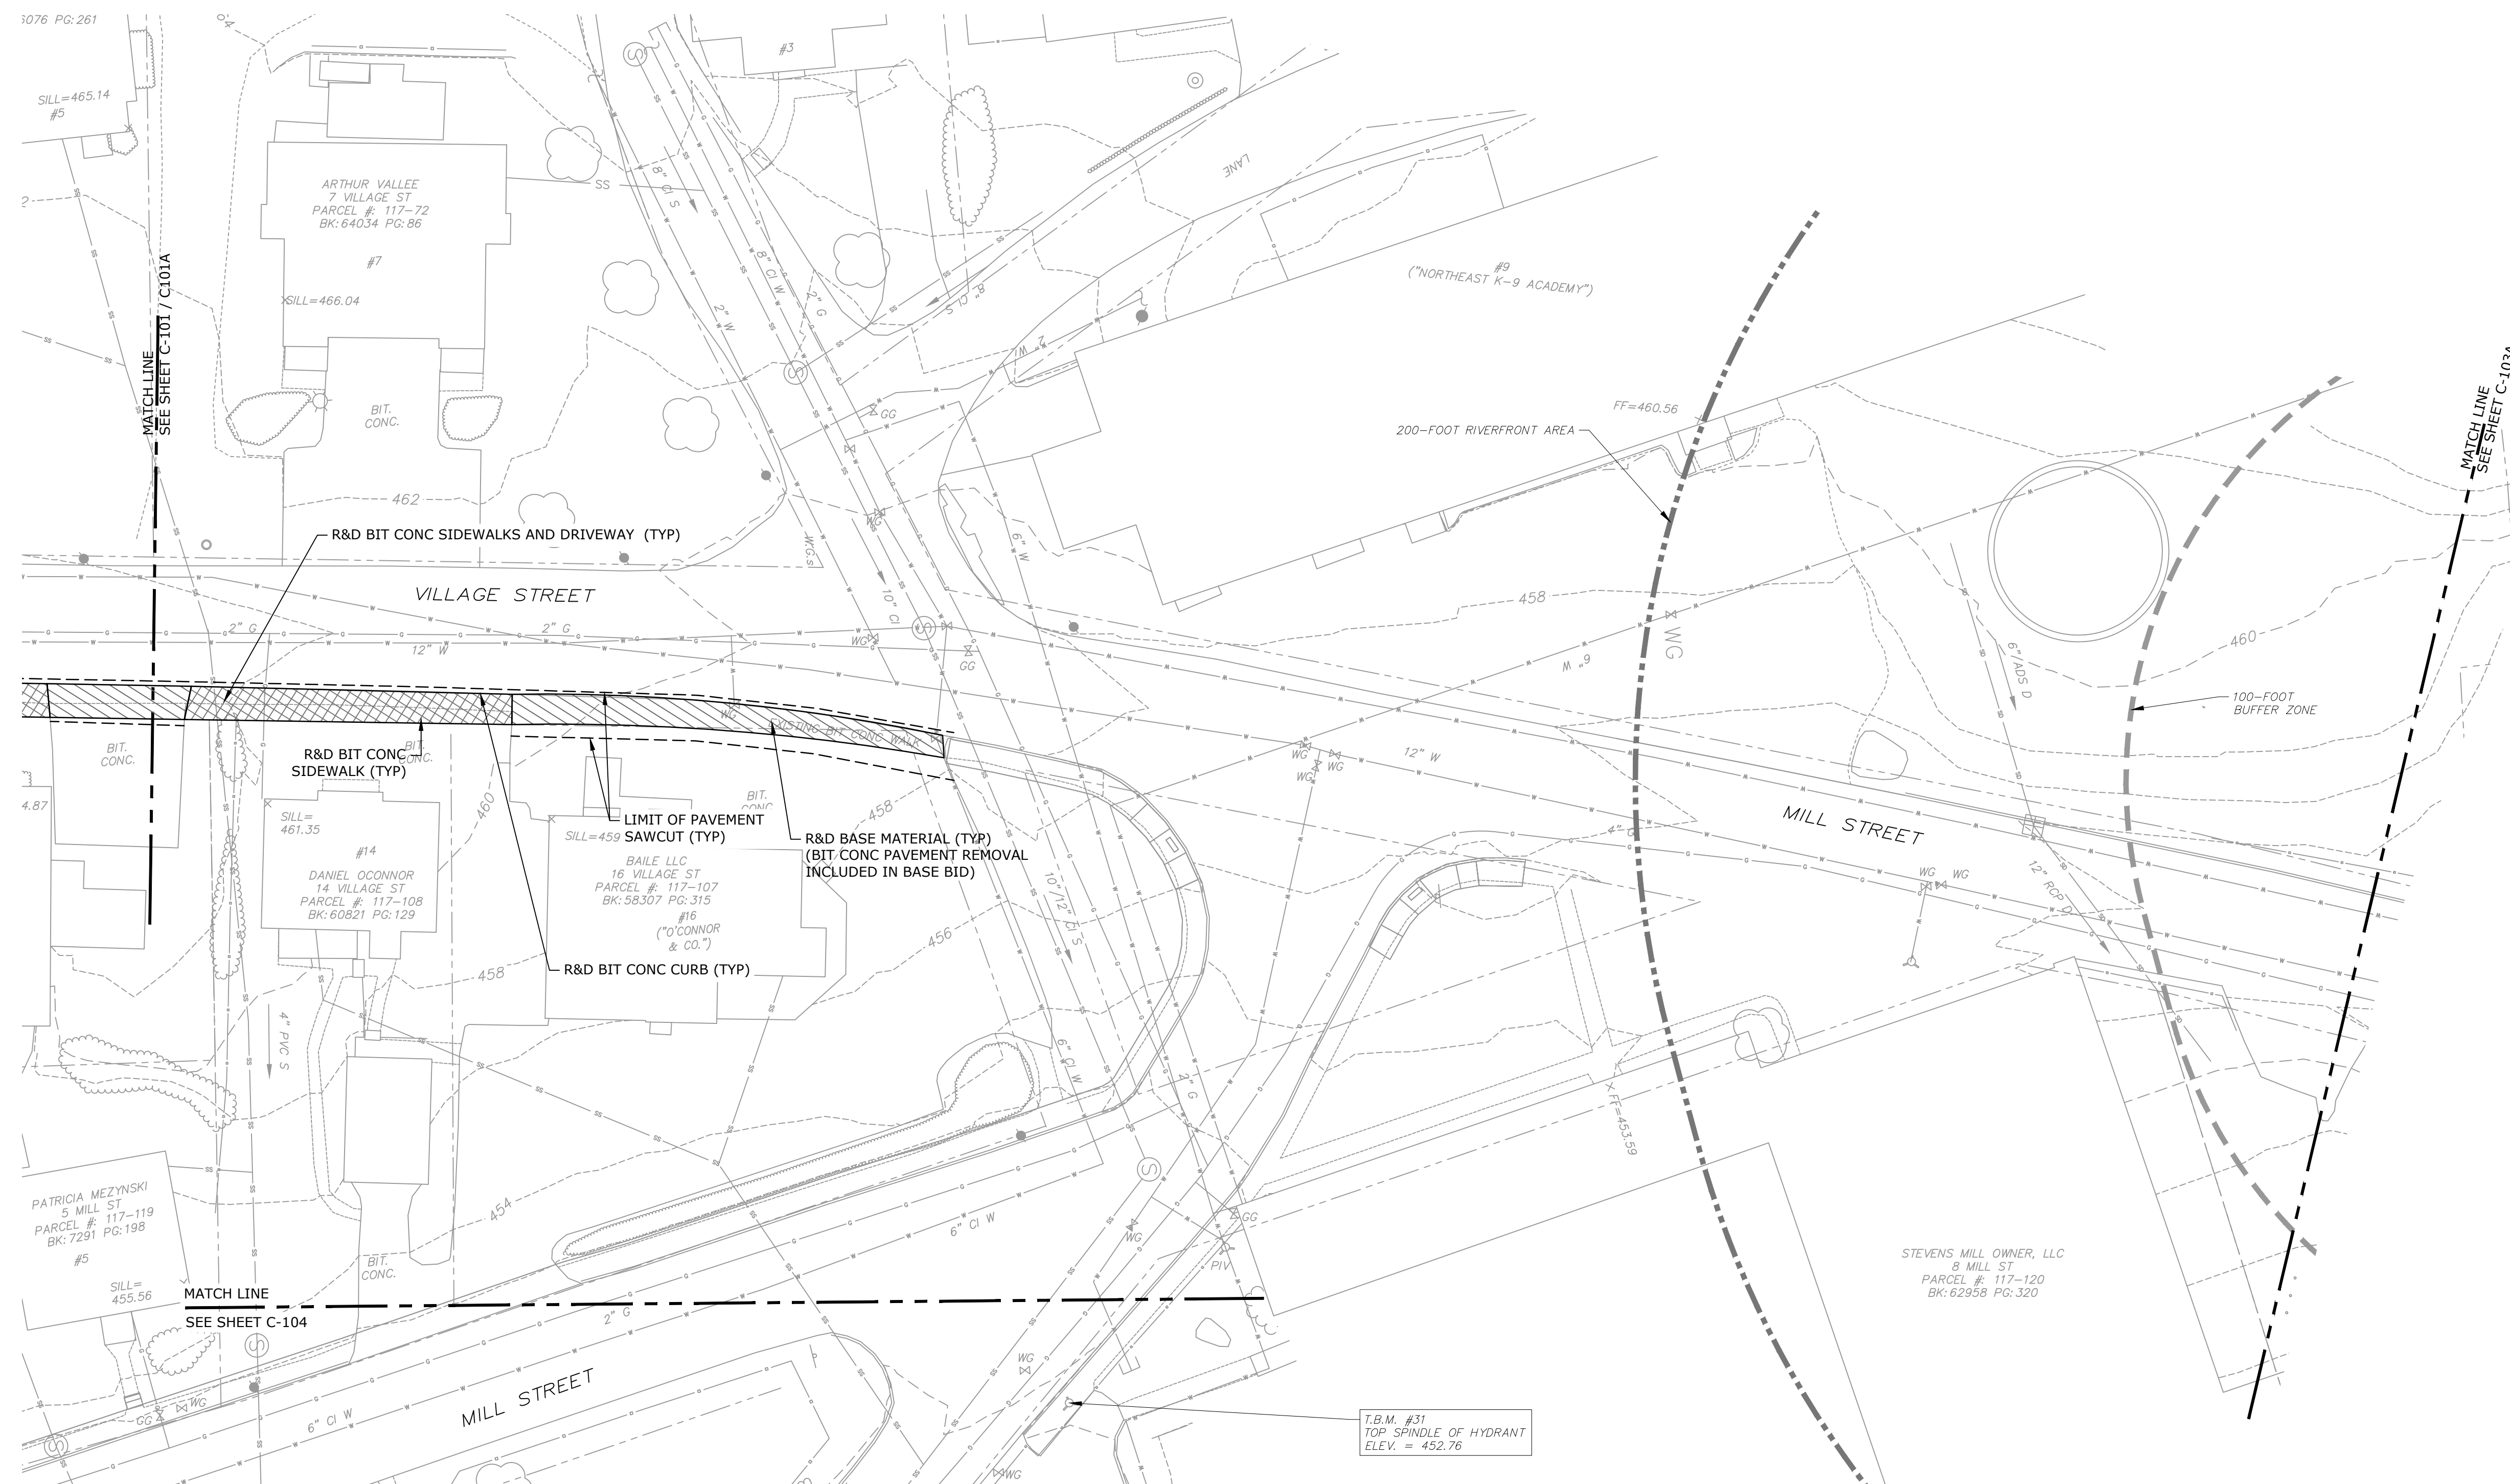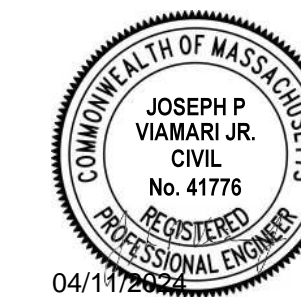


**NOTE**  
 1. ALL WORK SHOWN ON THIS SHEET IS TO BE INCLUDED IN BID ALTERNATE 1.

**Stevens Mill  
 Sewer and  
 Sidewalk  
 Replacement  
 Project**

Town of Dudley  
 Dudley, MA




0	04/10/2024	ISSUED FOR BIDDING
MARK	DATE	DESCRIPTION
PROJECT NO: D5011-018		
DATE: 04/2024		
FILE: D5011-018 ExeCn.dwg		
DRAWN BY: ND/ABS		
CHECKED BY: MPW		
APPROVED BY: JPV		
<b>EXISTING CONDITIONS AND DEMOLITION PLAN - 2 ALTERNATE 1 SCOPE</b>		
SCALE:	AS SHOWN	

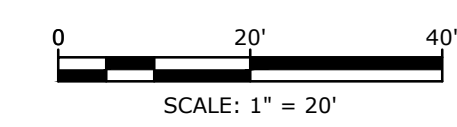

**C-102A**

Last Saved: 4/9/2024 11:54am By: NWay  
 Plotted On: Apr 10, 2024 11:54am By: NWay  
 Figure & Scale: 3:10 D5011-018 Stevens Mill Sewer and Sidewalk Replacement - Figures\AutoCAD\Sheet\DS011-018\_Execn.dwg



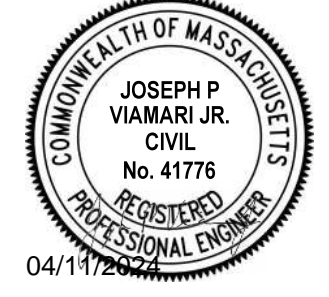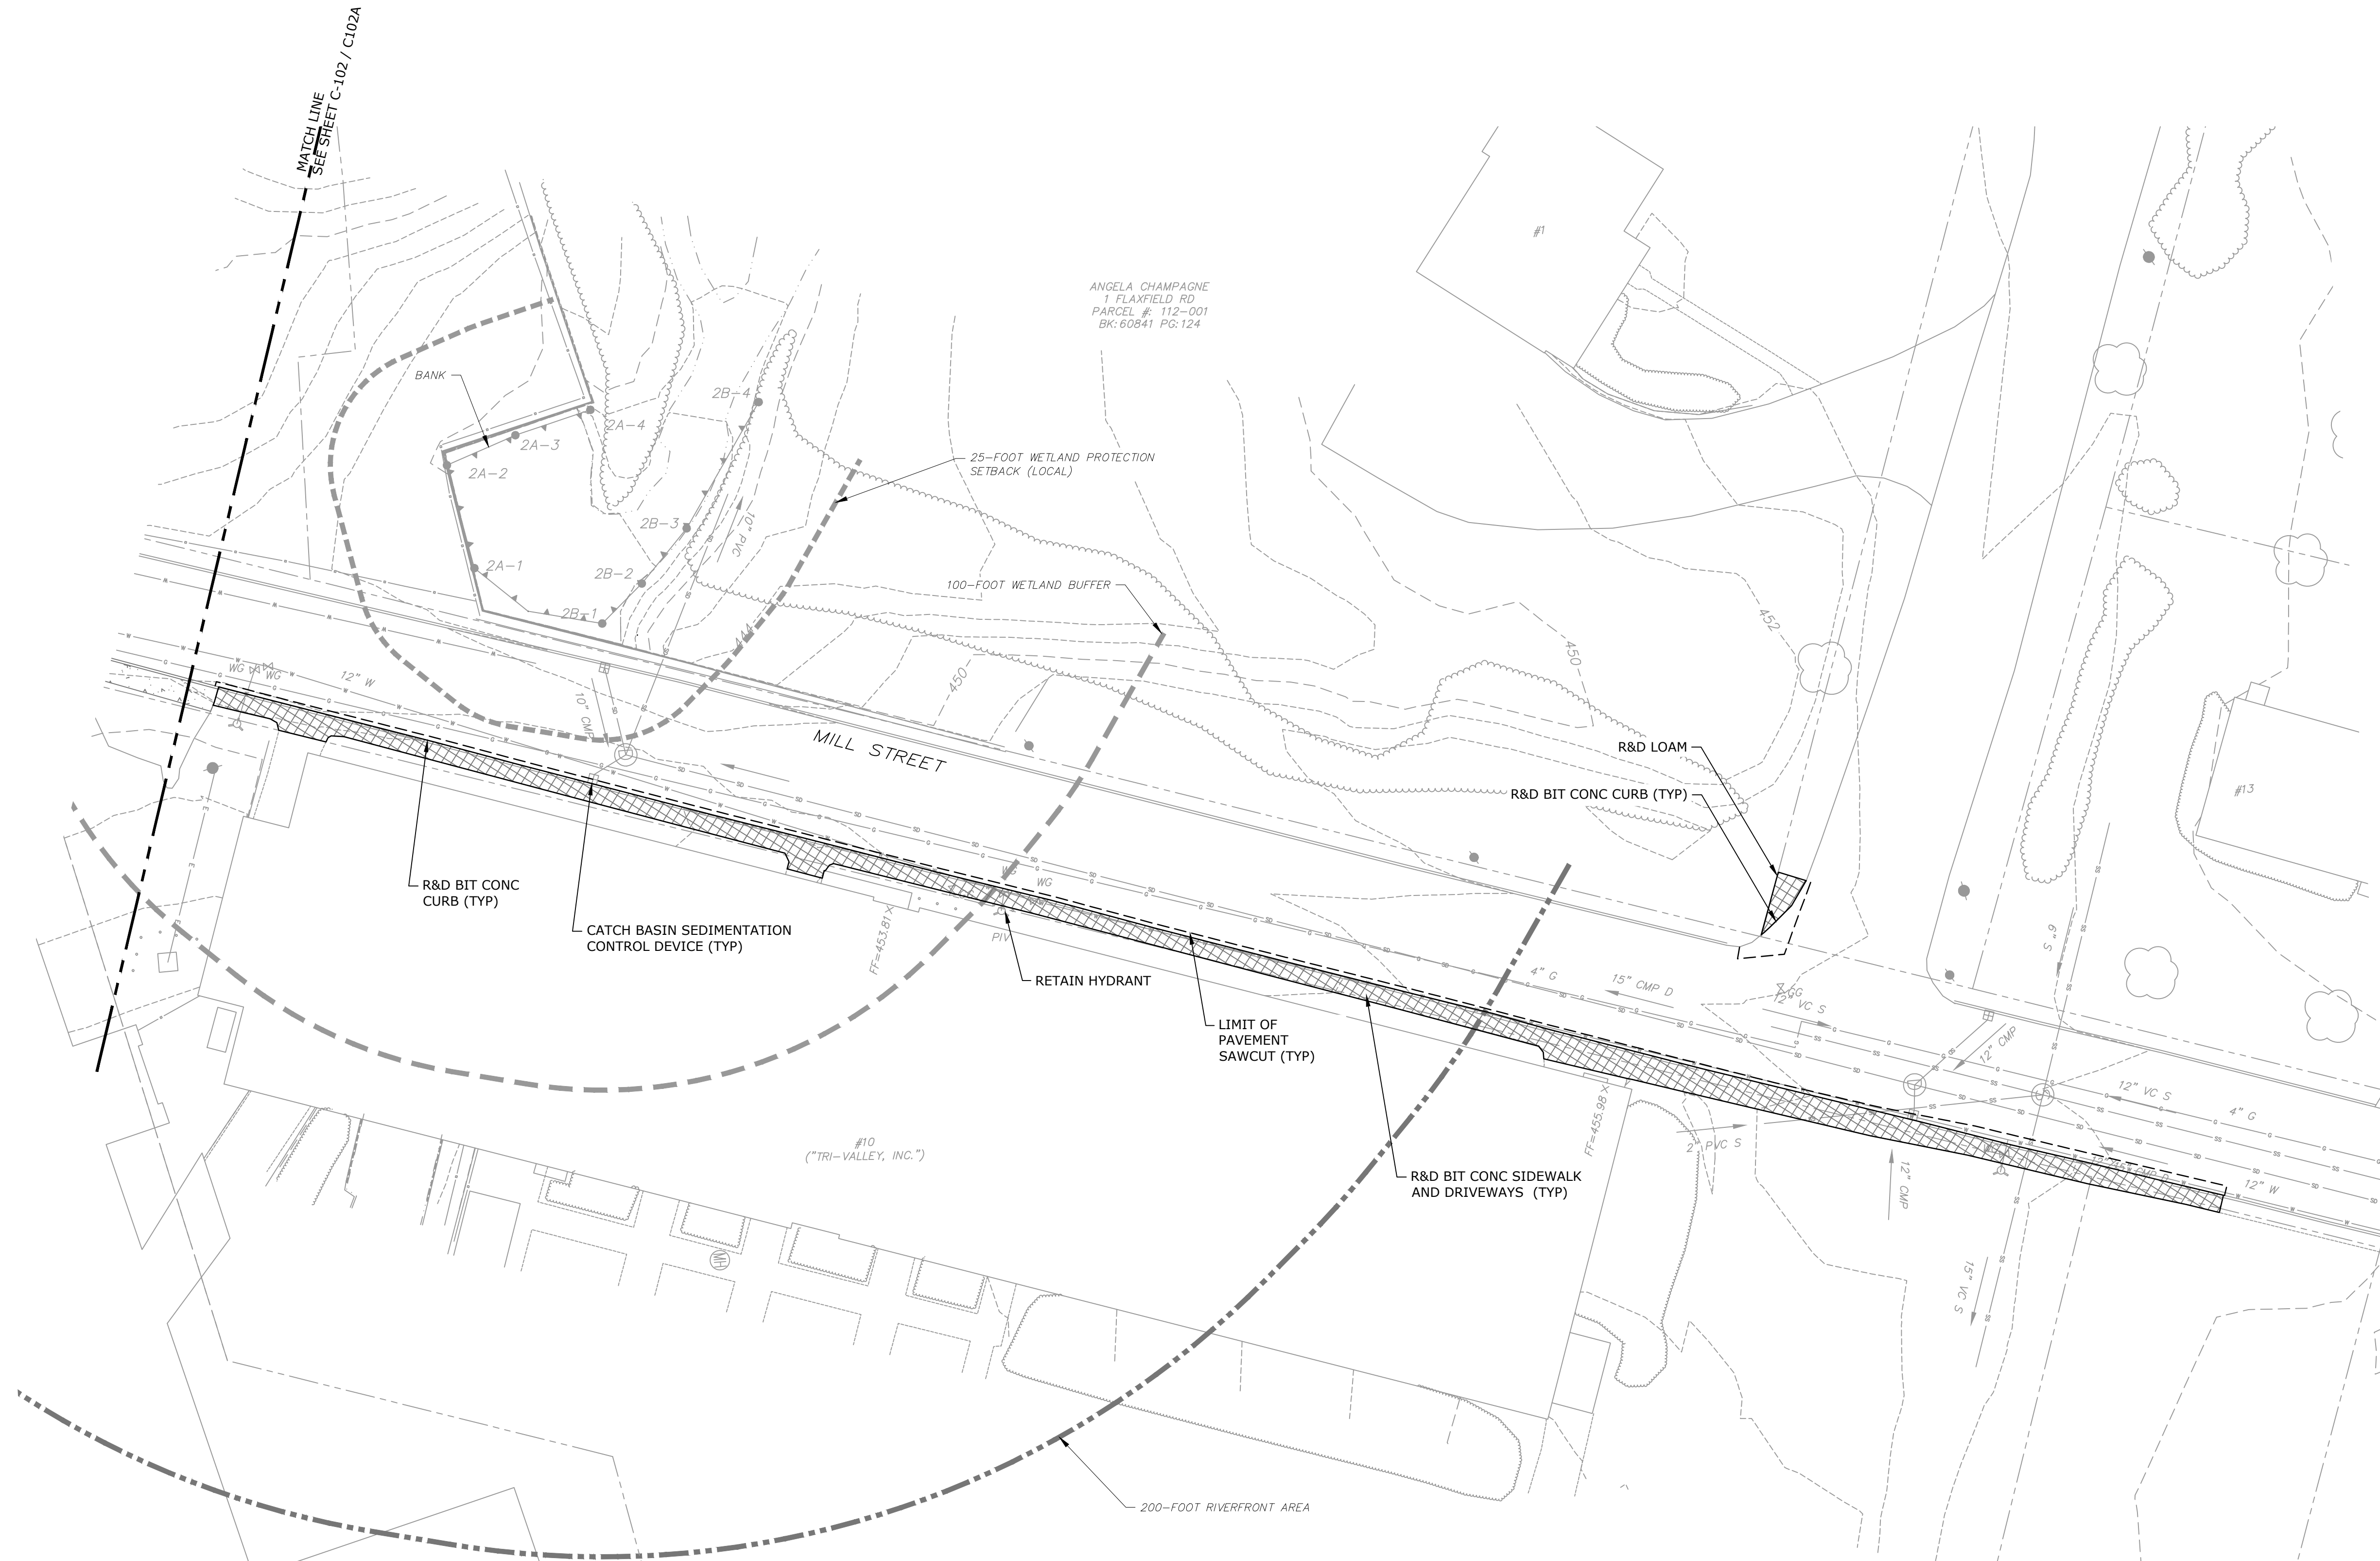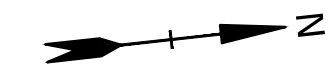

**Stevens Mill Sewer and Sidewalk Replacement Project**


Town of Dudley

Dudley, MA


0	04/10/2024	ISSUED FOR BIDDING
MARK	DATE	DESCRIPTION
PROJECT NO: D5011-018		
DATE: 04/2024		
FILE: D5011-018 ExeCn.dwg		
DRAWN BY: ND/ABS		
CHECKED BY: MPW		
APPROVED BY: JPV		




EXISTING CONDITIONS AND DEMOLITION PLAN - 3 ALTERNATE 2 SCOPE

SCALE: AS SHOWN

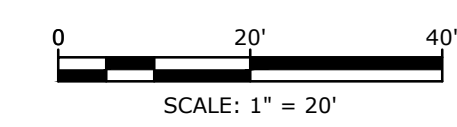

**NOTE**  
1. ALL WORK SHOWN ON THIS SHEET IS TO BE INCLUDED IN BID ALTERNATE 2.

Last Saved: 4/9/2024 11:54am By: NBay  
 Plotted On: Apr 10, 2024 11:54am By: NBay  
 Title & Scale: 3.10.D5011.Dwg Stevens Mill Sewer and Sidewalk Replacement - Figures\AutoCAD\Sheet\DS011\_018\_Execn.dwg

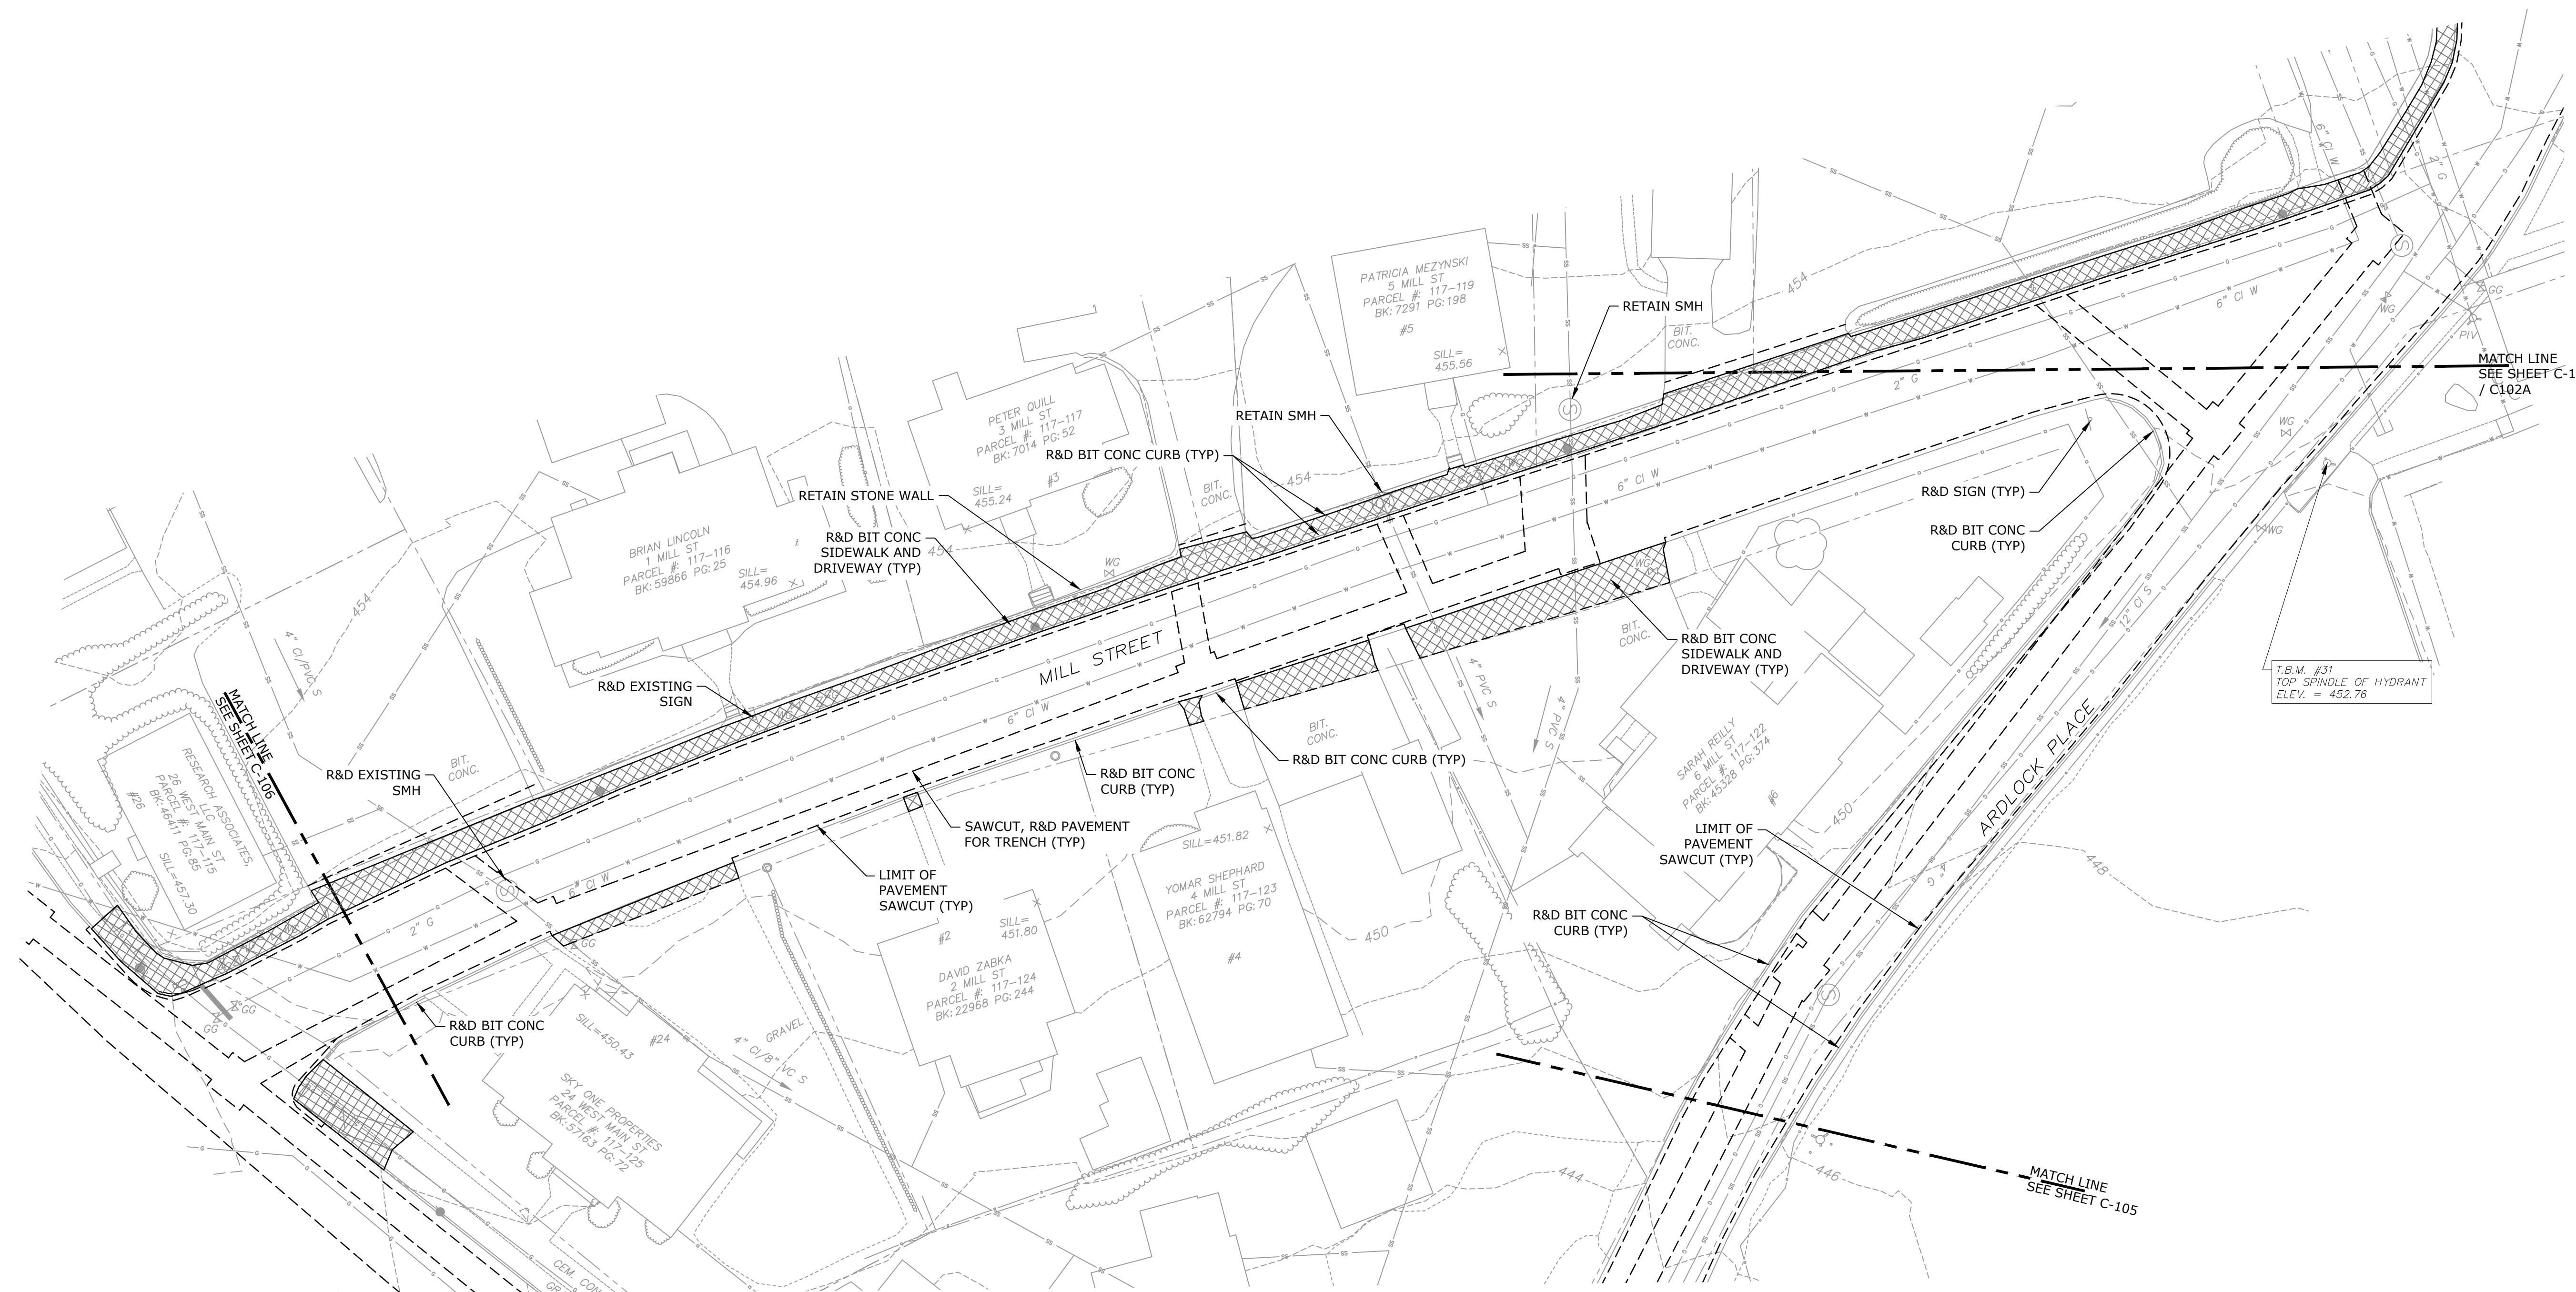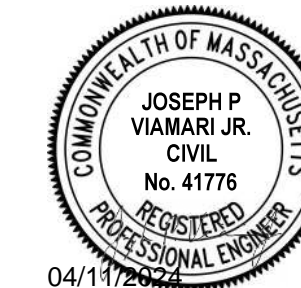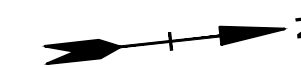

T.B.M. #31  
TOP SPINDLE OF HYDRANT  
ELEV. = 452.76

**Stevens Mill  
Sewer and  
Sidewalk  
Replacement  
Project**

Town of Dudley

Dudley, MA





0	04/10/2024	ISSUED FOR BIDDING
MARK	DATE	DESCRIPTION
PROJECT NO: D5011-018		
DATE: 04/2024		
FILE: D5011-018 ExeCn.dwg		
DRAWN BY: ND/ABS		
CHECKED BY: MPW		
APPROVED BY: JPV		

EXISTING CONDITIONS AND  
DEMOLITION PLAN - 4

SCALE: AS SHOWN



**C-104**

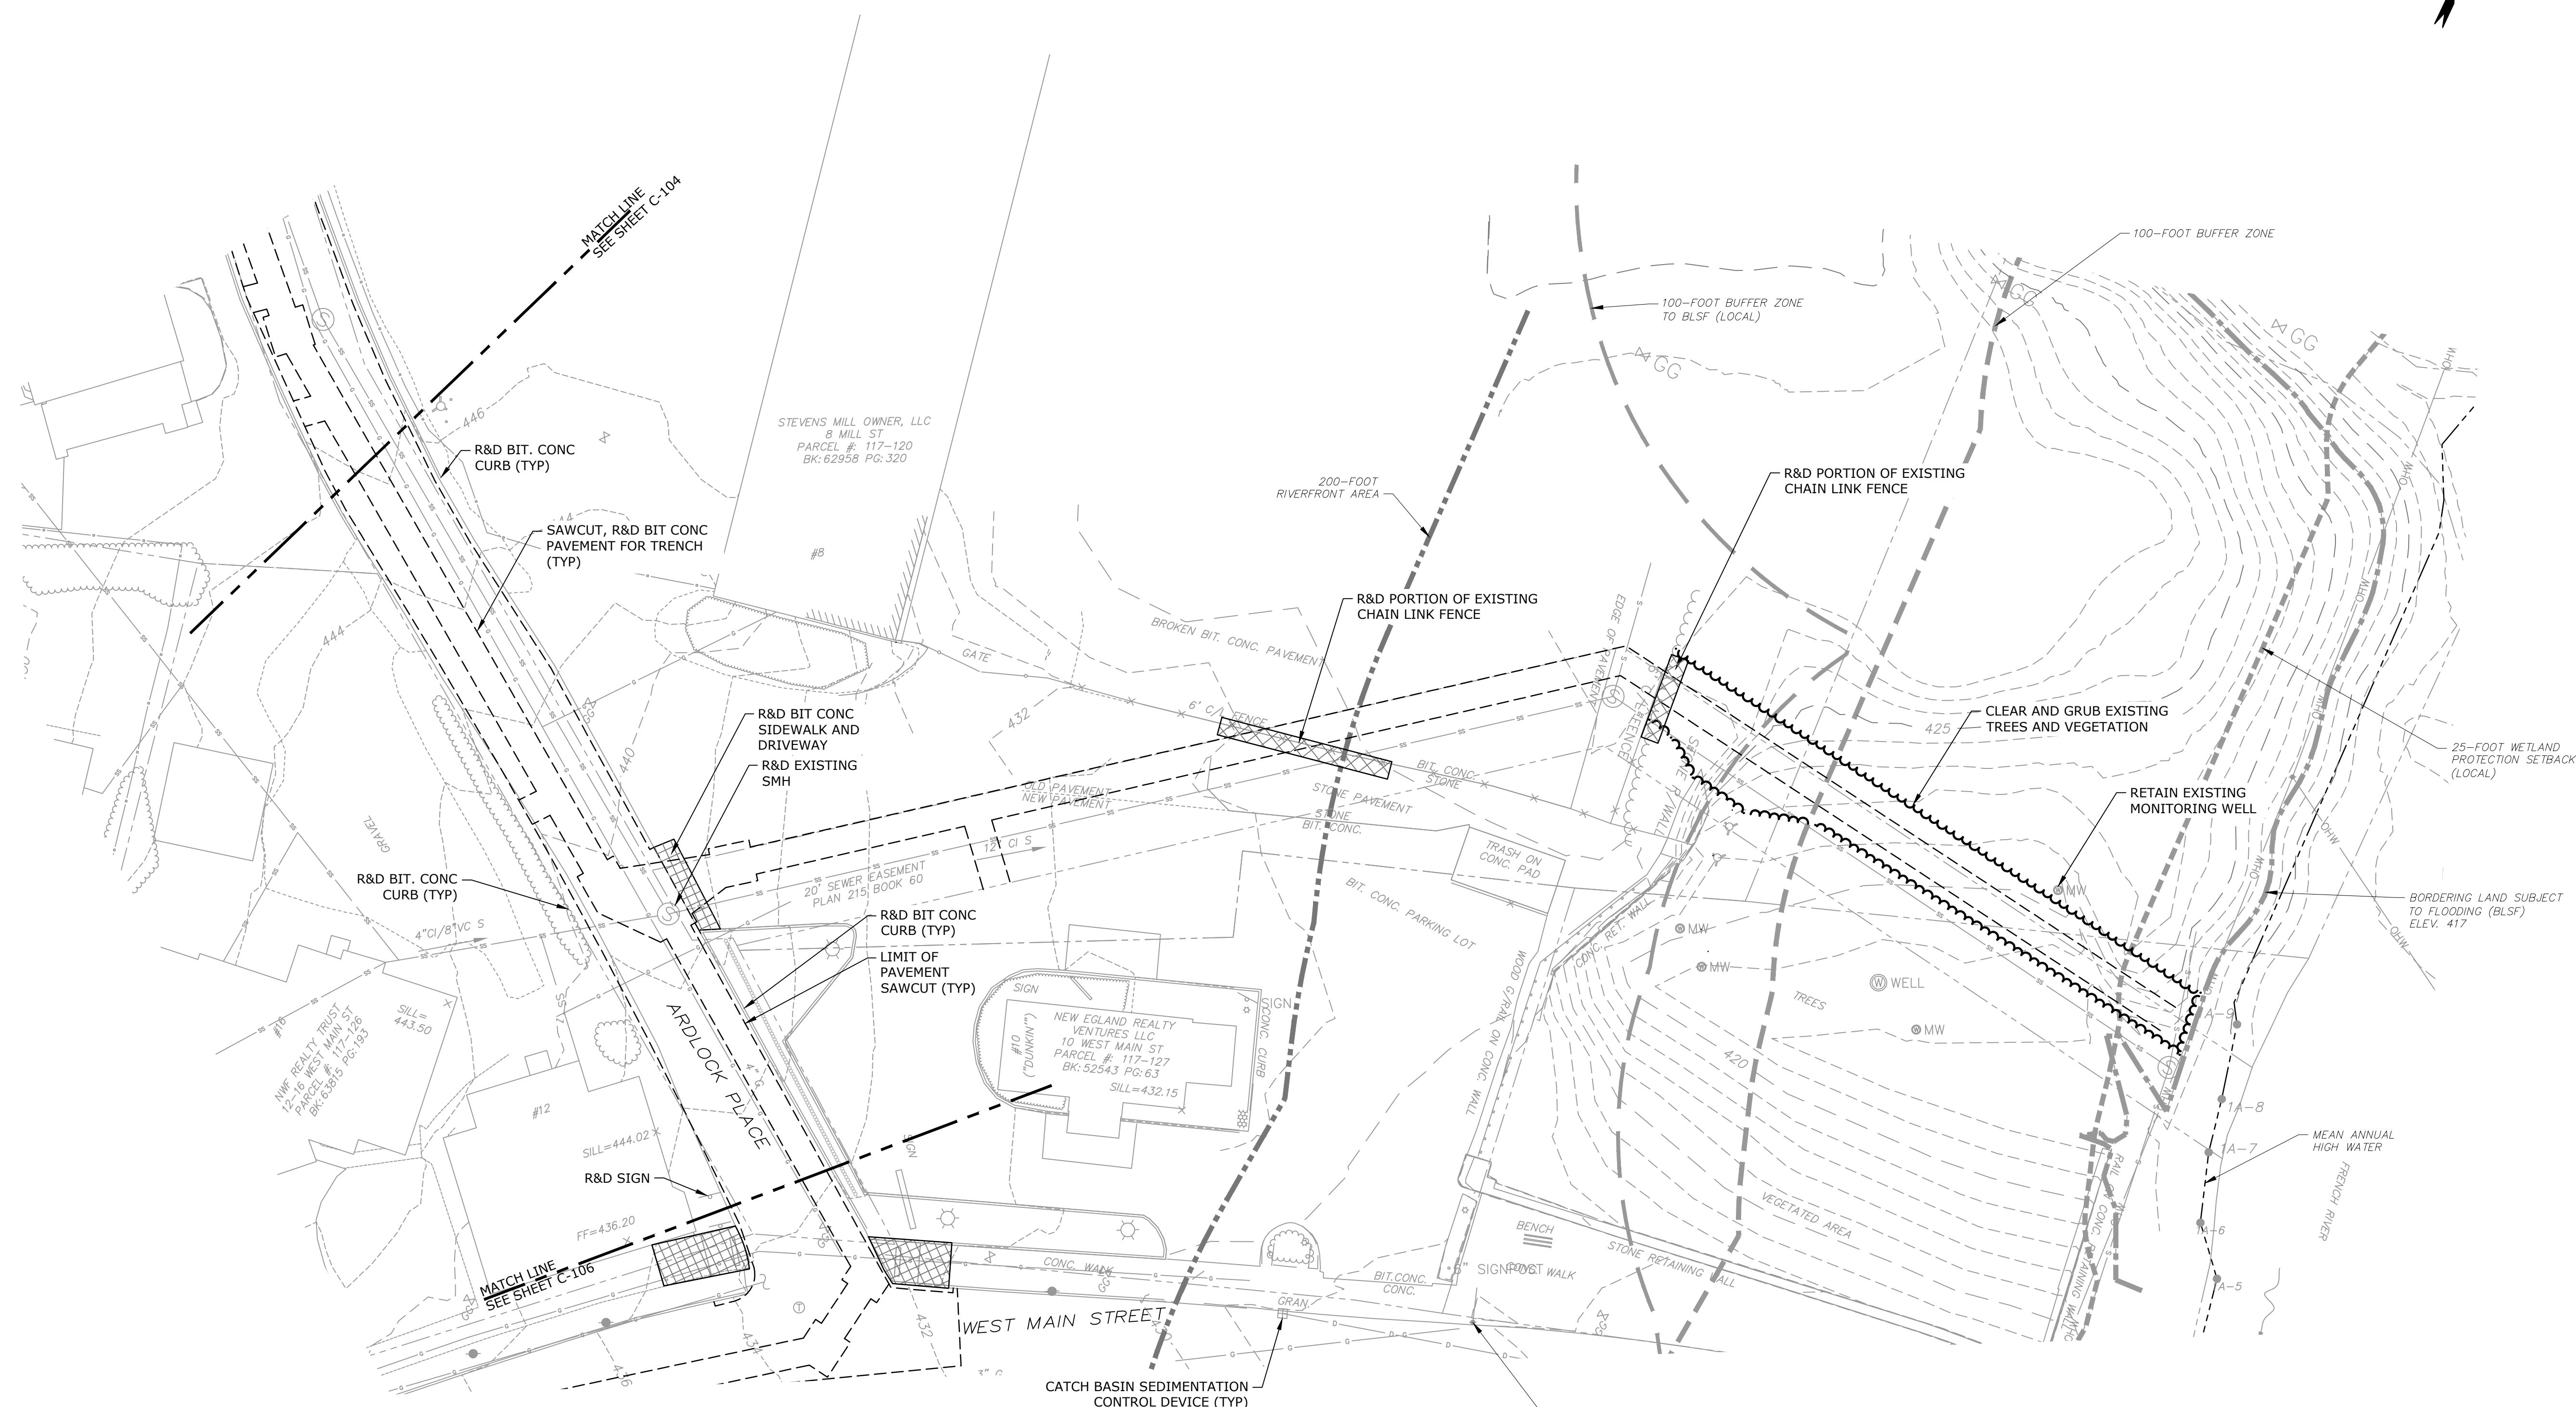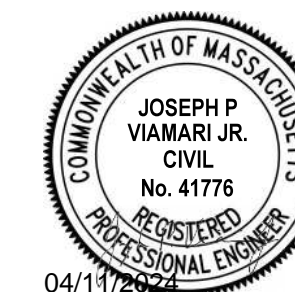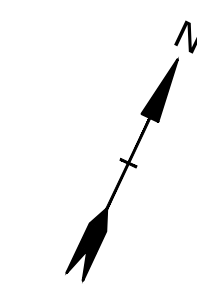

**Stevens Mill  
Sewer and  
Sidewalk  
Replacement  
Project**

Town of Dudley


Dudley, MA

MARK	DATE	DESCRIPTION
0	04/10/2024	ISSUED FOR BIDDING

PROJECT NO:	D5011-018
DATE:	04/2024
FILE:	D5011-018 ExeCn.dwg
DRAWN BY:	ND/ABS
CHECKED BY:	MPW
APPROVED BY:	JPV




EXISTING CONDITIONS AND DEMOLITION PLAN - 5

SCALE: AS SHOWN

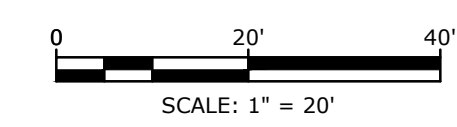

C-105

Last Saved: 4/9/2024 11:54am By: NBay  
 Plotted On: Apr 10, 2024 11:54am By: NBay  
 Title & Content: D:\Projects\2024\11-Dudley\11-Stevens Mill MassWorks\Drawings\_Figures\AutoCAD\Sheet\DS011\_018\_Execn.dwg

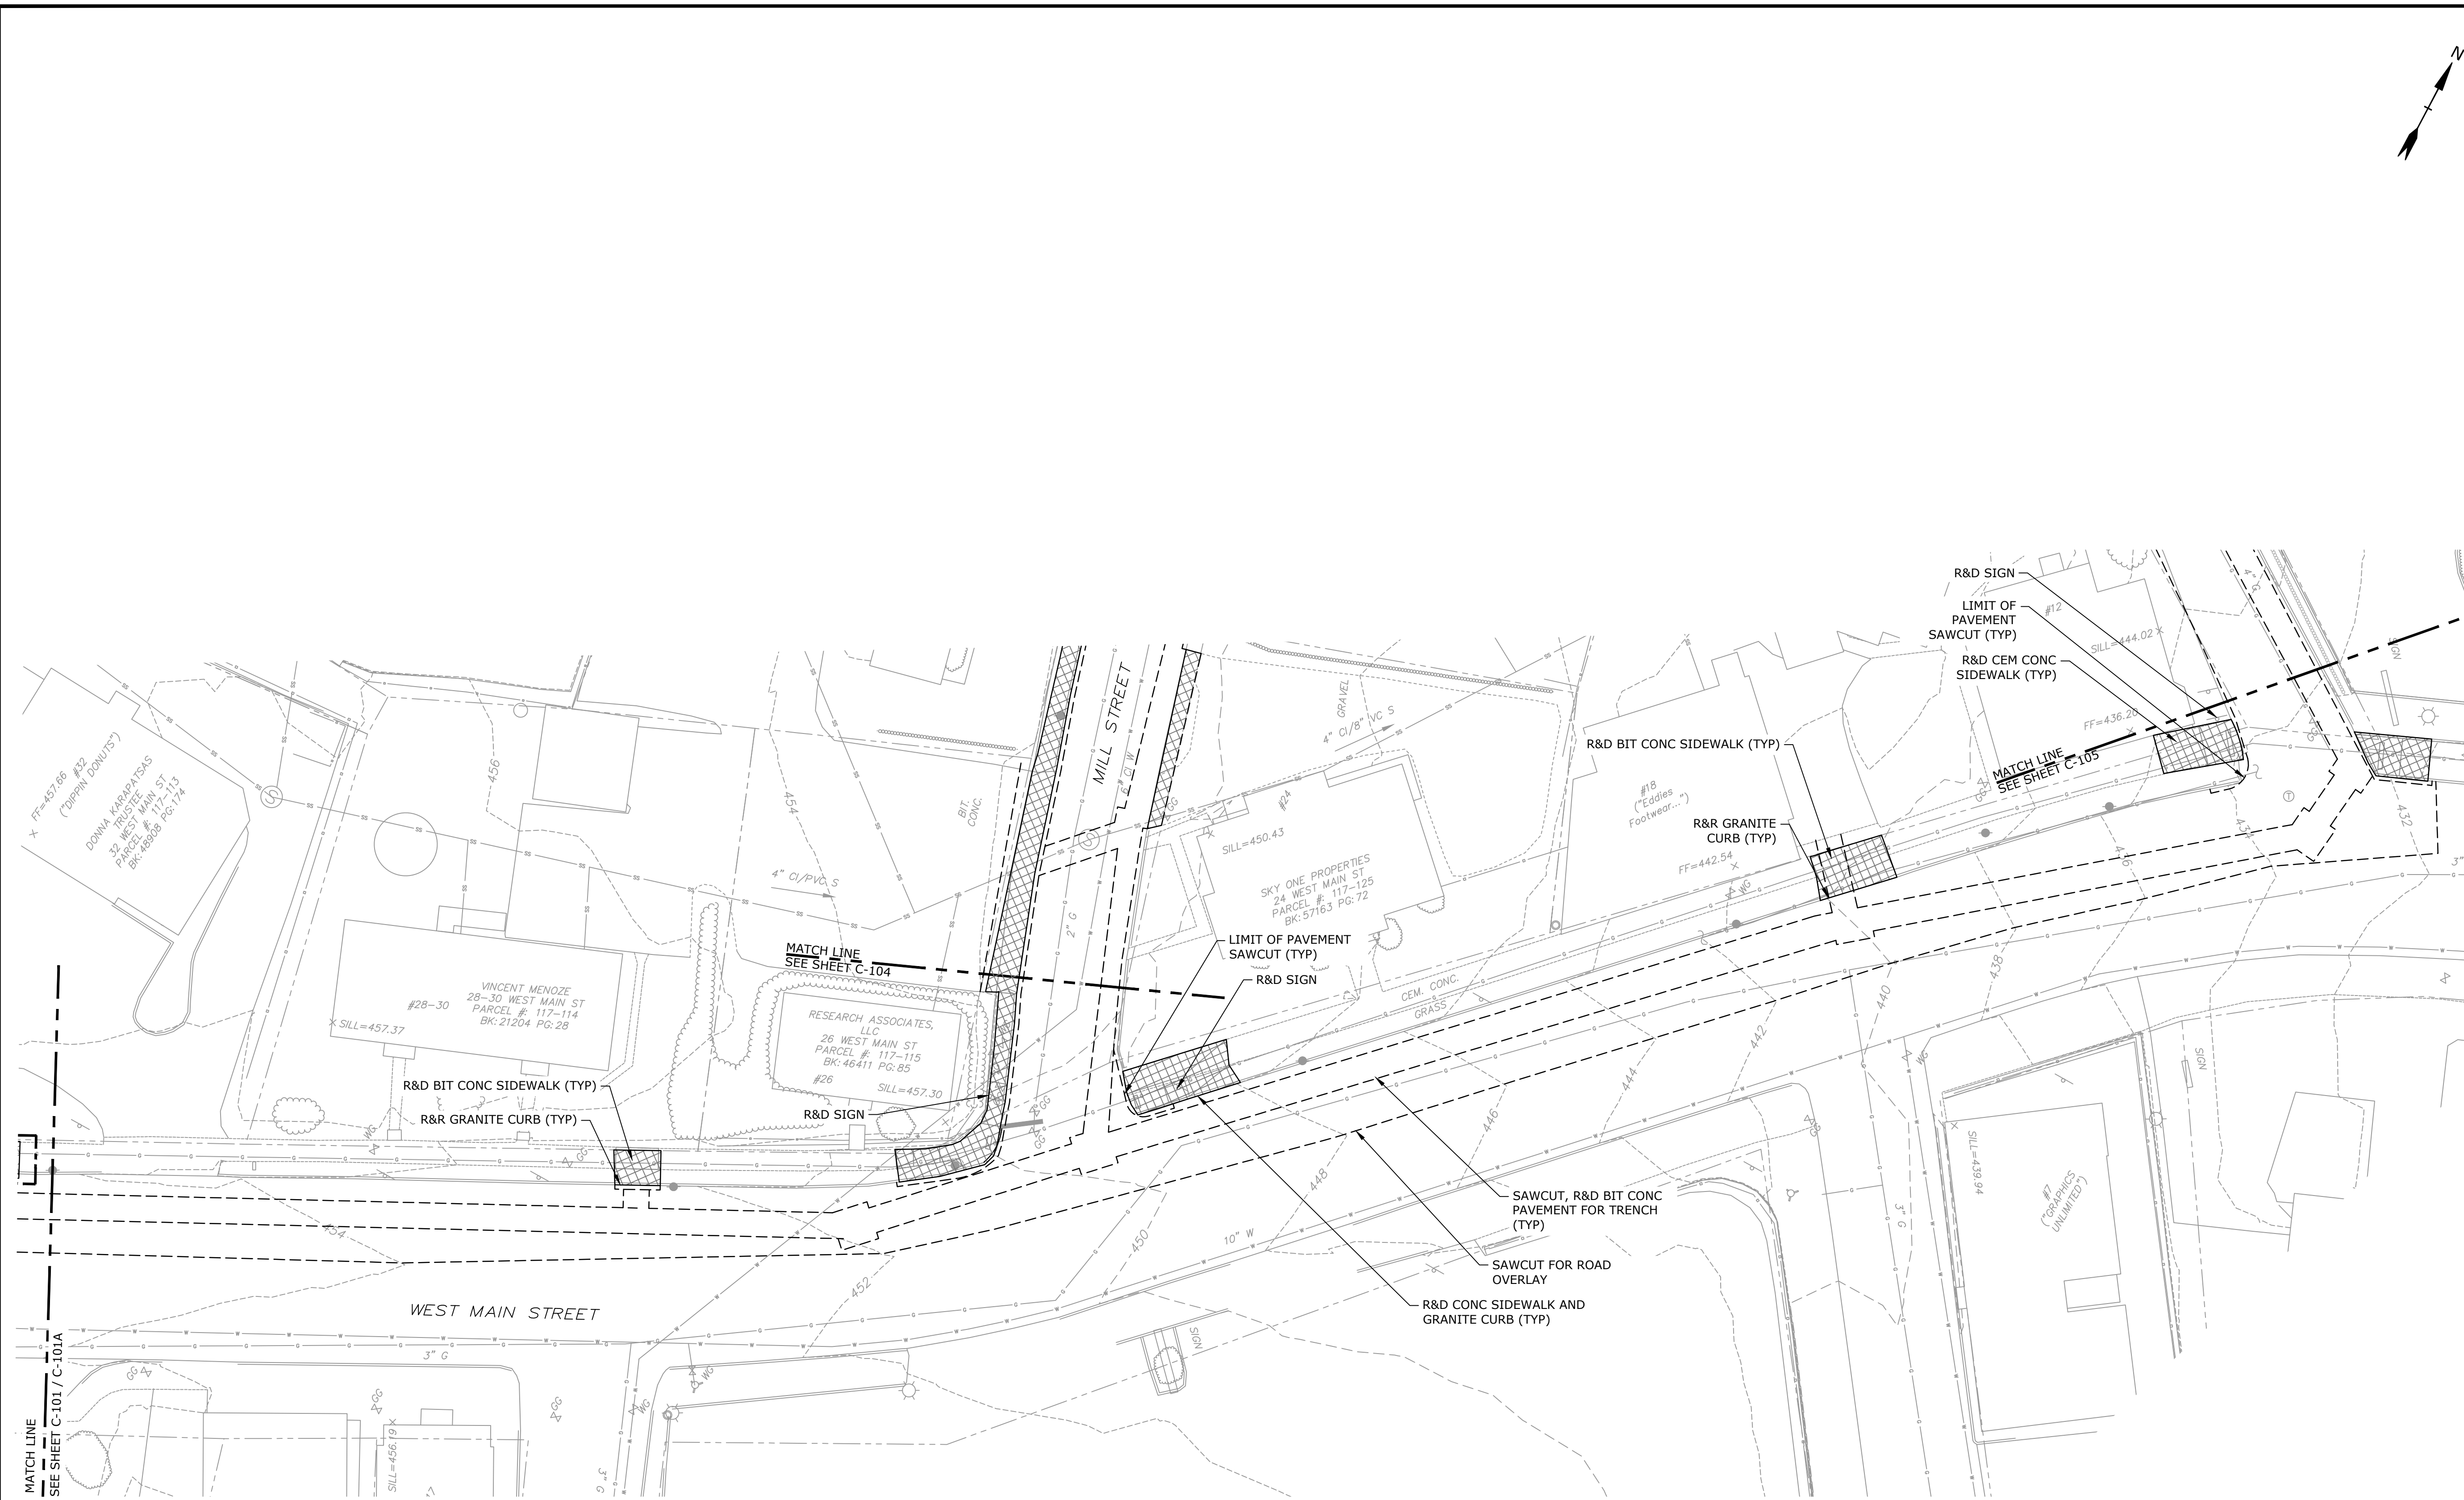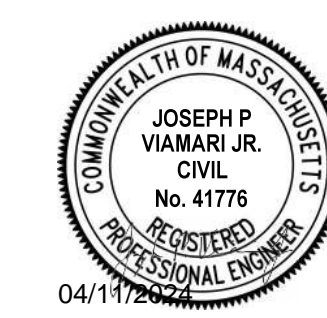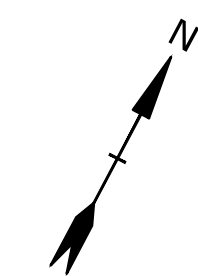

**Stevens Mill  
Sewer and  
Sidewalk  
Replacement  
Project**

Town of Dudley


Dudley, MA

MARK	DATE	DESCRIPTION
0	04/10/2024	ISSUED FOR BIDDING

PROJECT NO:	D5011-018
DATE:	04/2024
FILE:	D5011-018 ExeCn.dwg
DRAWN BY:	ND/ABS
CHECKED BY:	MPW
APPROVED BY:	JPV




EXISTING CONDITIONS AND  
DEMOLITION PLAN - 6

SCALE: AS SHOWN

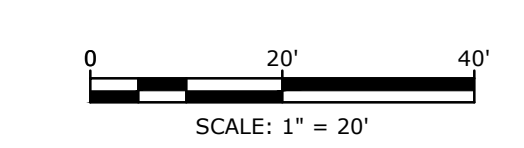

**C-106**

Last Saved: 4/9/2024 11:54am By: NBay  
 Plotted On: Apr 10, 2024 11:54am By: NBay  
 File & Server: Z:\D5011\Drawings\Stevens Mill\MassWorks\Drawings\_Figures\AutoCAD\Sheet\DS011\_018\_ExecCn.dwg

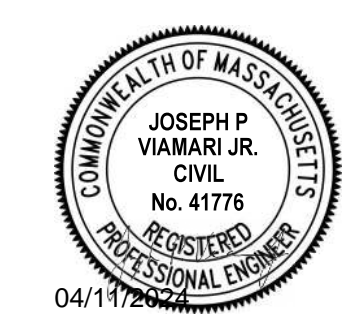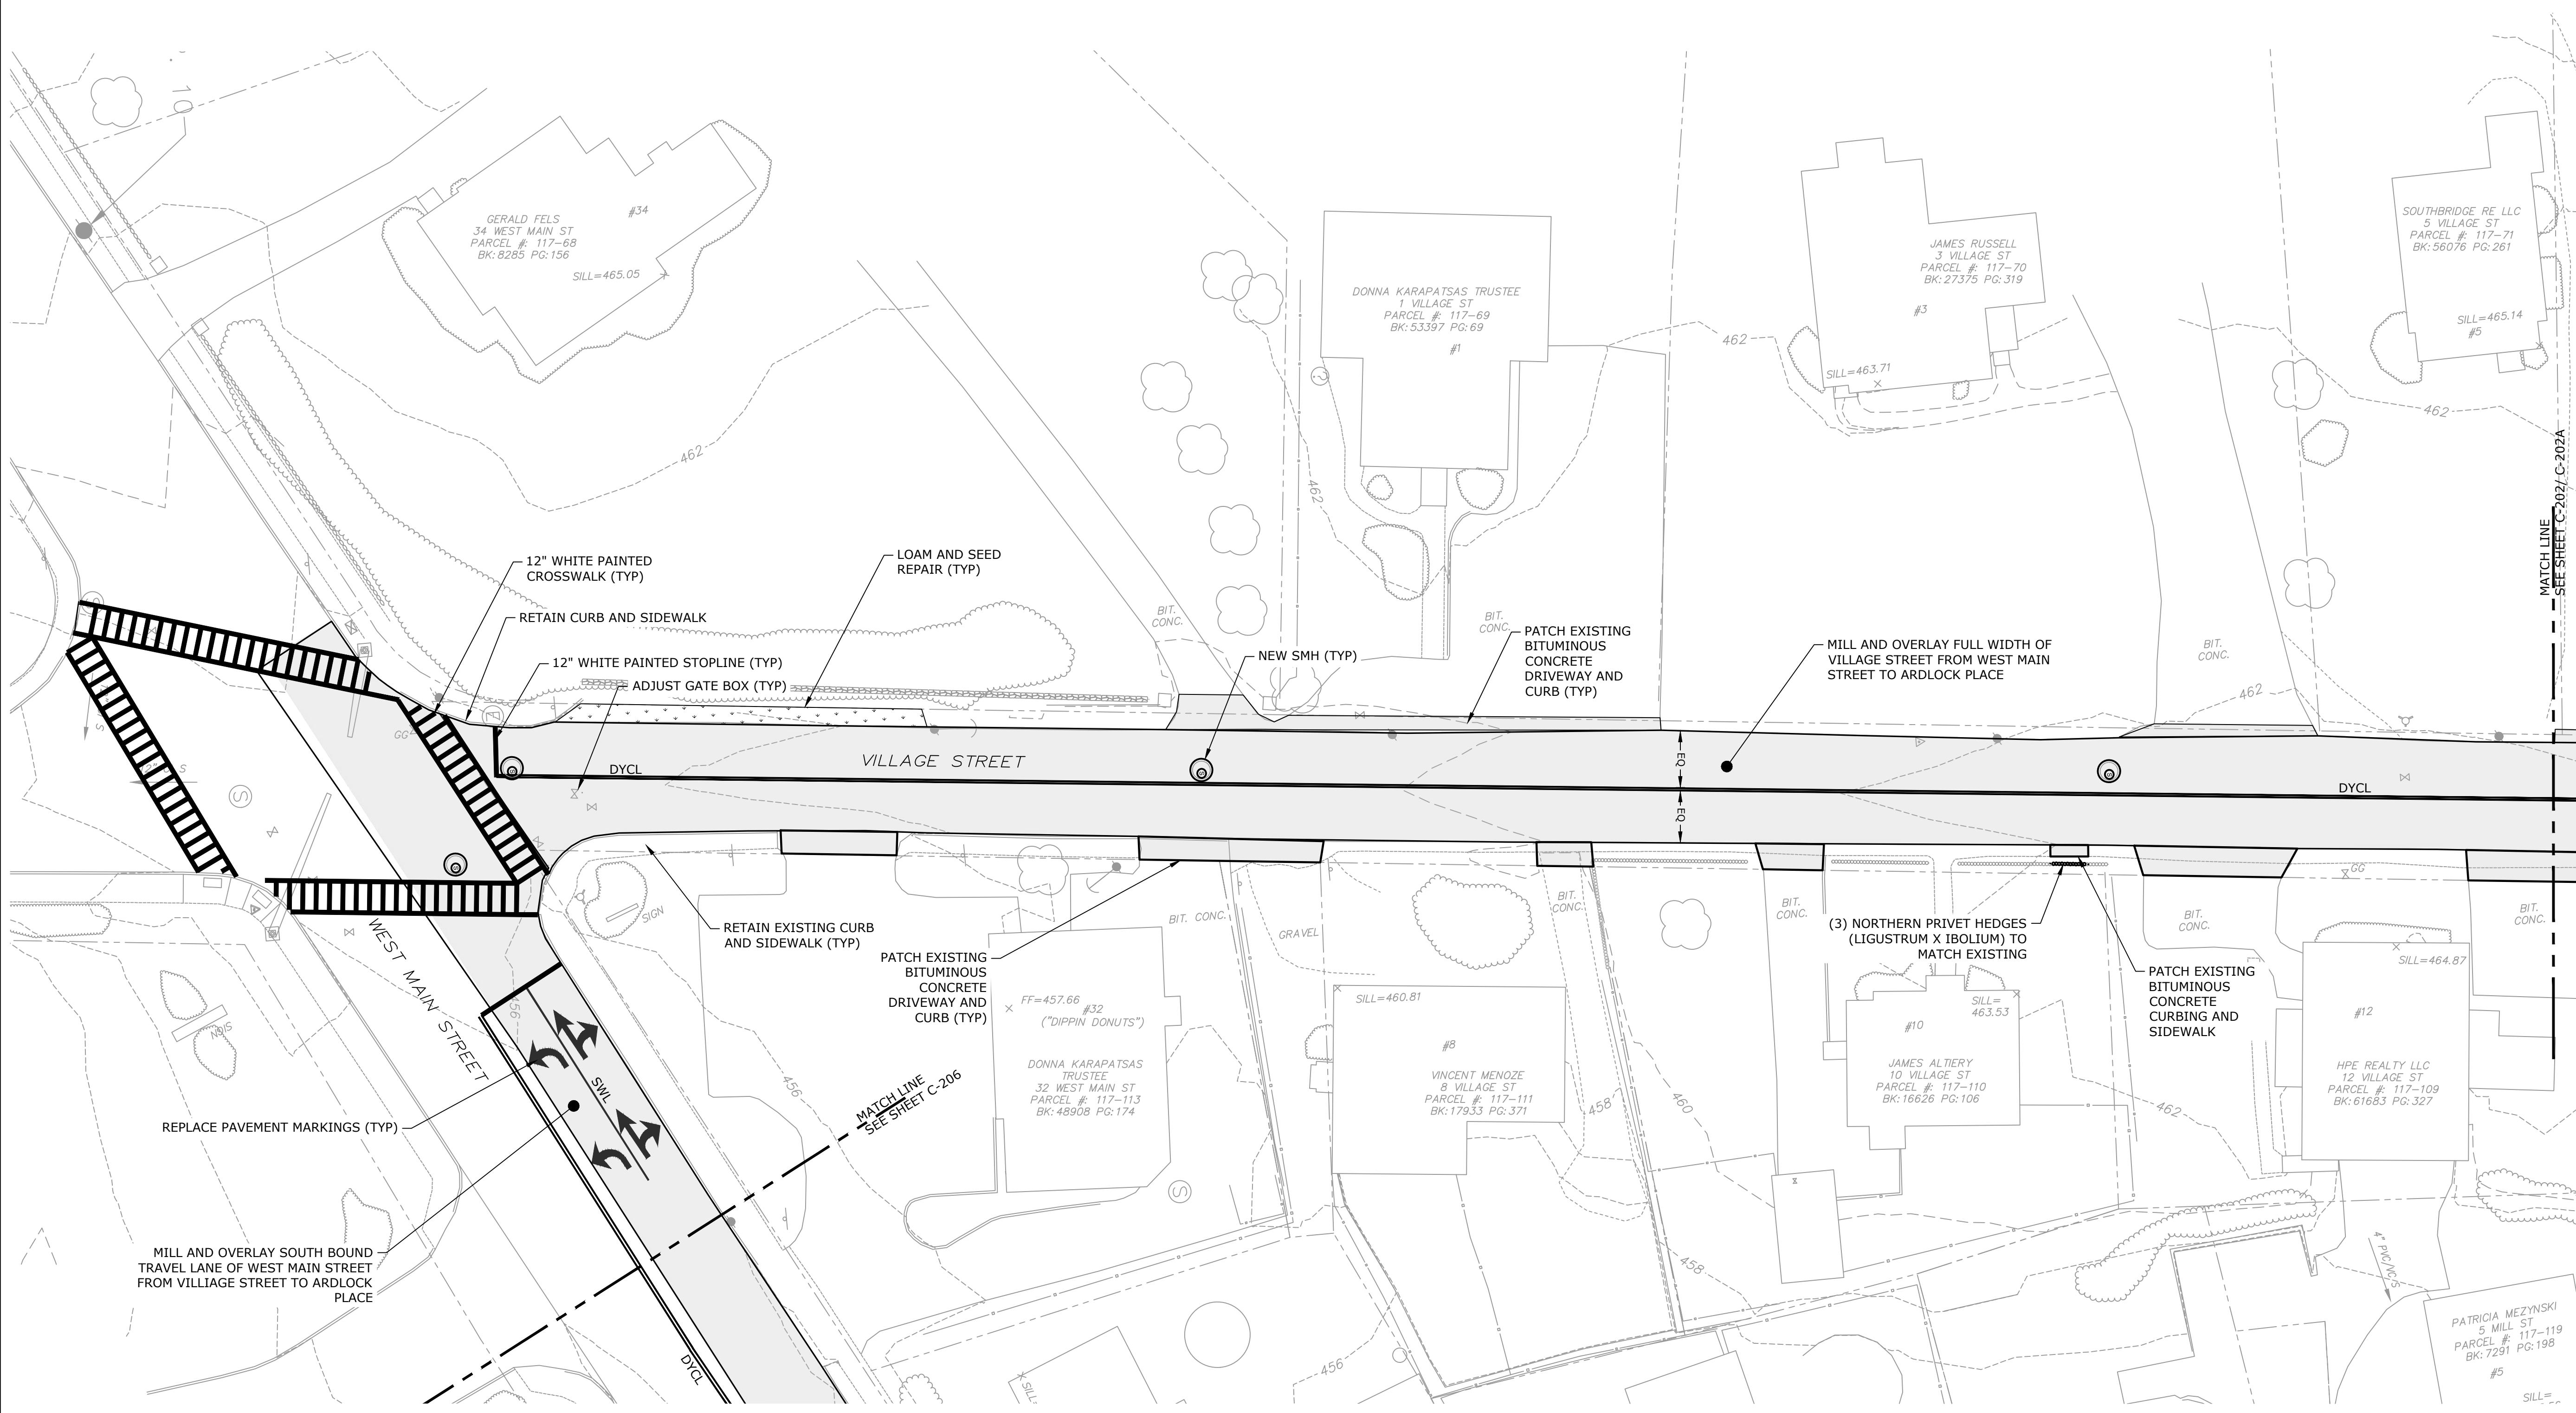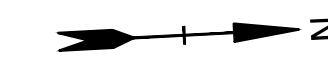

**Stevens Mill Sewer and Sidewalk Replacement Project**

Town of Dudley

Dudley, MA


MARK	DATE	DESCRIPTION
0	04/10/2024	ISSUED FOR BIDDING

PROJECT NO: D5011-018  
 DATE: 04/2024  
 FILE: D5011-018 Proposed.dwg  
 DRAWN BY: ND/ABS  
 CHECKED BY: MPW  
 APPROVED BY: JPV




**SITE LAYOUT AND IMPROVEMENTS PLAN - 1**

SCALE: AS SHOWN

C-201

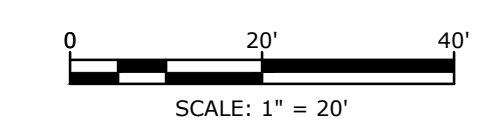

Last Saved: 4/10/2024 11:54am By: NBay  
 Plotted On: Apr 10, 2024 11:54am By: NBay  
 Figure & Legend: 3:10:05:2024 Stevens Mill MassWorks Drawings - Figures AutoCAD Sheet D5011\_018 Proposed.dwg

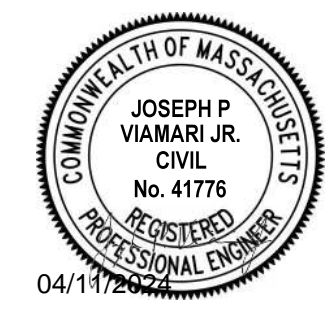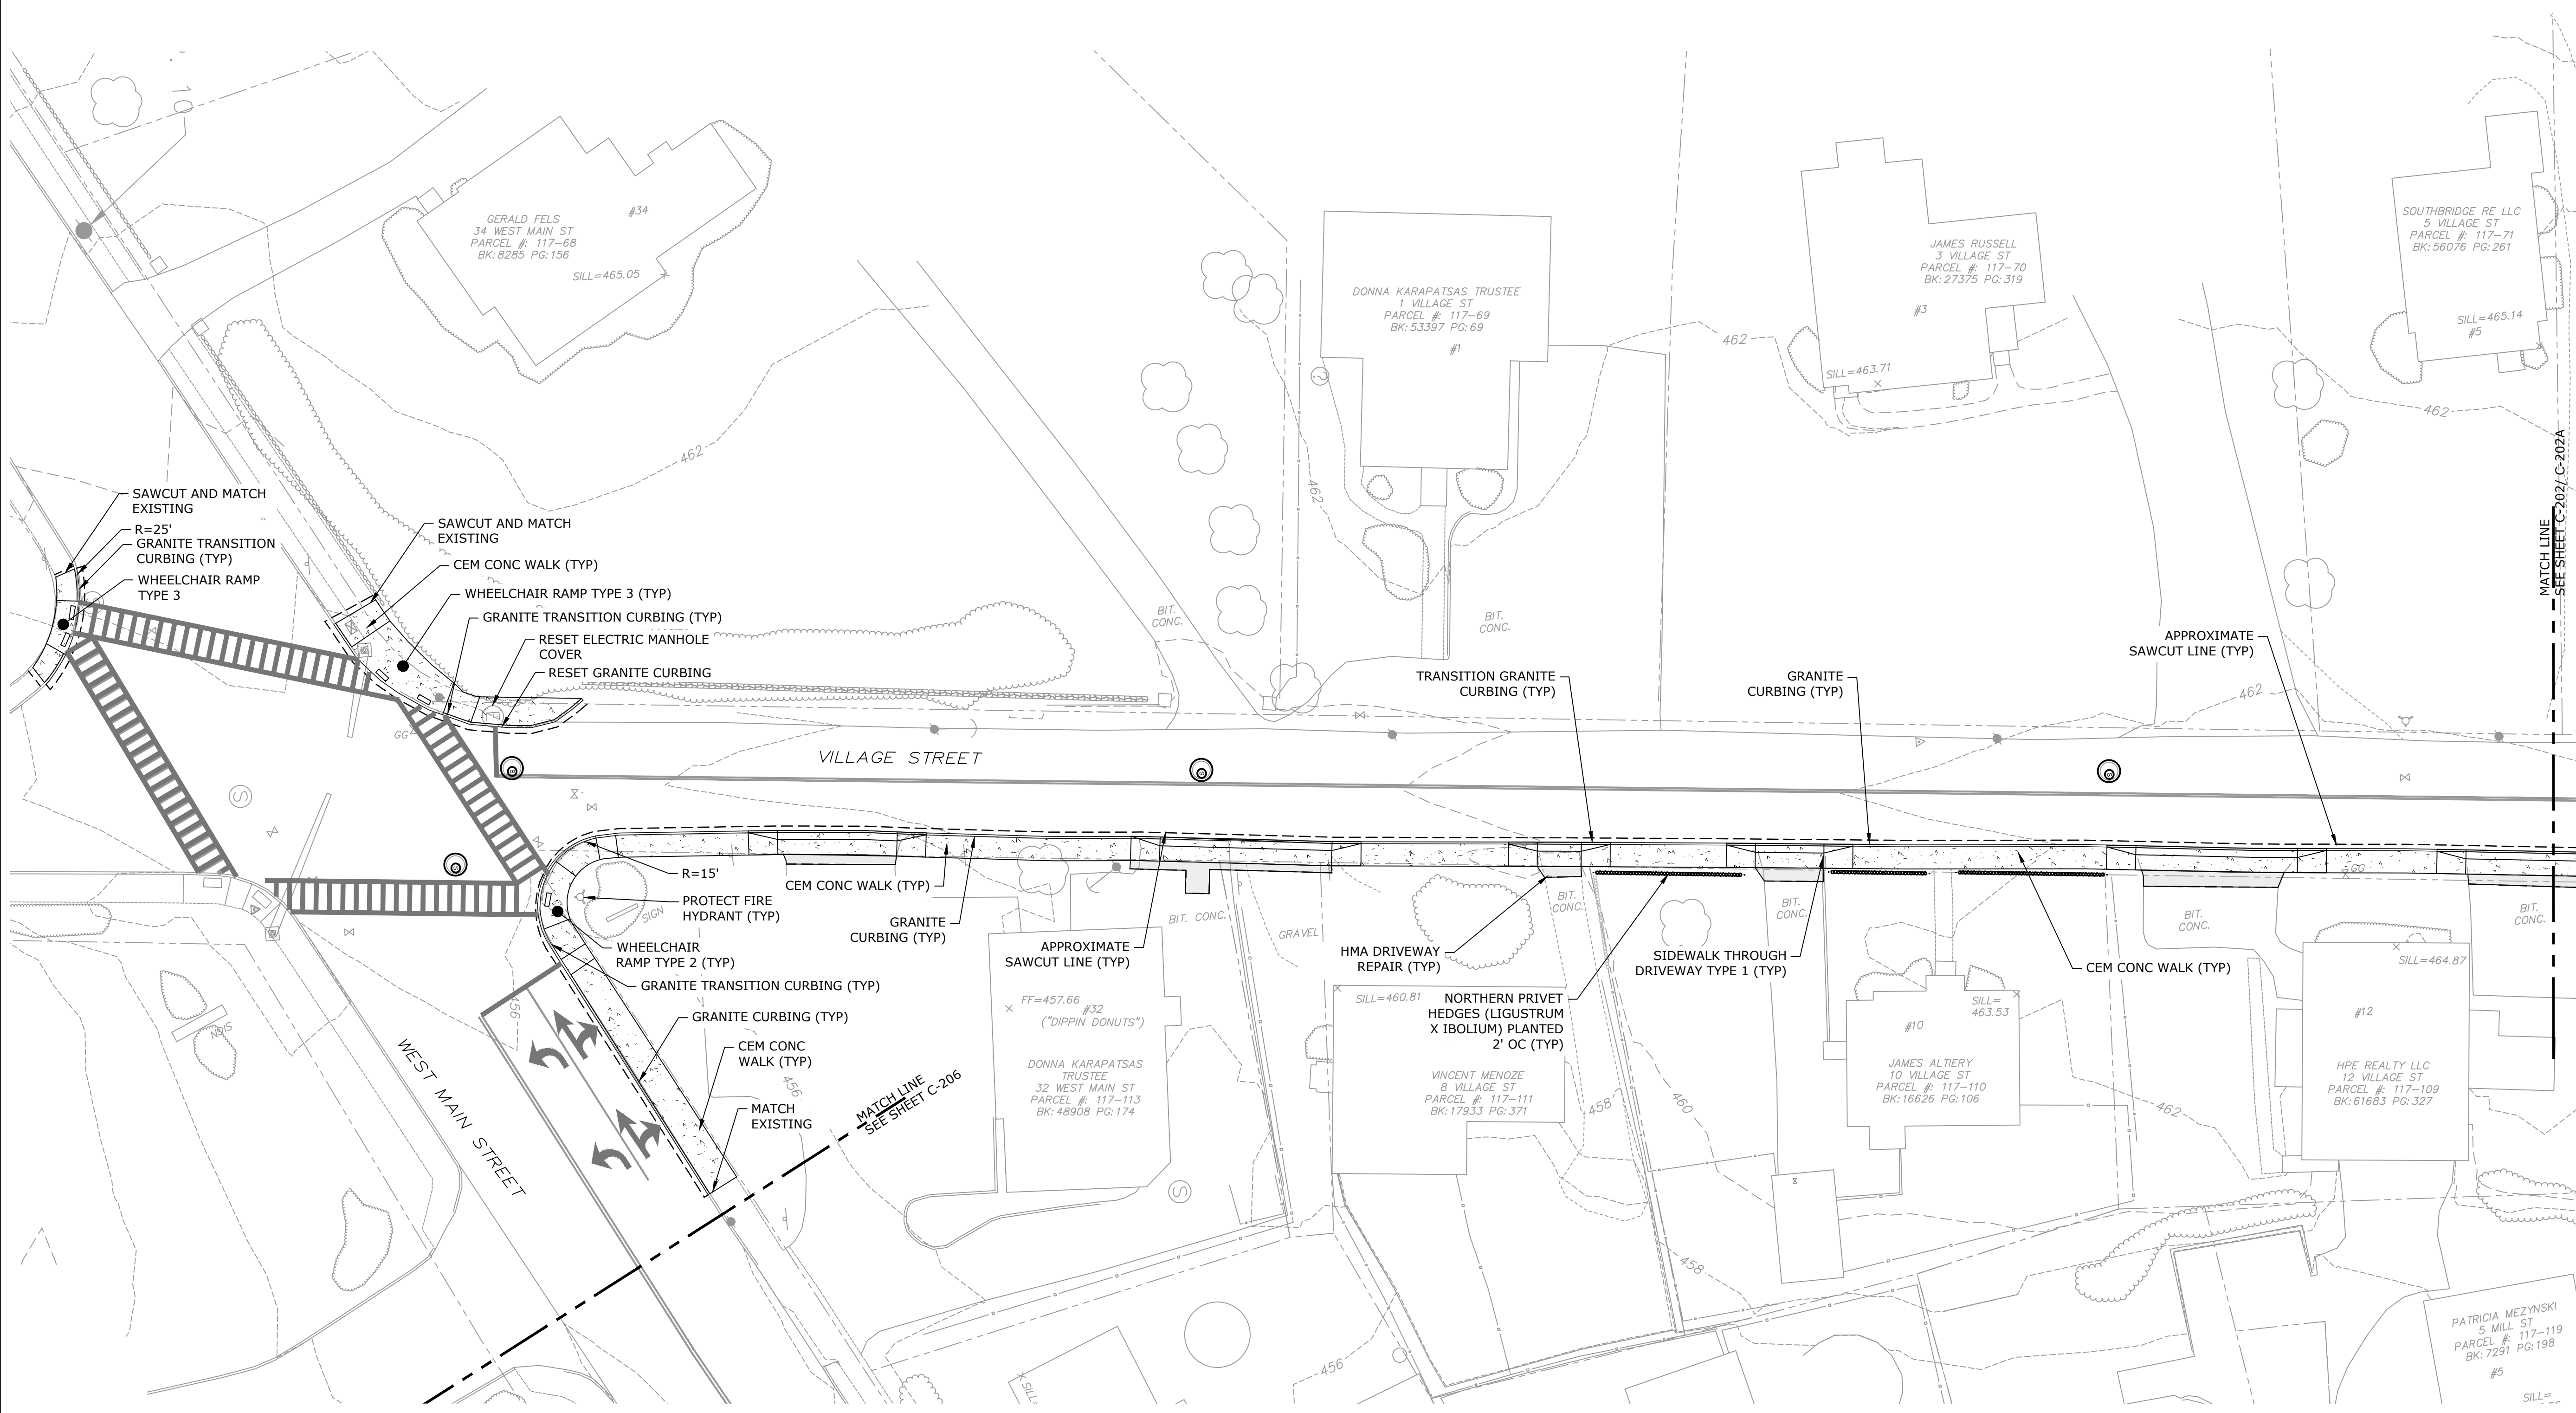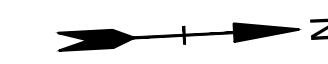

**Stevens Mill Sewer and Sidewalk Replacement Project**

Town of Dudley

Dudley, MA


- NOTE**
1. ALL WORK SHOWN ON THIS SHEET IS TO BE INCLUDED IN BID ALTERNATE 1.


MARK	DATE	DESCRIPTION
0	04/10/2024	ISSUED FOR BIDDING




PROJECT NO: D5011-018  
 DATE: 04/2024  
 FILE: D5011-018 Proposed.dwg  
 DRAWN BY: ND/ABS  
 CHECKED BY: MPW  
 APPROVED BY: JPV

SITE LAYOUT AND IMPROVEMENTS PLAN - 1 ALTERNATE 1 SCOPE

SCALE: AS SHOWN

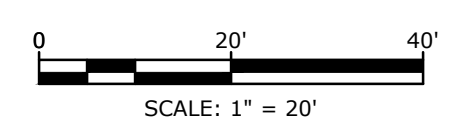

Last Saved: 4/10/2024 11:55am By: NBay  
 Plotted On: Apr 10, 2024 11:55am By: NBay  
 File: C:\Users\NBay\OneDrive\Documents\Drawings\Figures\AutoCAD\Sheet\DS011\_018\_Proposed.dwg

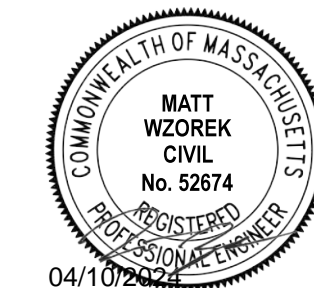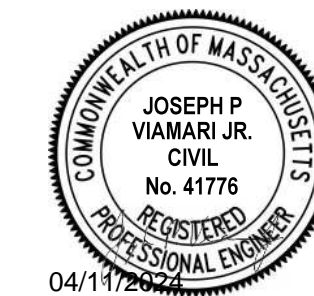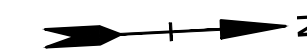

**Stevens Mill  
Sewer and  
Sidewalk  
Replacement  
Project**

Town of Dudley


Dudley, MA

0	04/10/2024	ISSUED FOR BIDDING
MARK	DATE	DESCRIPTION
PROJECT NO: D5011-018		
DATE: 04/2024		
FILE: D5011-018 Proposed.dwg		
DRAWN BY: ND/ABS		
CHECKED BY: MPW		
APPROVED BY: JPV		

**SITE LAYOUT AND  
IMPROVEMENTS PLAN - 2**




SCALE: AS SHOWN

**C-202**

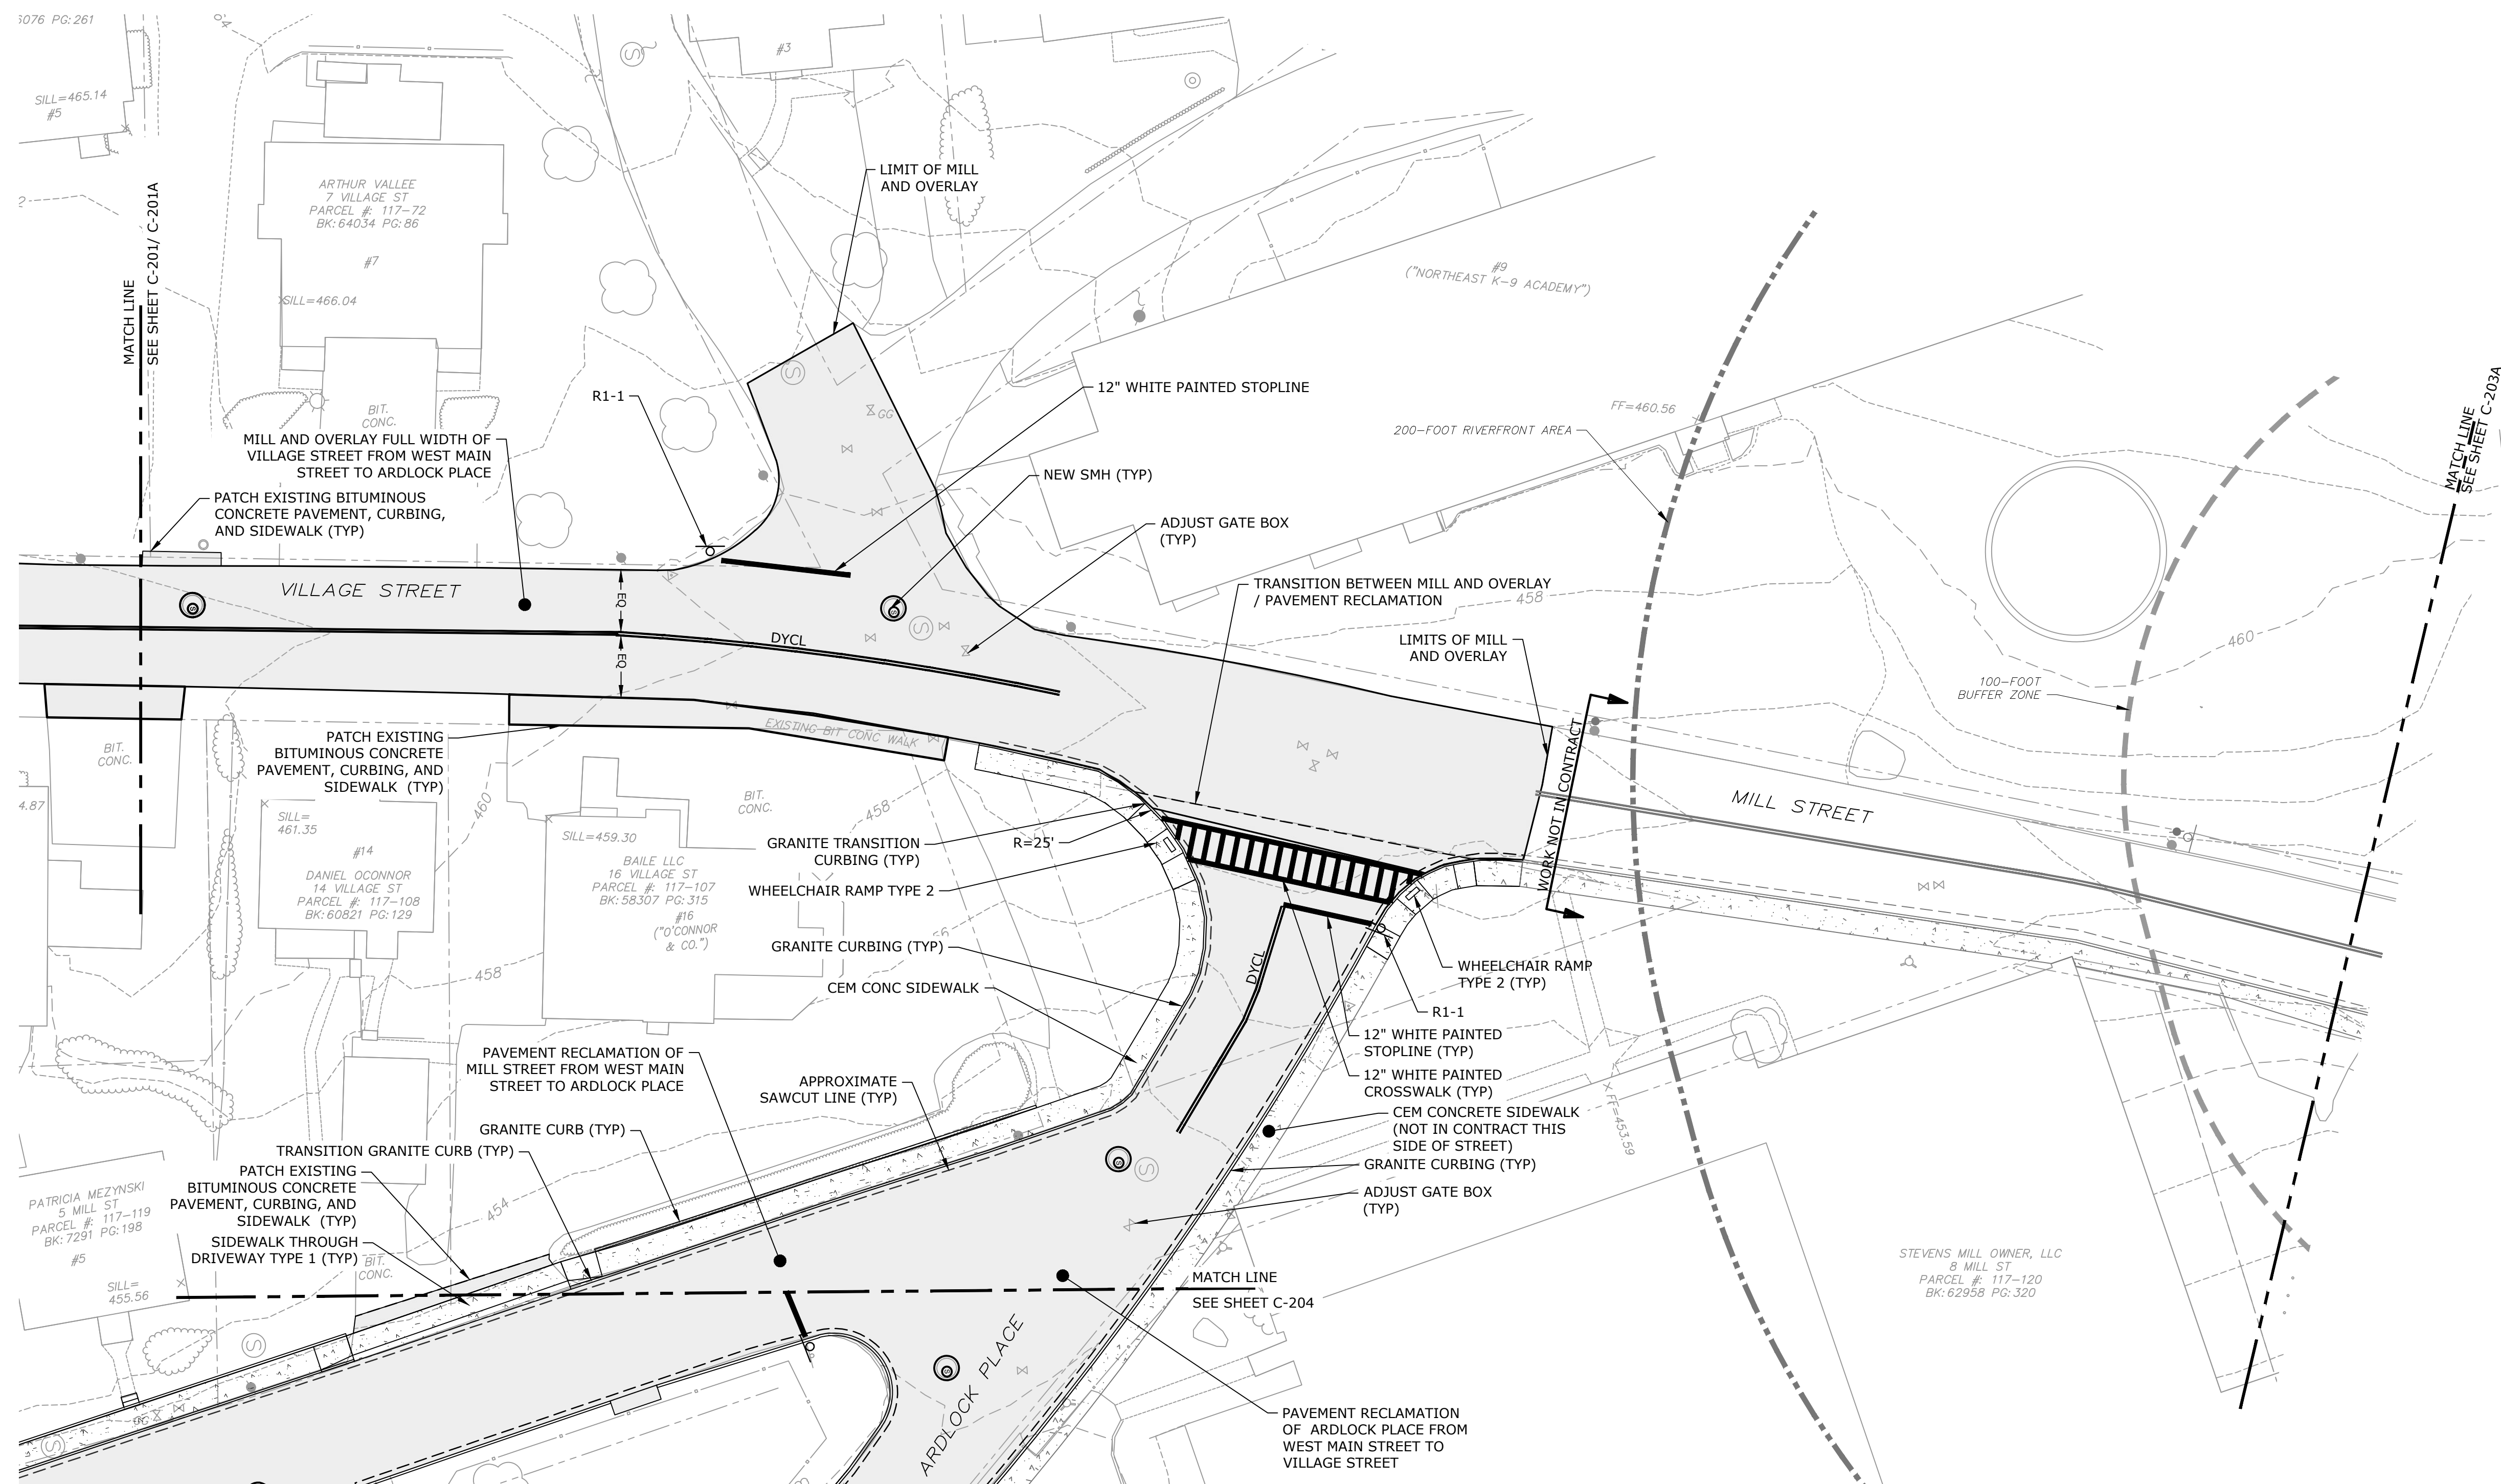

Last Saved: 4/10/2024 11:55am By: NBay  
 Plotted On: Apr 10, 2024 11:55am By: SBay  
 Figure & Legend: 3:10:05:211 Dudley Mill Stevens Mill MassWorksDrawings\_FiguresAutoCAD\_SheetD5011\_018\_Proposed.dwg



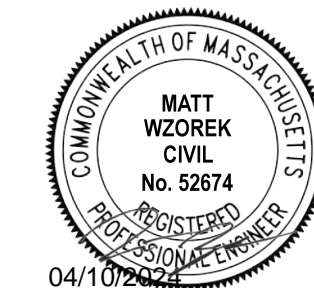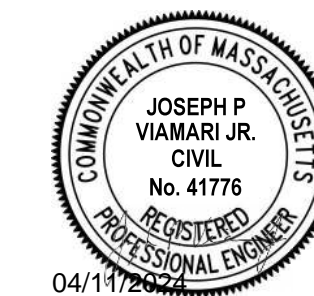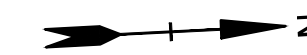

# Stevens Mill Sewer and Sidewalk Replacement Project

Town of Dudley


Dudley, MA

0	04/10/2024	ISSUED FOR BIDDING
MARK	DATE	DESCRIPTION
PROJECT NO: D5011-018		
DATE: 04/2024		
FILE: D5011-018 Proposed.dwg		
DRAWN BY: ND/ABS		
CHECKED BY: MPW		
APPROVED BY: JPV		


SITE LAYOUT AND IMPROVEMENTS PLAN - 2 ALTERNATE 1 SCOPE

SCALE: AS SHOWN

C-202A



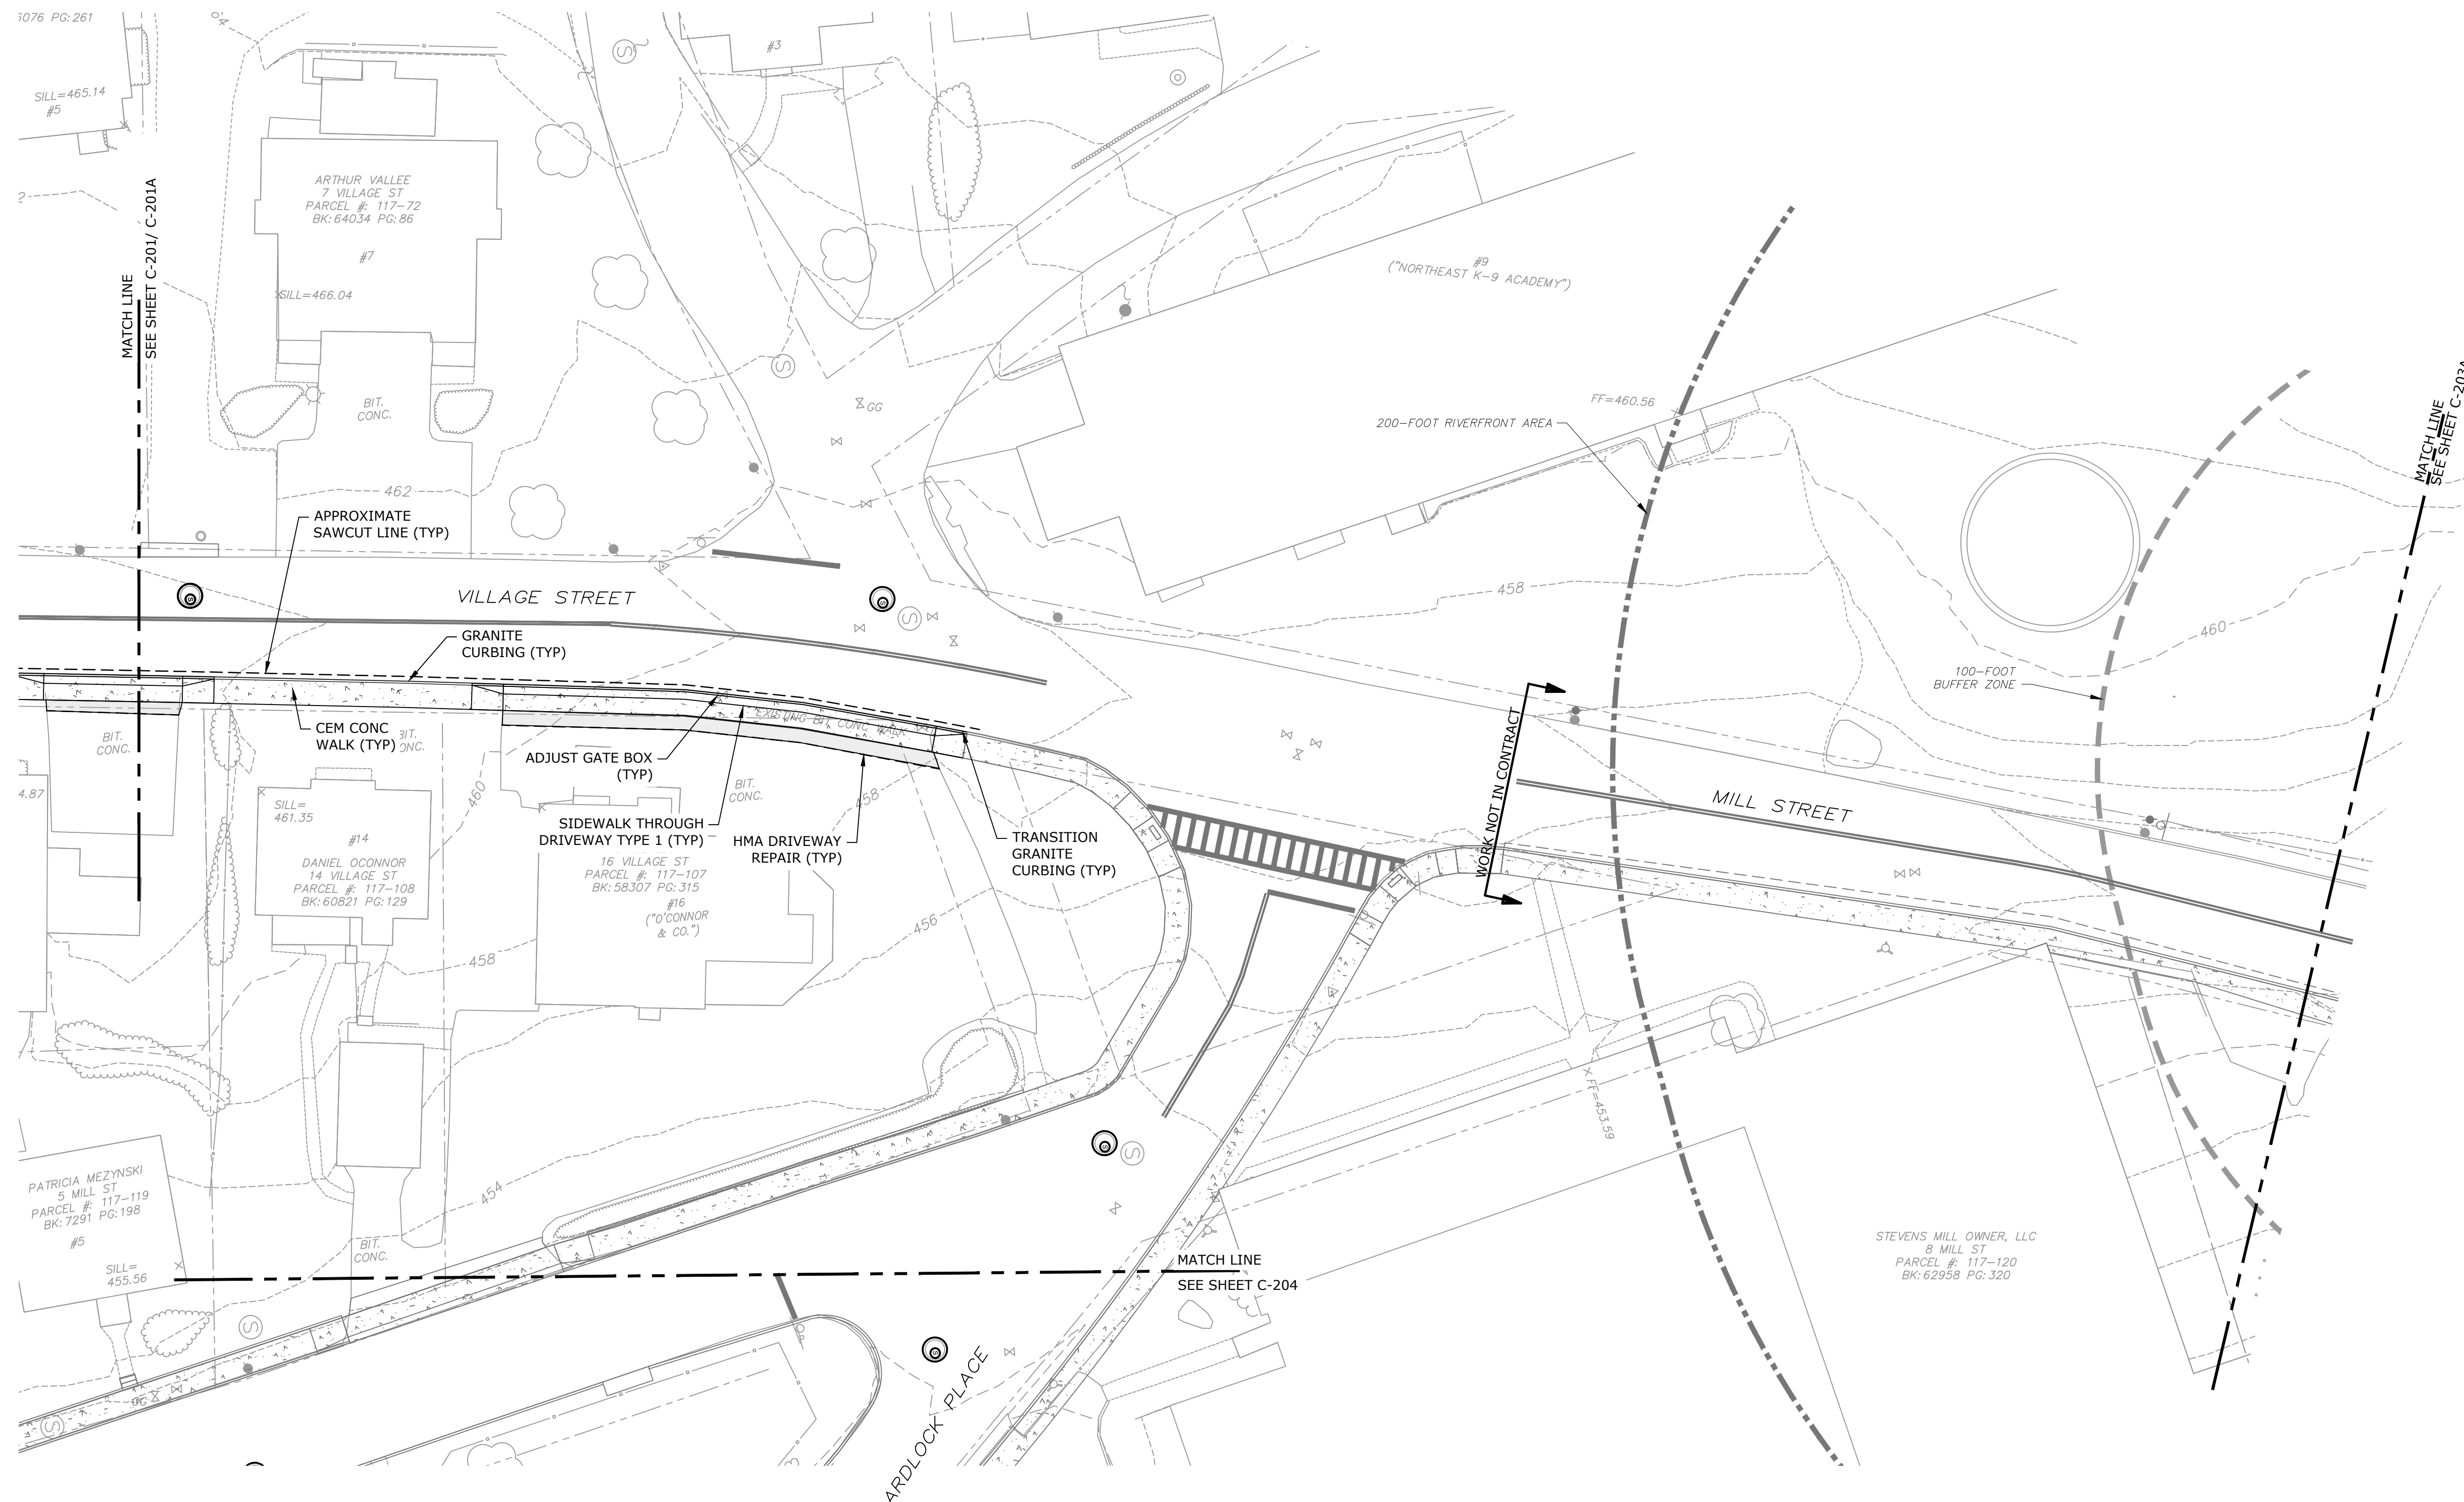


- NOTE**
- ALL WORK SHOWN ON THIS SHEET IS TO BE INCLUDED IN BID ALTERNATE 1.

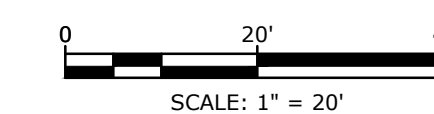

Last Saved: 4/10/2024 11:19pm By: ABS  
 Plotted On: Apr 10, 2024 11:15am By: ABS  
 Title & Content: D:\Projects\11 Stevens Mill MassWorks\Drawings\_Figures\AutoCAD\Sheet\DS011\_018\_Proposed.dwg



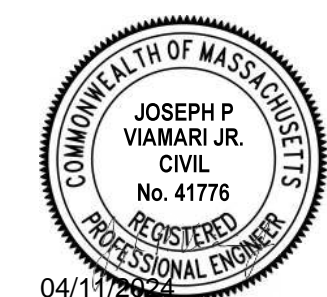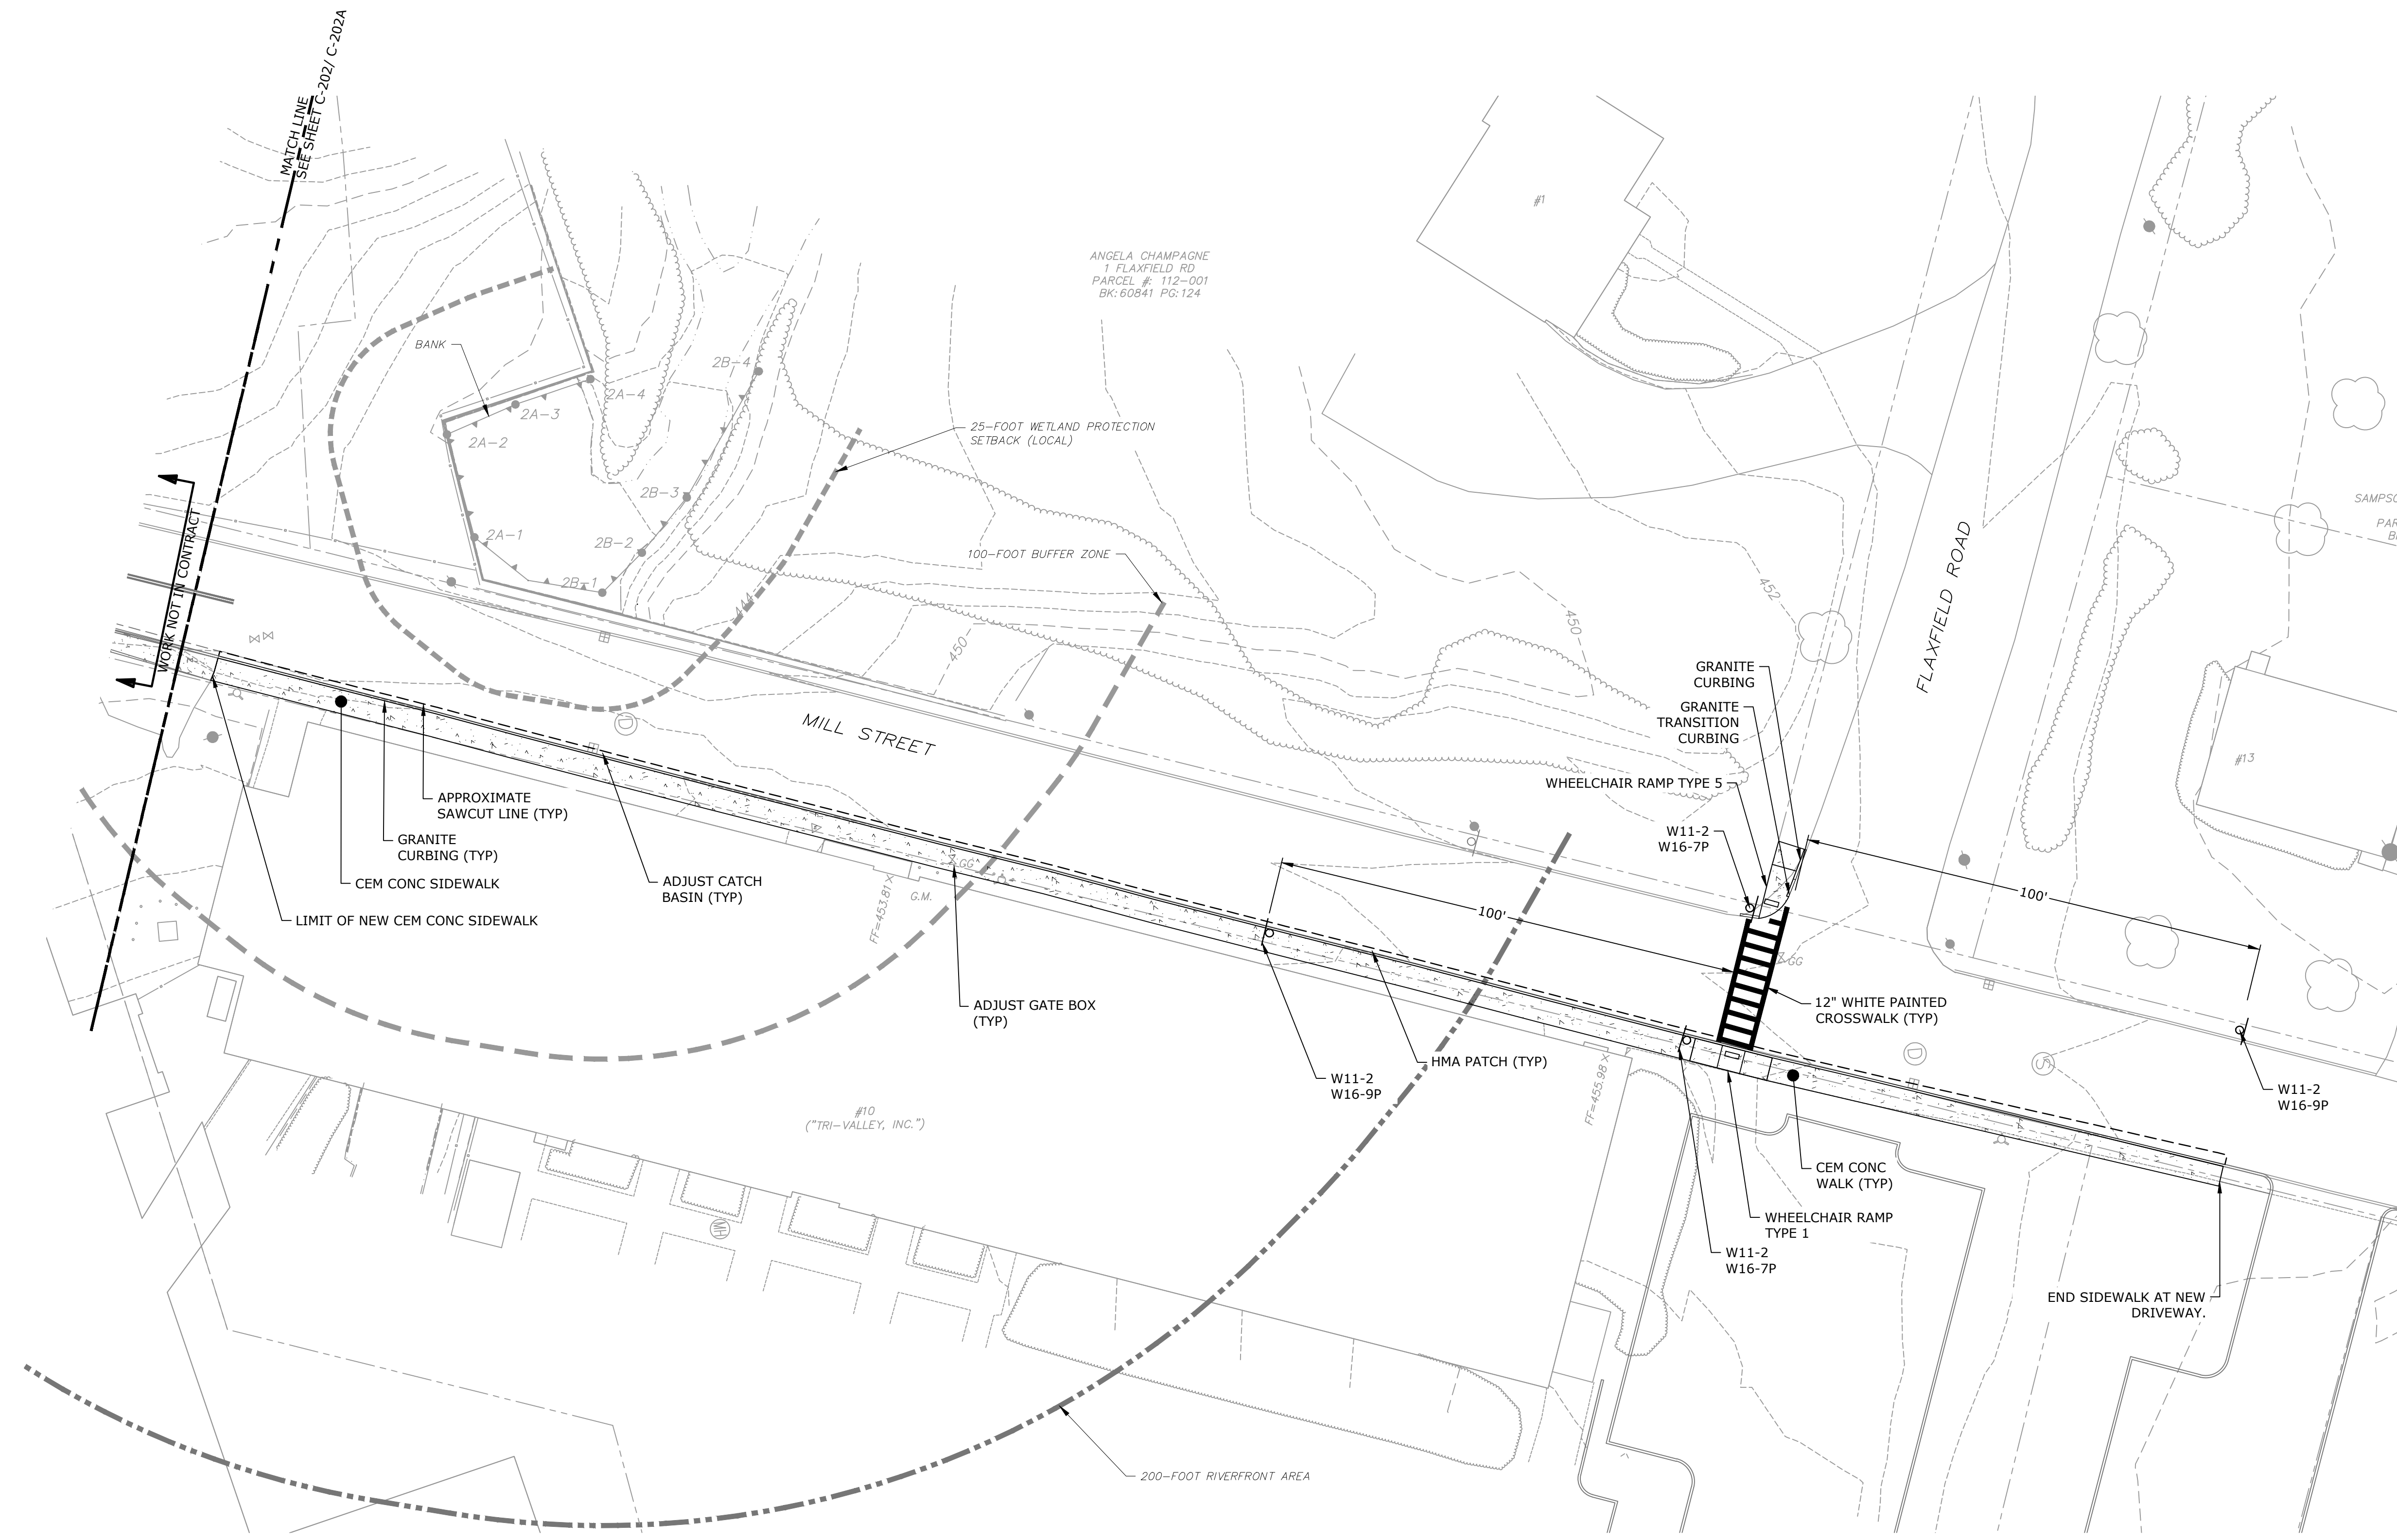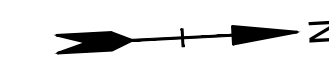

**Stevens Mill Sewer and Sidewalk Replacement Project**


Town of Dudley

Dudley, MA


0	04/10/2024	ISSUED FOR BIDDING
MARK	DATE	DESCRIPTION
PROJECT NO:	D5011-018	
DATE:	04/2024	
FILE:	D5011-018 Proposed.dwg	
DRAWN BY:	ND/ABS	
CHECKED BY:	MPW	
APPROVED BY:	JPV	

SITE LAYOUT AND IMPROVEMENTS PLAN - 3 ALTERNATE 2 SCOPE



SCALE: AS SHOWN

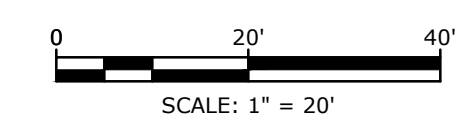

**NOTE**  
1. ALL WORK SHOWN ON THIS SHEET IS TO BE INCLUDED IN BID ALTERNATE 2.

Last Saved: 4/10/2024 11:56am By: NBay  
 Plotted On: Apr 10, 2024 11:56am  
 File & Server: P:\052111\Drawings\Mill\MassWorks\Drawings\_Figures\AutoCAD\Sheet\DS011\_018\_Proposed.dwg



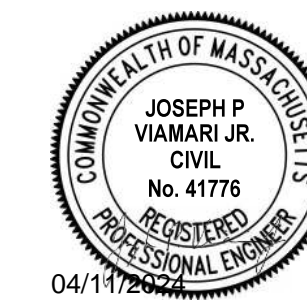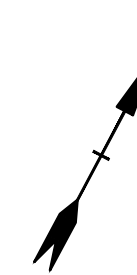

# Stevens Mill Sewer and Sidewalk Replacement Project

Town of Dudley

Dudley, MA



0	04/10/2024	ISSUED FOR BIDDING
MARK	DATE	DESCRIPTION
PROJECT NO:	D5011-018	
DATE:	04/2024	
FILE:	D5011-018 Proposed.dwg	
DRAWN BY:	ND/ABS	
CHECKED BY:	MPW	
APPROVED BY:	JPV	

## SITE LAYOUT AND IMPROVEMENTS PLAN - 5


SCALE: AS SHOWN




C-205

Last Saved: 4/10/2024 11:56am By: NBay  
Plotted On: Apr 10, 2024 11:56am  
File & Save Path: C:\Users\NBay\Documents\Drawings\Figures\AutoCAD\Sheets\DS011\_018\_Proposed.dwg

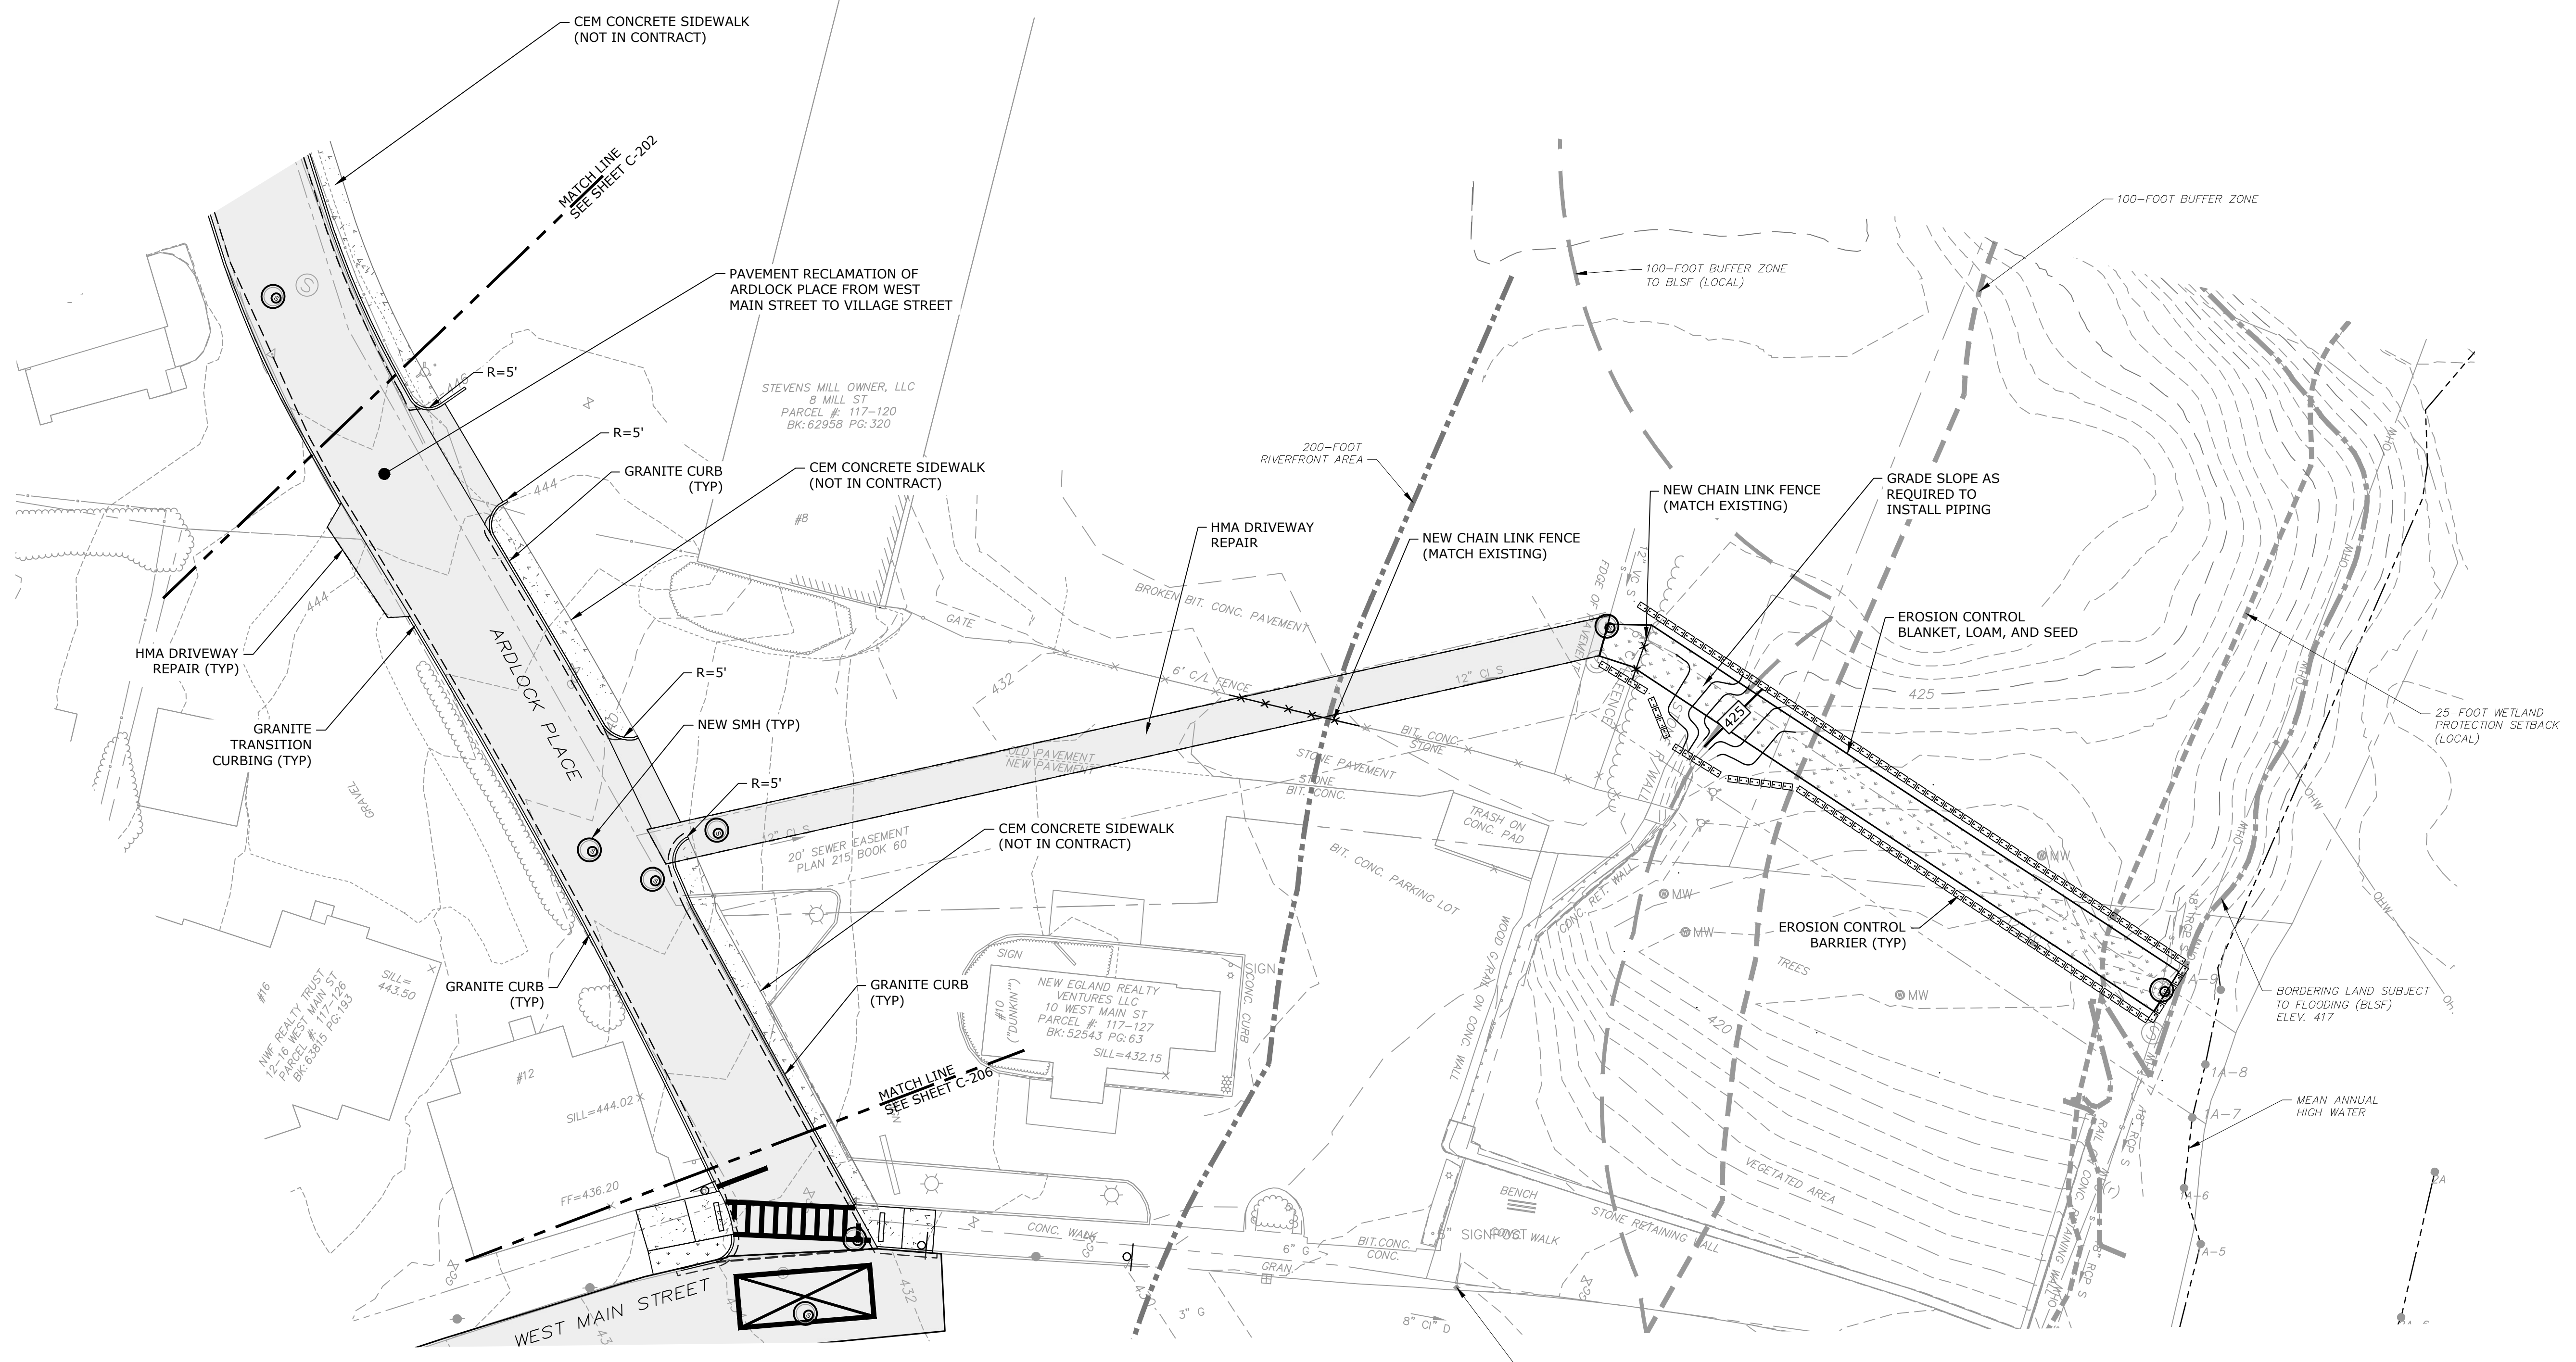

T.B.M. RAILROAD SPIKE IN UP 1  
ELEV. = 429.16

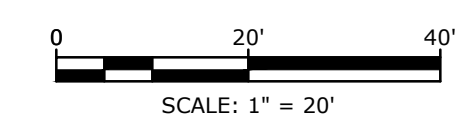

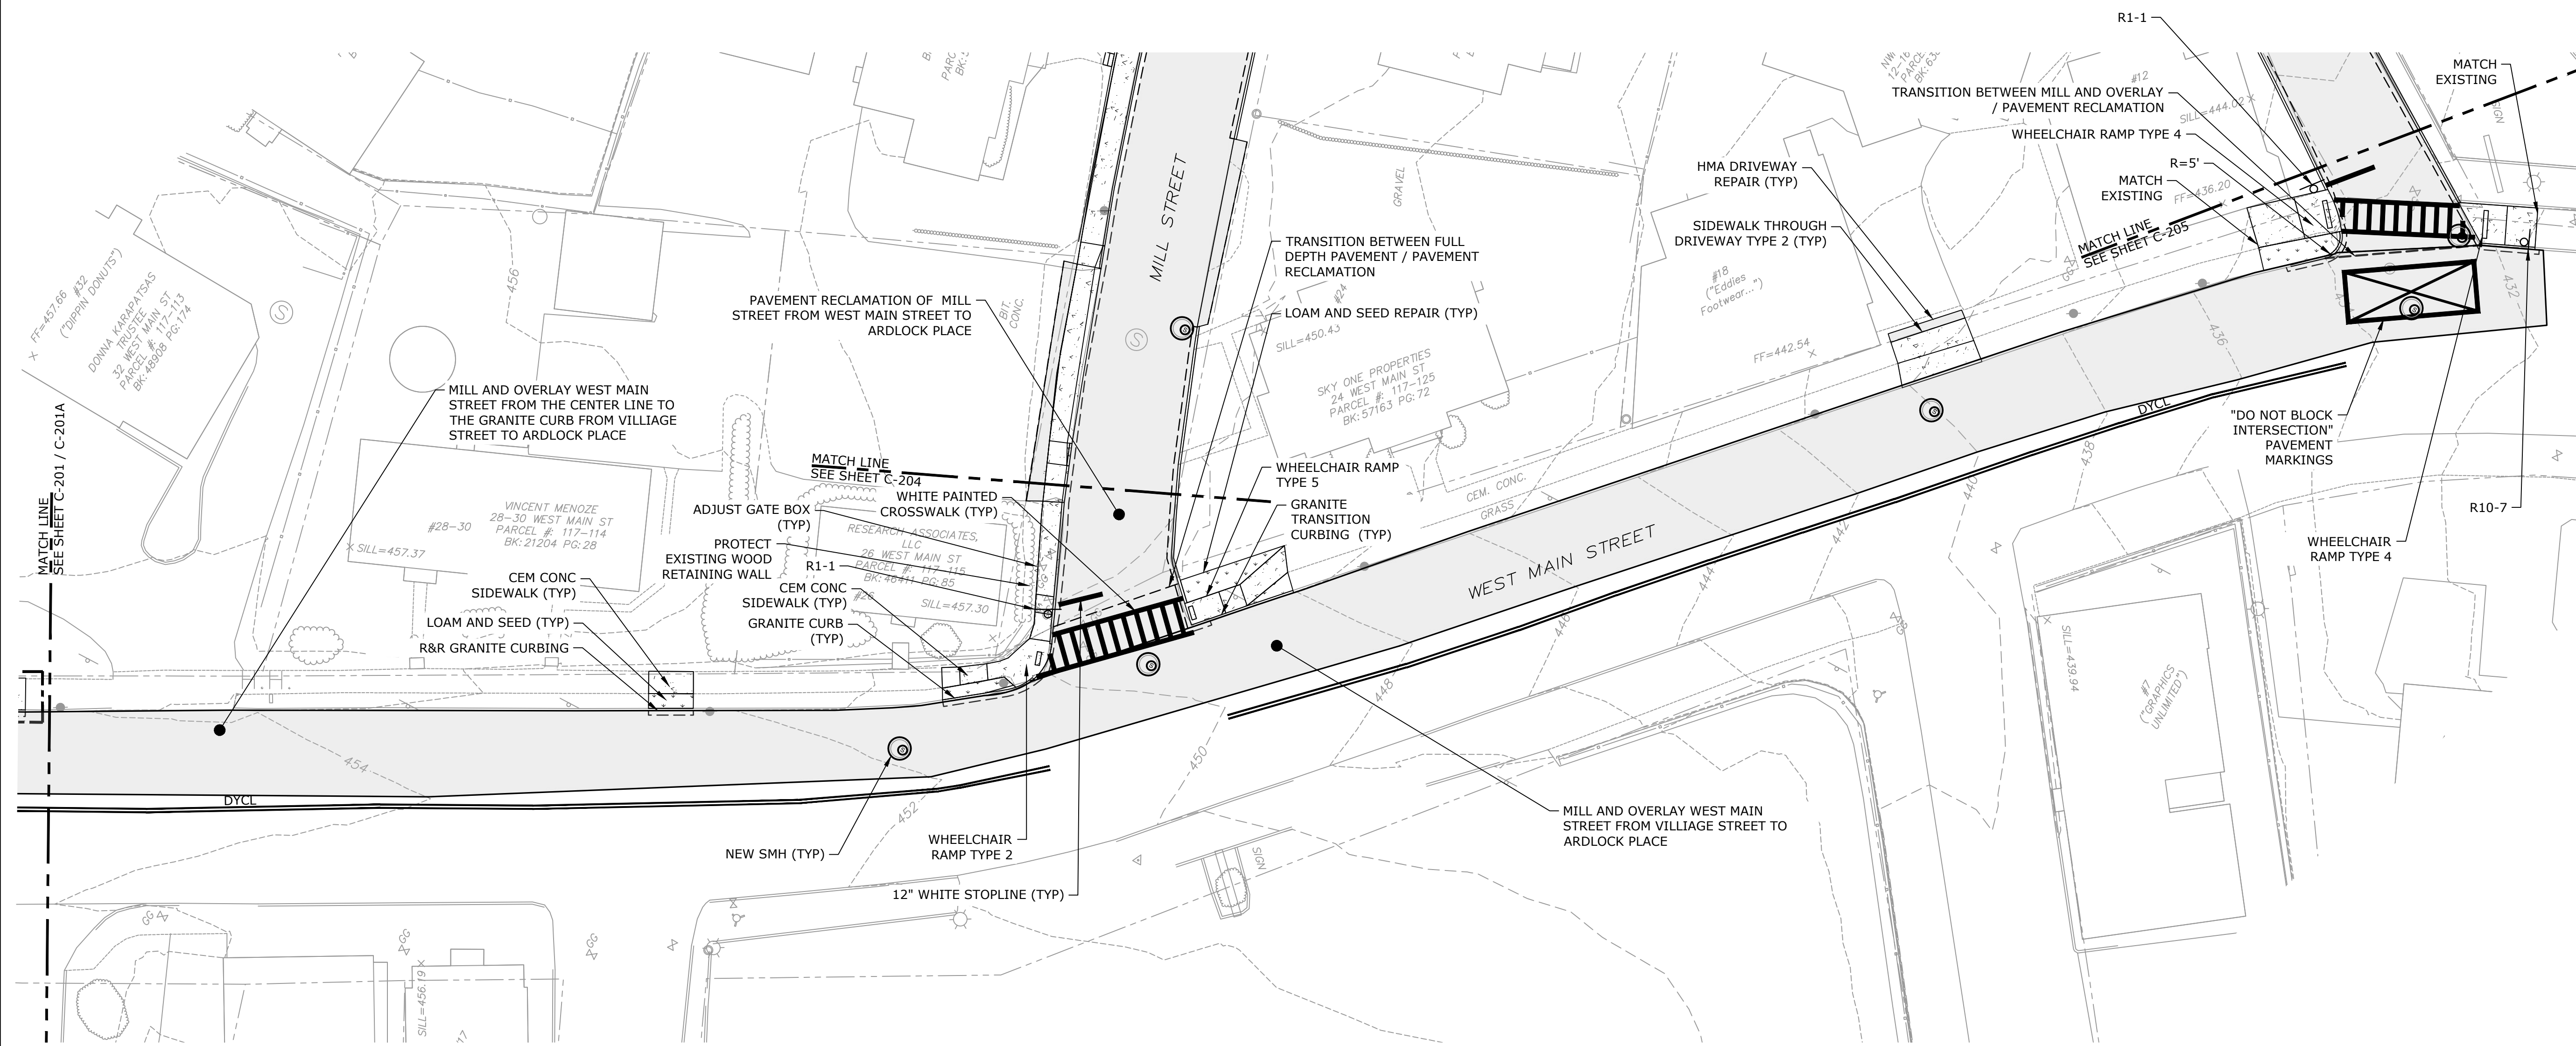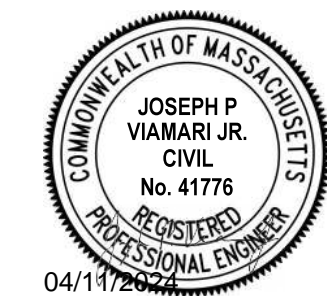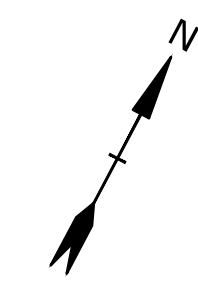

**Stevens Mill  
Sewer and  
Sidewalk  
Replacement  
Project**

Town of Dudley


Dudley, MA

MARK	DATE	DESCRIPTION
0	04/10/2024	ISSUED FOR BIDDING

PROJECT NO: D5011-018  
 DATE: 04/2024  
 FILE: D5011-018 Proposed.dwg  
 DRAWN BY: ND/ABS  
 CHECKED BY: MPW  
 APPROVED BY: JPV


SITE LAYOUT AND  
IMPROVEMENTS PLAN - 6

SCALE: AS SHOWN

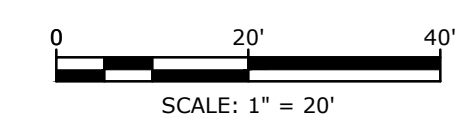

C-206

Last Saved: 4/10/2024 11:57am By: NBay  
 Plotted On: Apr 10, 2024 11:57am  
 File: C:\Users\NBay\OneDrive\Documents\Drawings\Figures\AutoCAD\Sheet\DS011\_018\_Proposed.dwg

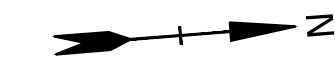

**Stevens Mill  
Sewer and  
Sidewalk  
Replacement  
Project**

Town of Dudley

Dudley, MA


0	04/10/2024	ISSUED FOR BIDDING
MARK	DATE	DESCRIPTION
PROJECT NO:	D5011-018	
DATE:	04/2024	
FILE:	D5011-018 Proposed.dwg	
DRAWN BY:	ND/ABS	
CHECKED BY:	MPW	
APPROVED BY:	JPV	

**SEWER LAYOUT OVERALL  
SITE PLAN**

SCALE: AS SHOWN


**C-300**




**LEGEND**

C-### PLAN AND PROFILE

SS PROPOSED SEWER PIPE


SS EXISTING SEWER PIPE

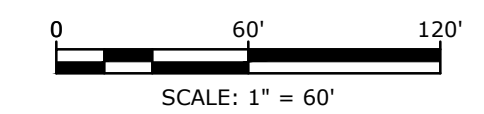

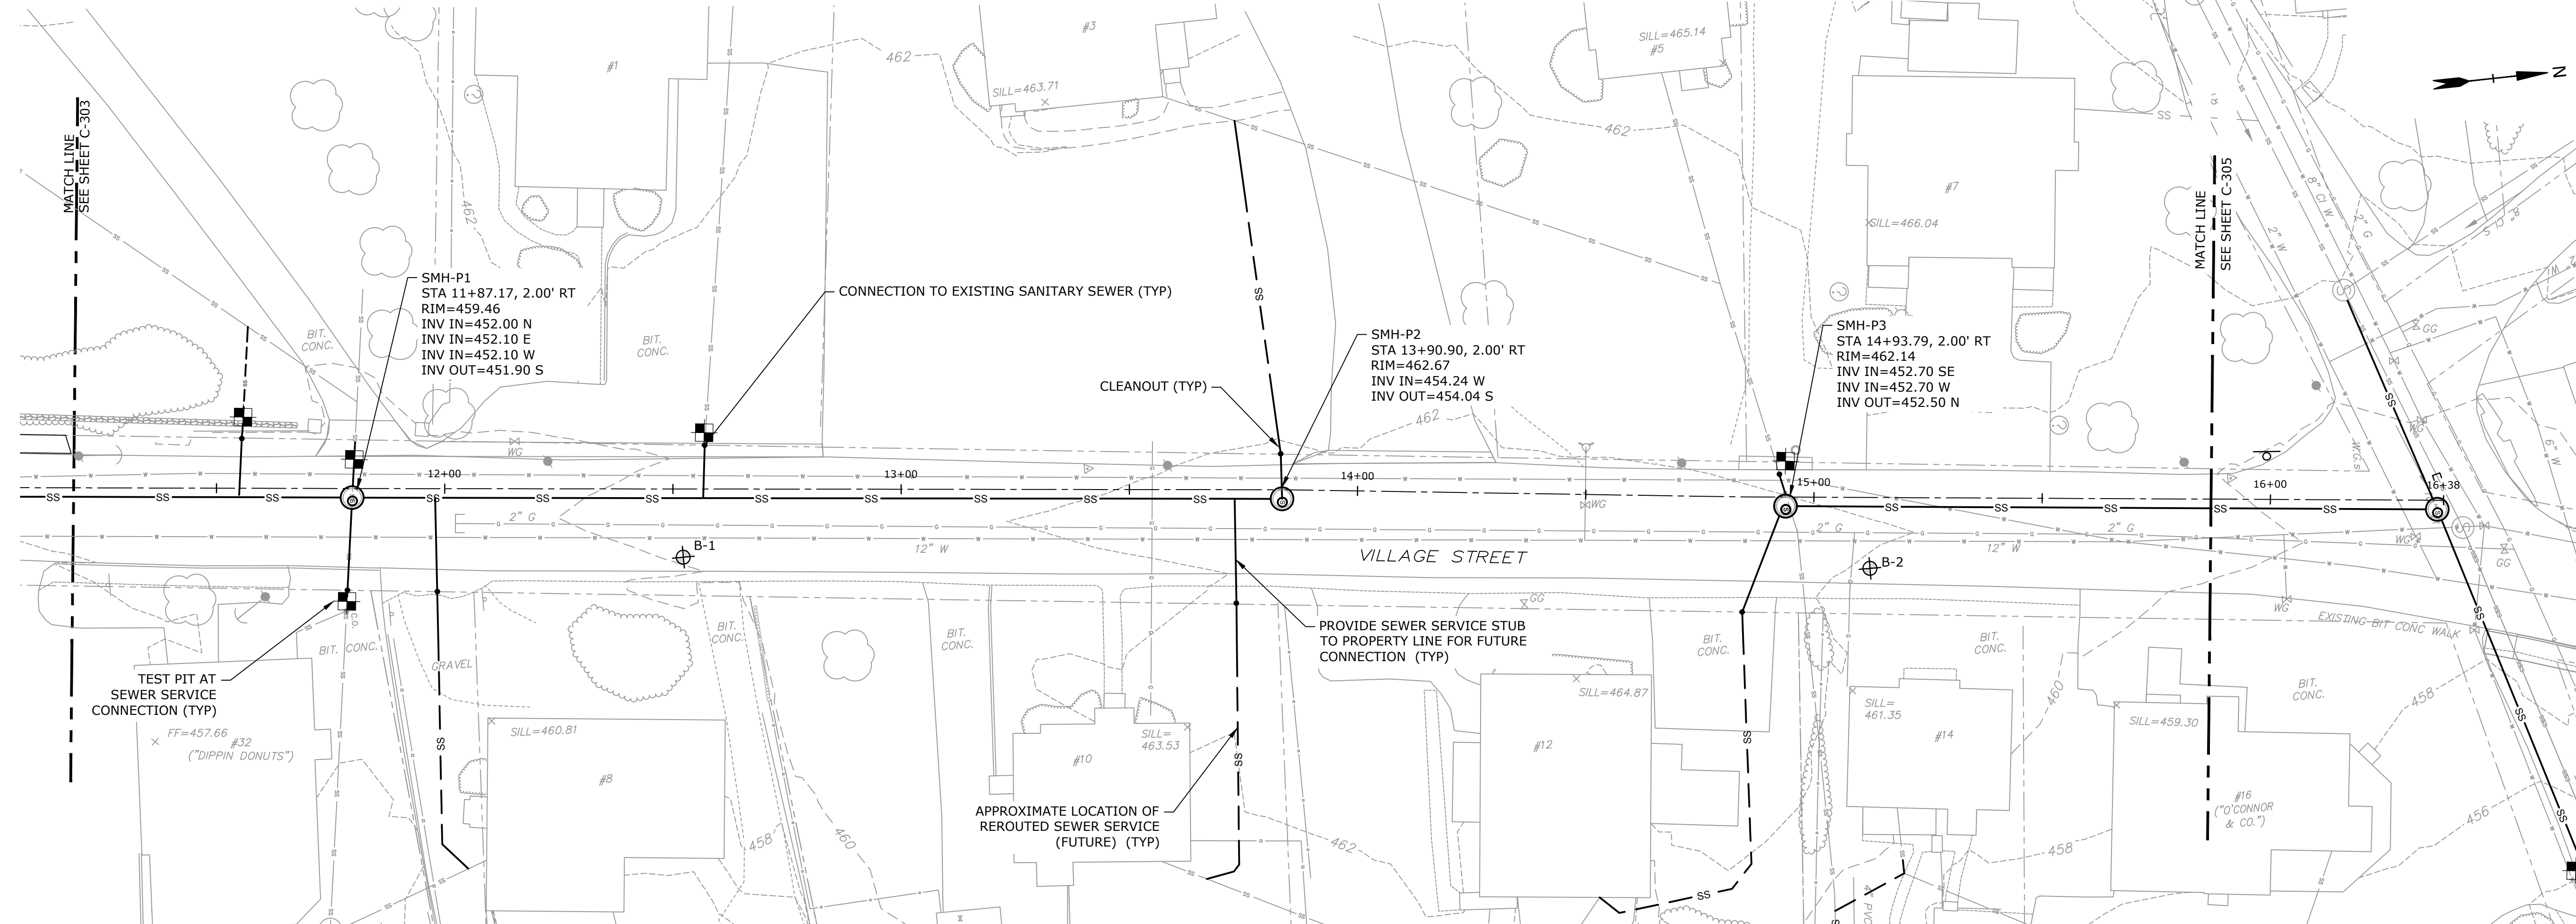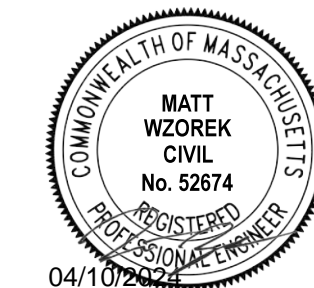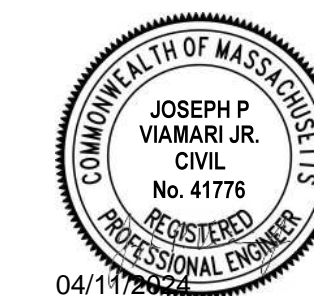

**NOTES:**  
 1. PERFORM TEST PIT EXCAVATIONS TO CONFIRM THE SIZE, MATERIAL AND ELEVATION OF EACH EXISTING SEWER SERVICE PRIOR TO INSTALLING SEWER MAIN.

**VILLAGE STREET SEWER LAYOUT PLAN**  
 1" = 20'

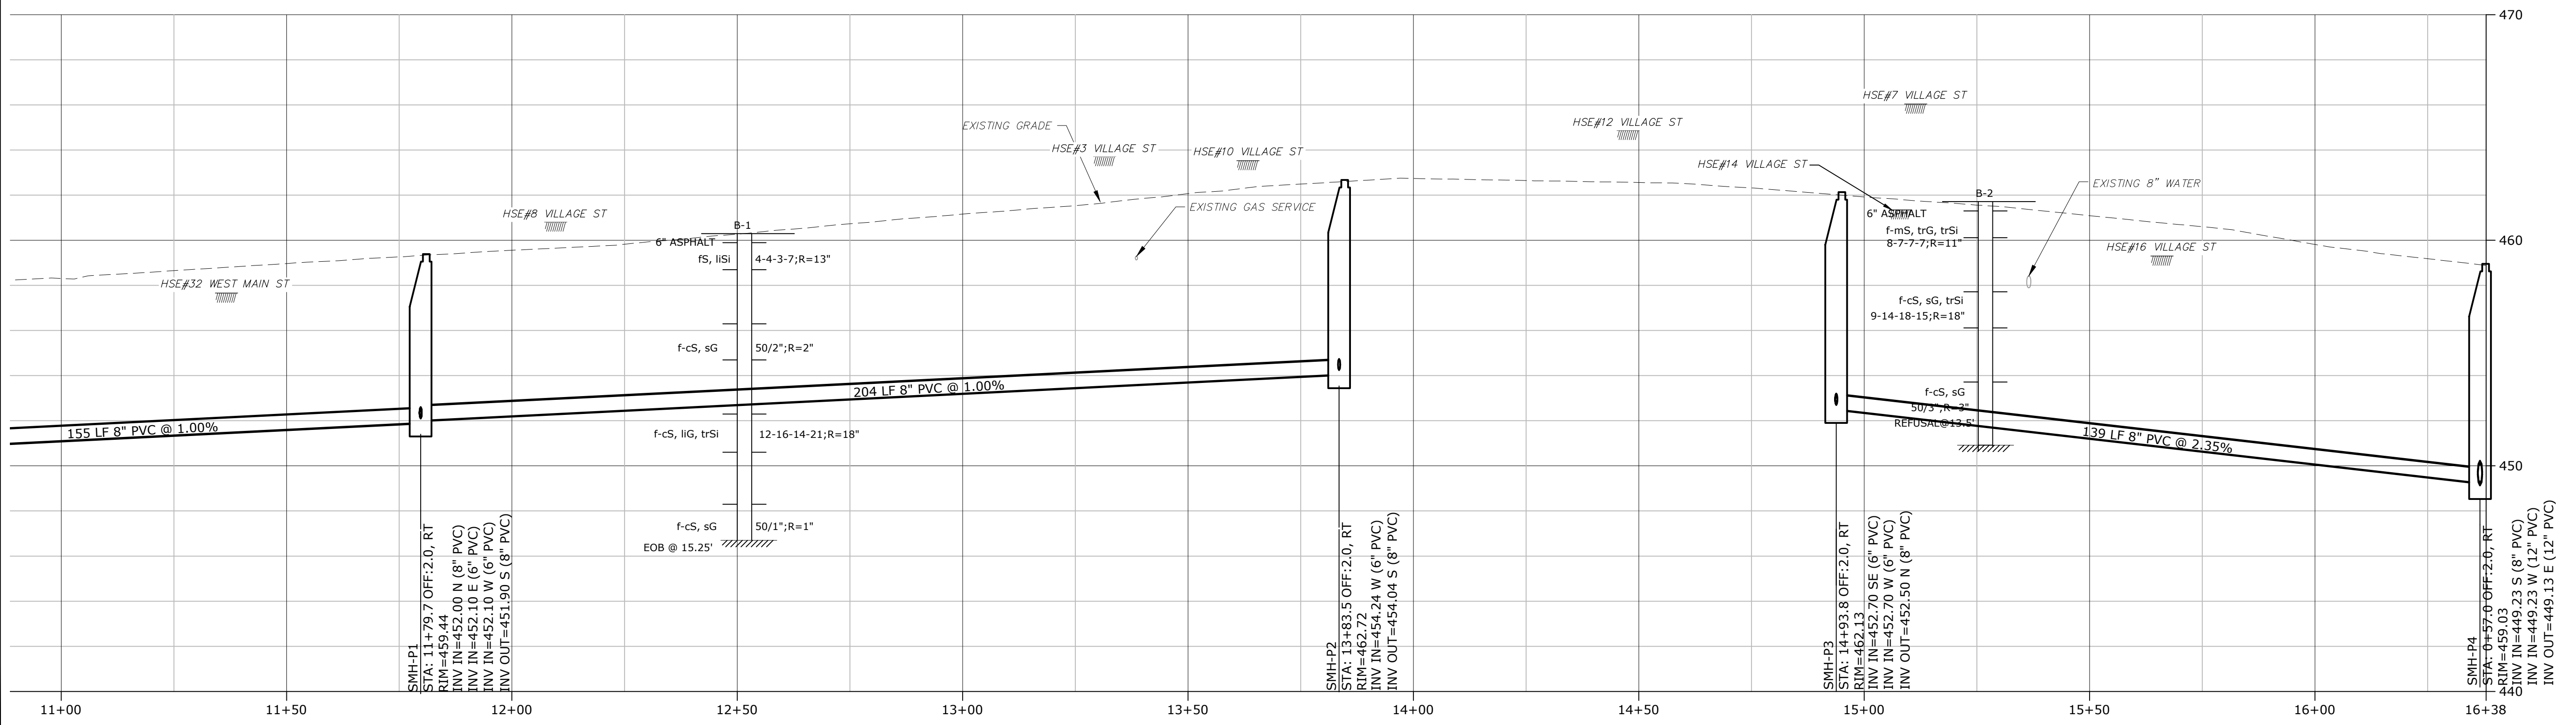

**VILLAGE STREET SEWER PROFILE**  
 HORIZONTAL SCALE: 1" = 20' VERTICAL SCALE: 1" = 4'

**Stevens Mill Sewer and Sidewalk Replacement Project**

Town of Dudley



Dudley, MA

0	04/10/2024	ISSUED FOR BIDDING
MARK	DATE	DESCRIPTION
PROJECT NO: D5011-018		
DATE: 04/2024		
FILE: D5011-018 Proposed.dwg		
DRAWN BY: ND/ABS		
CHECKED BY: MPW		
APPROVED BY: JPV		

**VILLAGE STREET SEWER PLAN AND PROFILE**


SCALE: HORIZ. 1" = 20'; VERT. 1" = 4'

Last Saved: 4/10/2024 11:57am By: NBay  
 Plotted On: Apr 10, 2024 11:57am  
 Figure & Legend: 3:10:00 PM 04/10/24 Stevens Mill Sewer and Sidewalk Replacement - Figures AutoCAD Sheet (D5011\_018 Proposed.dwg)

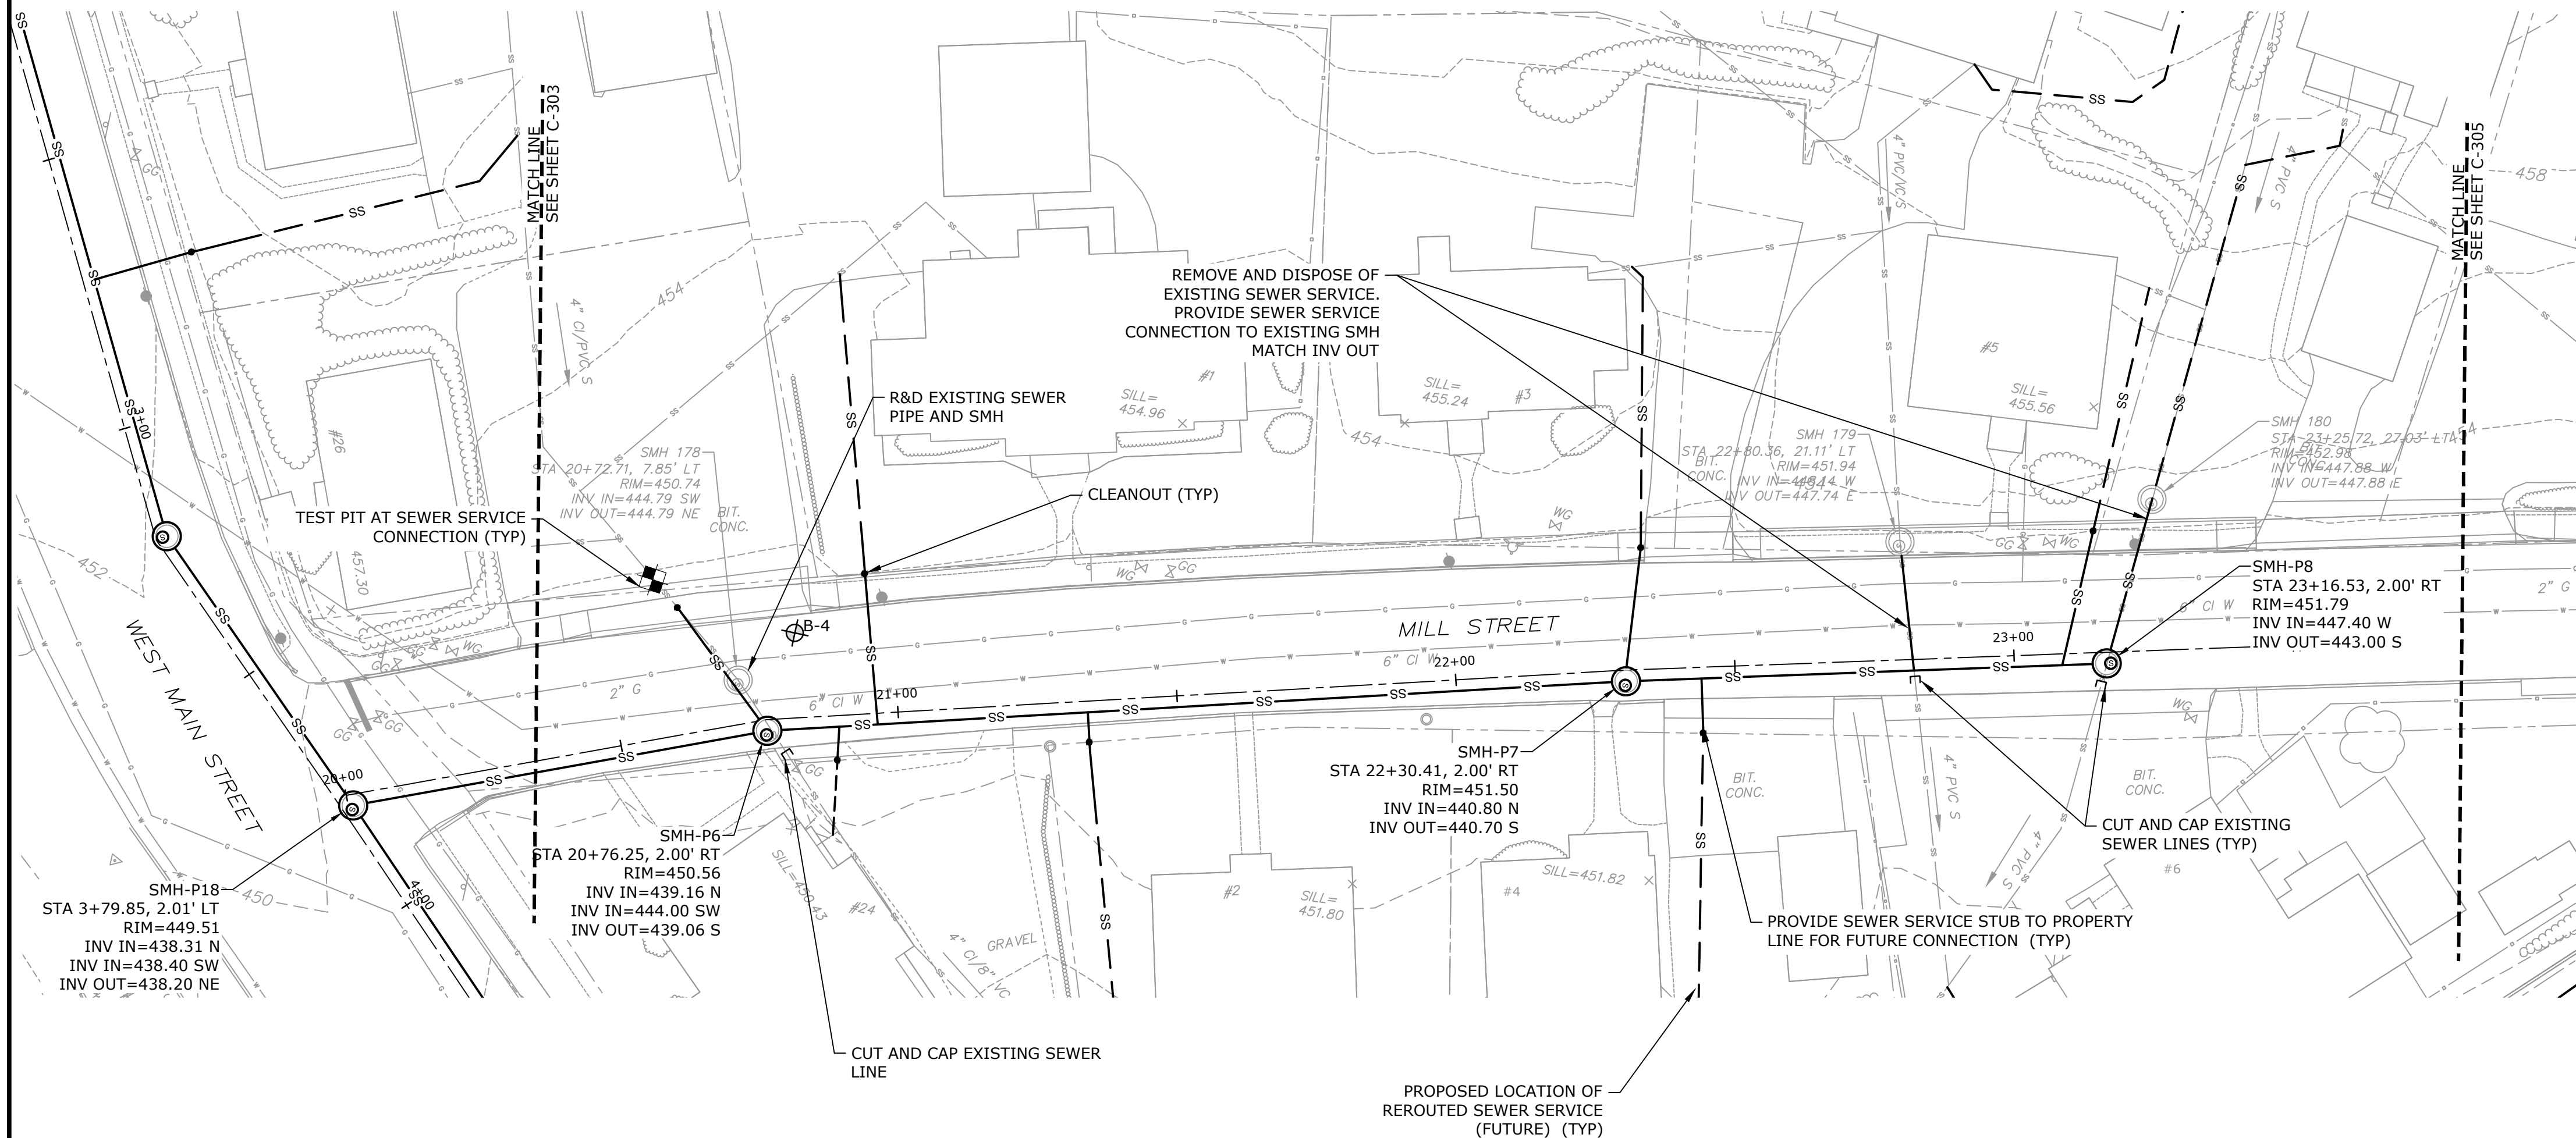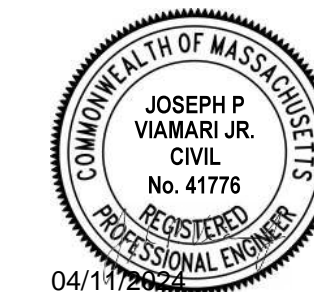

- NOTES:**
- PERFORM TEST PIT EXCAVATIONS TO CONFIRM THE SIZE, MATERIAL AND ELEVATION OF EACH EXISTING SEWER SERVICE PRIOR TO INSTALLING SEWER MAIN.

**MILL STREET SEWER LAYOUT PLAN**  
1" = 20'

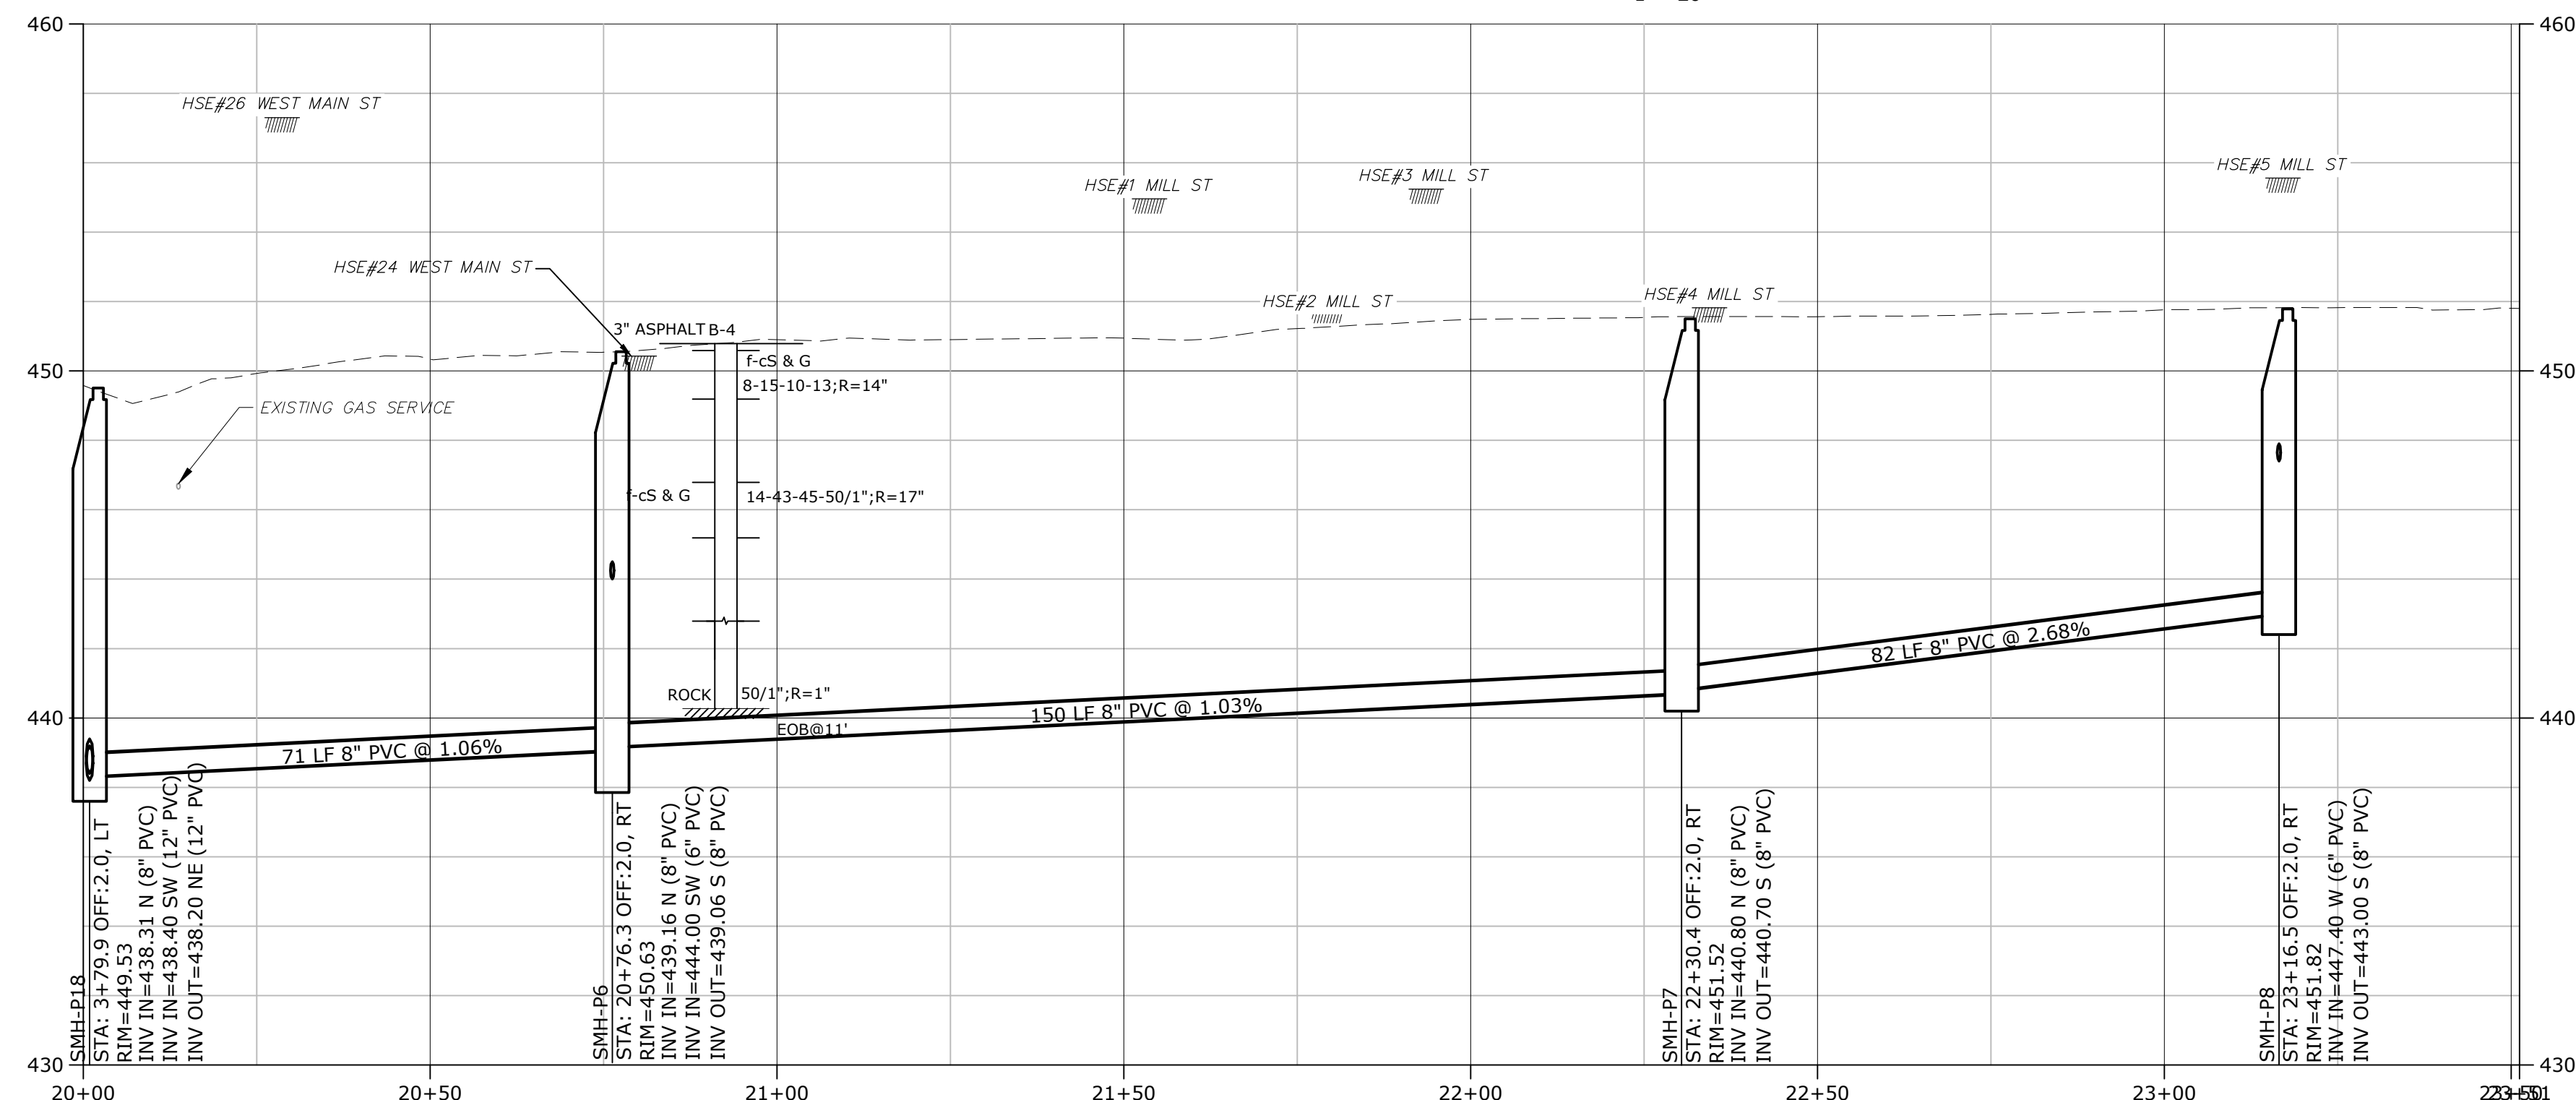

**MILL STREET SEWER PROFILE**  
HORIZONTAL SCALE: 1" = 20' VERTICAL SCALE: 1" = 4'



**Stevens Mill Sewer and Sidewalk Replacement Project**

Town of Dudley




Dudley, MA

MARK	DATE	DESCRIPTION
0	04/10/2024	ISSUED FOR BIDDING
PROJECT NO: D5011-018		
DATE: 04/2024		
FILE: D5011-018 Proposed.dwg		
DRAWN BY: ND/ABS		
CHECKED BY: MPW		
APPROVED BY: JPV		


**MILL STREET SEWER PLAN AND PROFILE**

SCALE: HORIZ. 1" = 20'; VERT. 1" = 4'

**C-302**

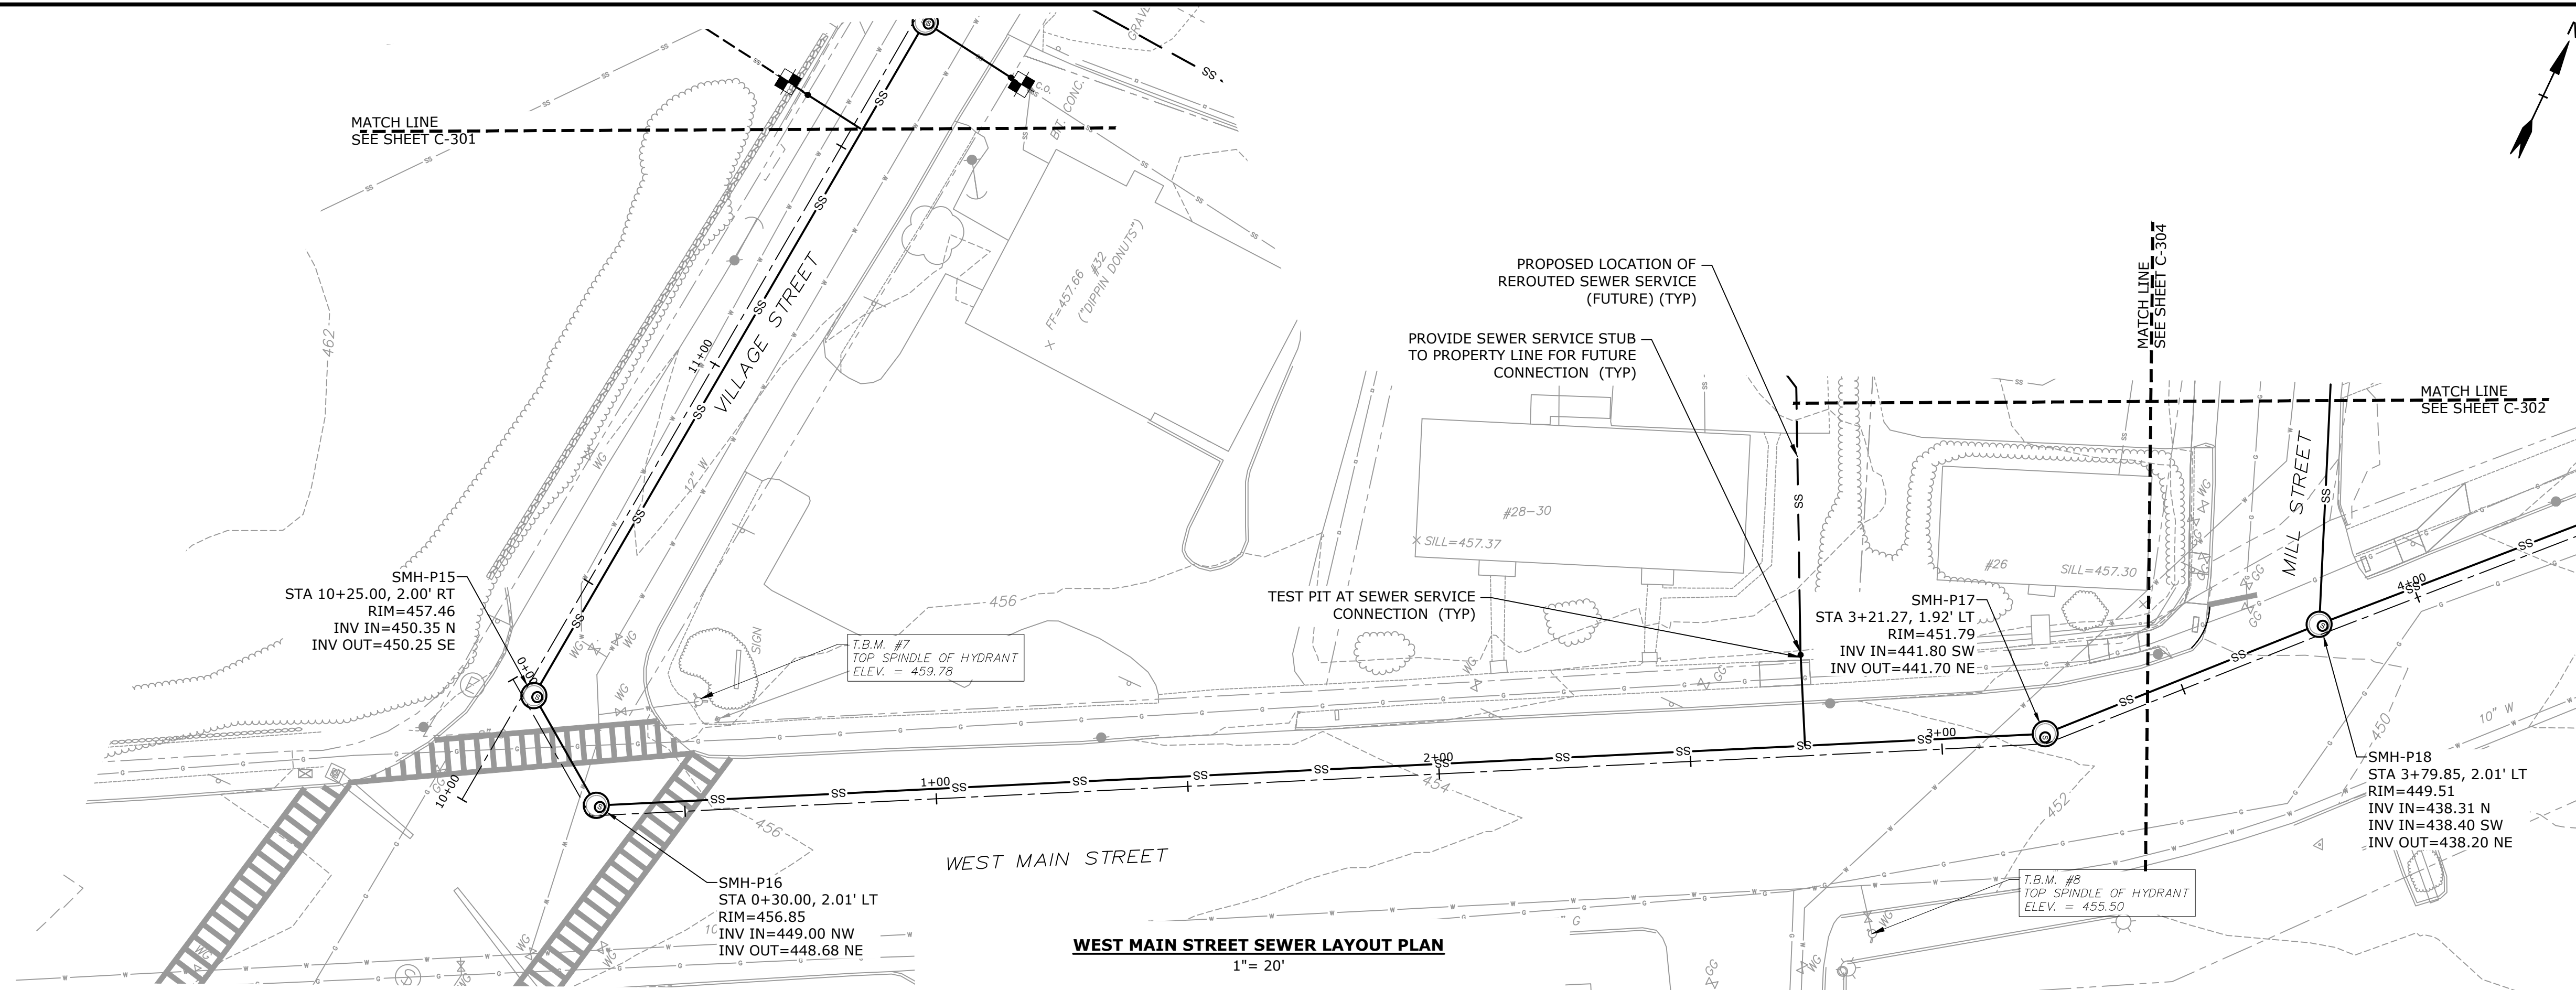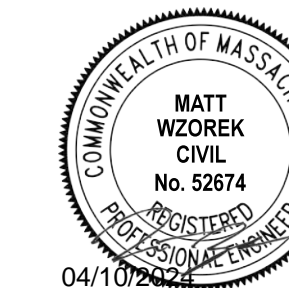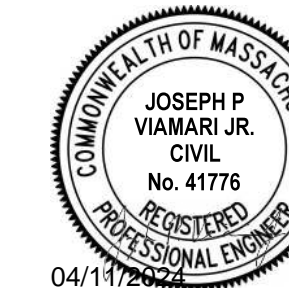

**NOTES:**  
 1. PERFORM TEST PIT EXCAVATIONS TO CONFIRM THE SIZE, MATERIAL AND ELEVATION OF EACH EXISTING SEWER SERVICE PRIOR TO INSTALLING SEWER MAIN.

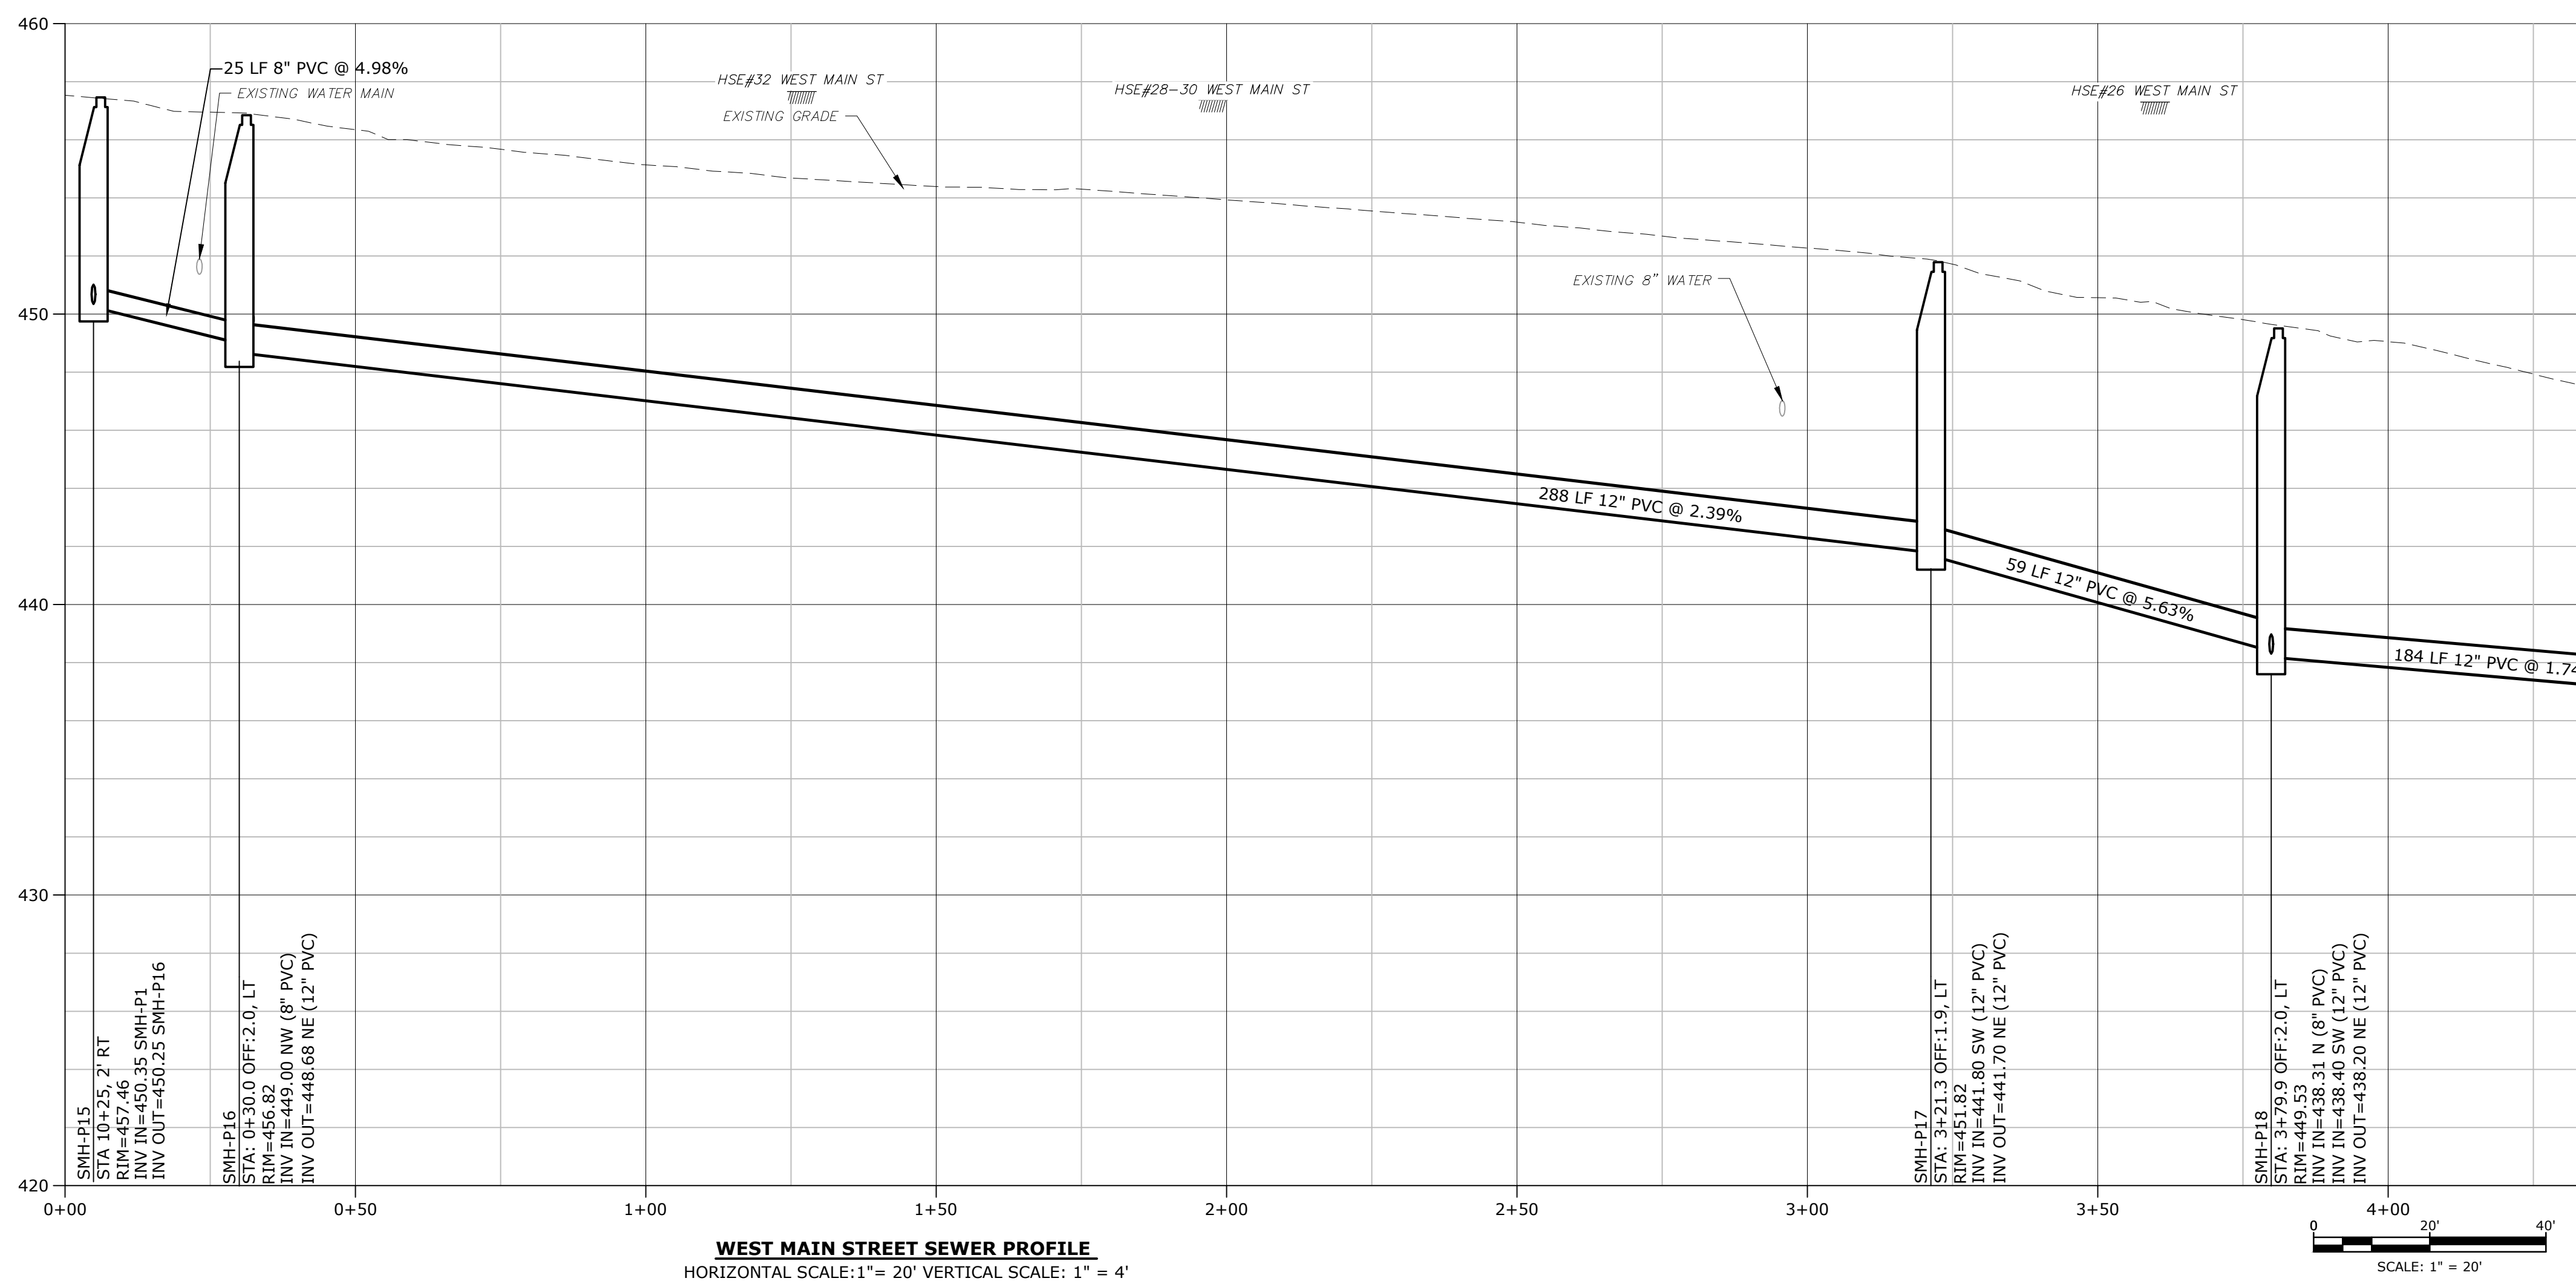

**Stevens Mill Sewer and Sidewalk Replacement Project**

Town of Dudley

Dudley, MA

MARK	DATE	ISSUED FOR BIDDING	DESCRIPTION
0	04/10/2024	ISSUED FOR BIDDING	



PROJECT NO: D5011-018  
 DATE: 04/2024  
 FILE: D5011-018 Proposed.dwg  
 DRAWN BY: ND/ABS  
 CHECKED BY: MPW  
 APPROVED BY: JPV

**WEST MAIN STREET SEWER PLAN AND PROFILE-1**

SCALE: HORIZ. 1"=20'; VERT. 1"=4'

Last Saved: 4/10/2024 11:59am By: NBay  
 Plotted On: Apr 10, 2024 11:59am  
 File & Server: Z:\05211 Dudley\05211 Stevens Mill MassWorks\Drawings\_Figures\AutoCAD\Sheet\DS011\_018\_Proposed.dwg



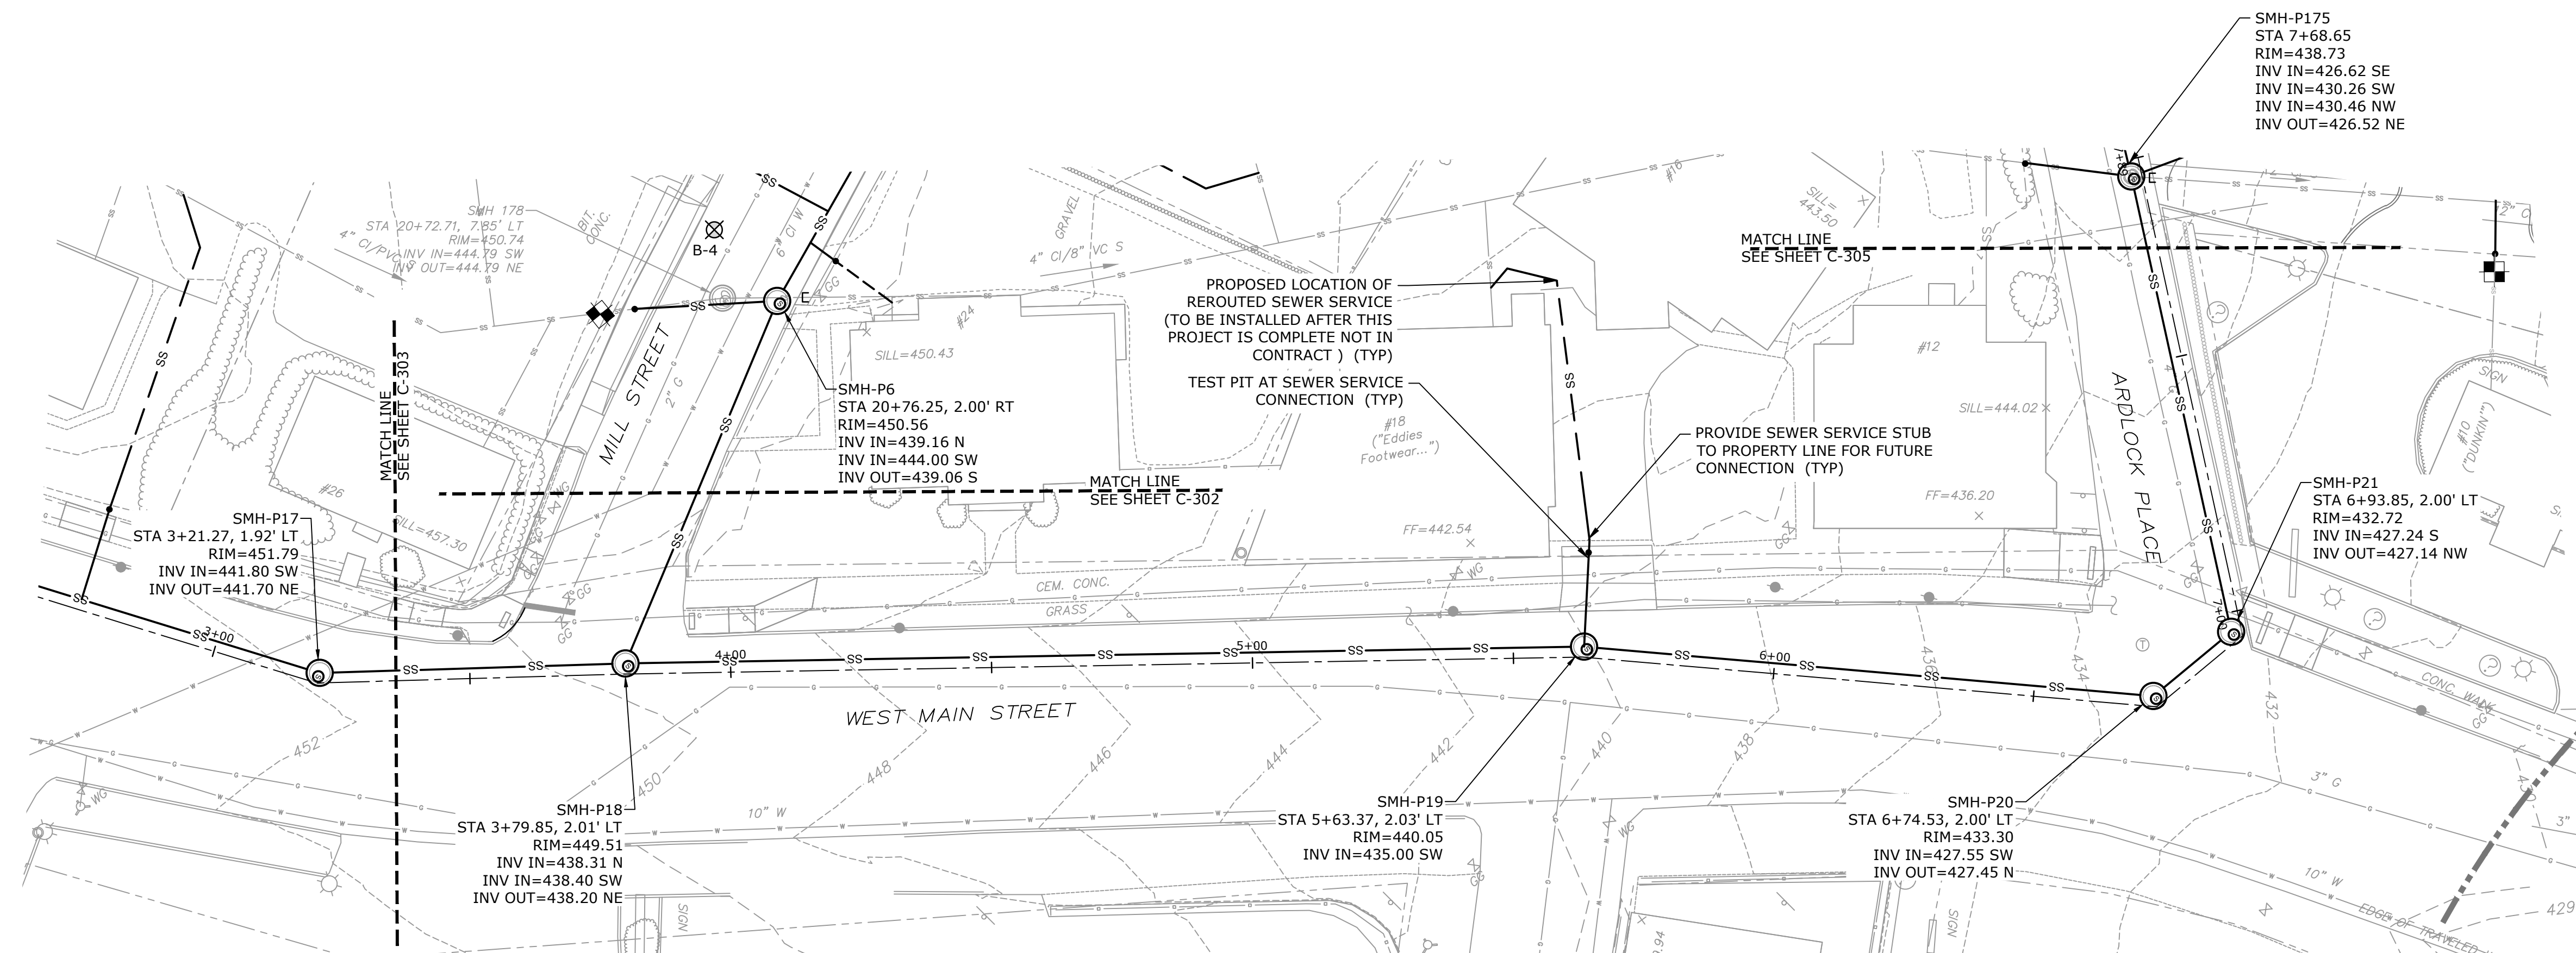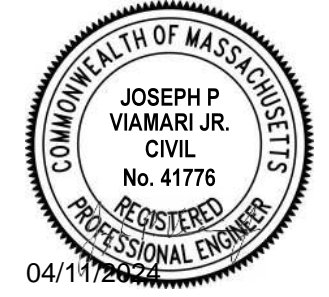


WEST MAIN STREET SEWER LAYOUT PLAN

1" = 20'

NOTES:

1. PERFORM TEST PIT EXCAVATIONS TO CONFIRM THE SIZE, MATERIAL AND ELEVATION OF EACH EXISTING SEWER SERVICE PRIOR TO INSTALLING SEWER MAIN.

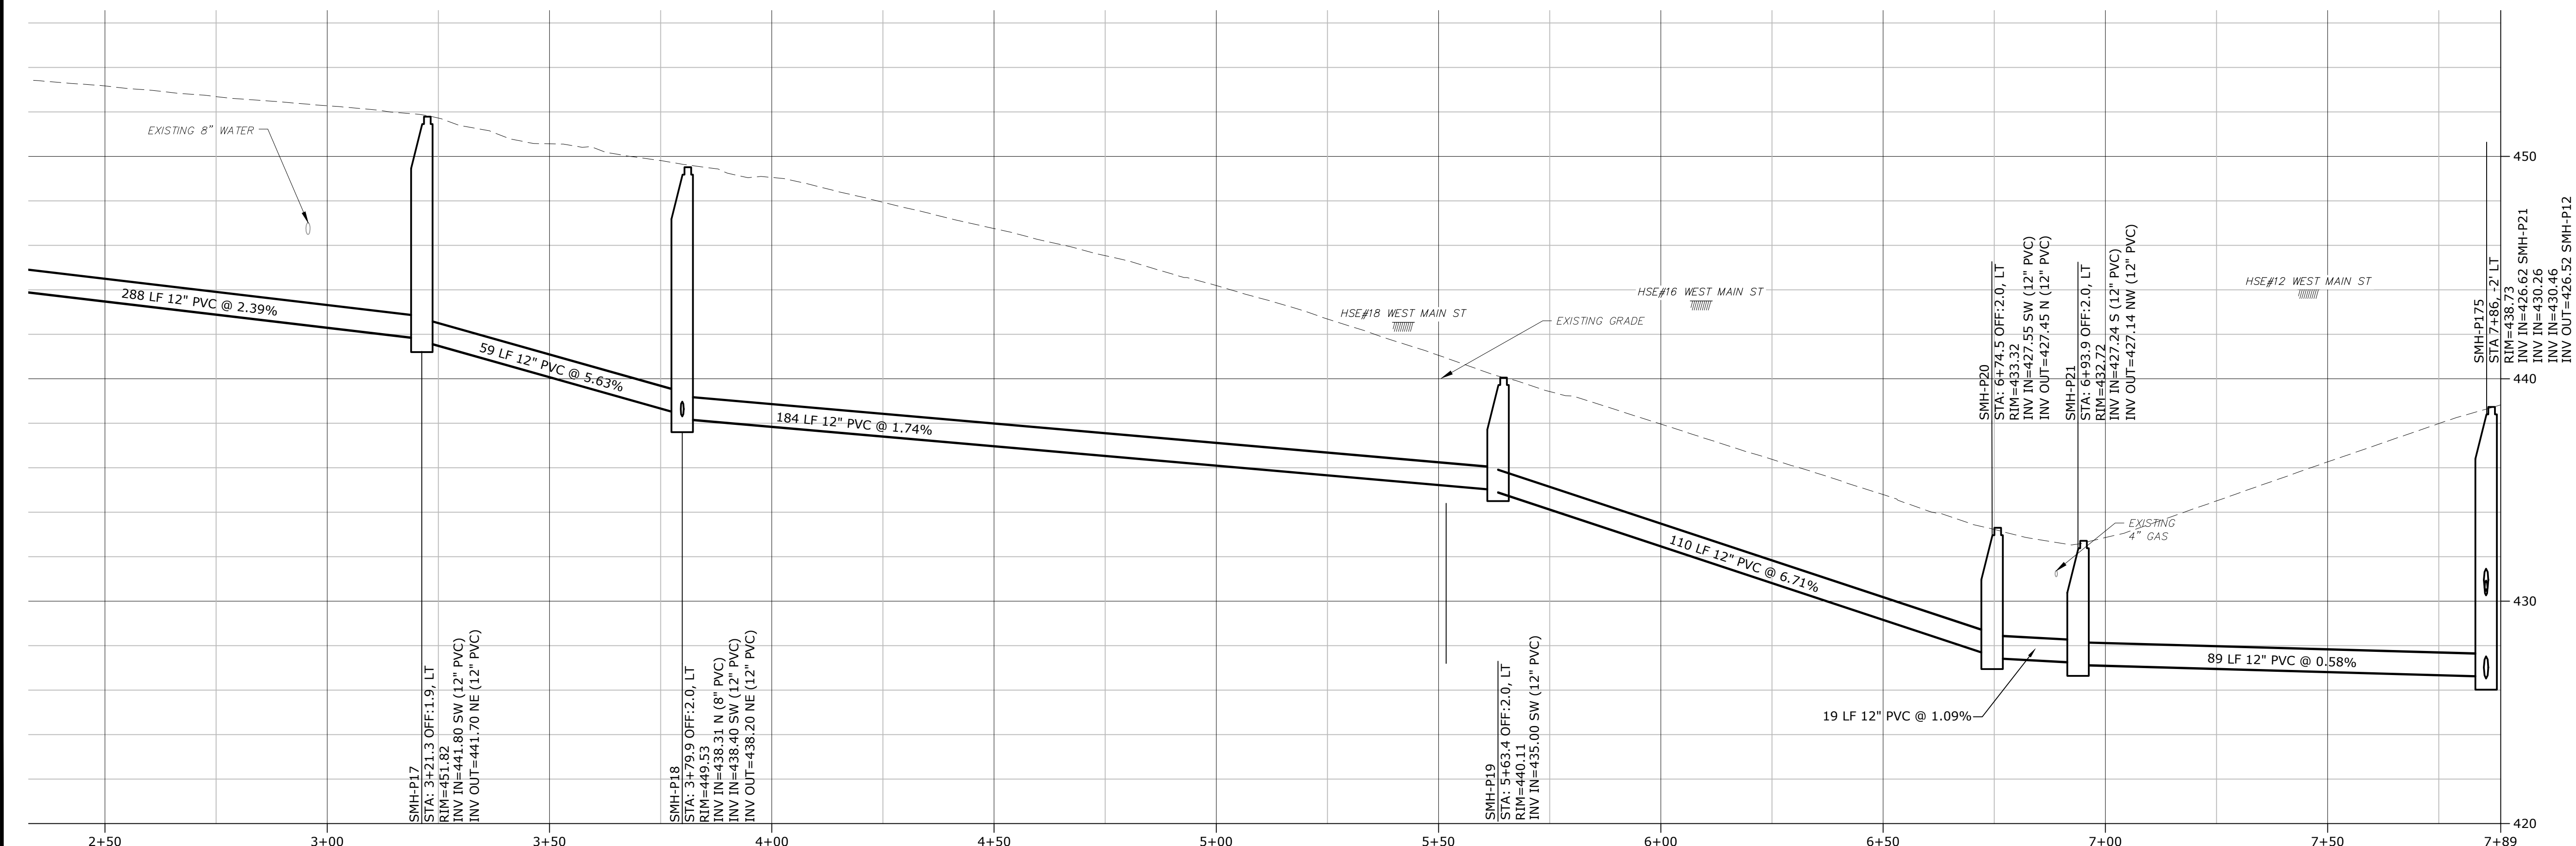

WEST MAIN STREET SEWER PROFILE

HORIZONTAL SCALE: 1" = 20' VERTICAL SCALE: 1" = 4'



Stevens Mill Sewer and Sidewalk Replacement Project

Town of Dudley

Dudley, MA




MARK	DATE	DESCRIPTION
0	04/10/2024	ISSUED FOR BIDDING

PROJECT NO: D5011-018  
 DATE: 04/2024  
 FILE: D5011-018 Proposed.dwg  
 DRAWN BY: ND/ABS  
 CHECKED BY: MPW  
 APPROVED BY: JPV

WEST MAIN STREET SEWER PLAN AND PROFILE-2

SCALE: HORIZ. 1" = 20'; VERT. 1" = 4'

Last Saved: 4/10/2024 11:59am By: NBay  
 Plotted On: Apr 10, 2024 11:59am  
 File & Server Path: D:\Projects\2024\0410\2411\Stevens Mill Sewer and Sidewalk Replacement\Drawings\Figures\AutoCAD\Sheet\DS011\_018\_Proposed.dwg

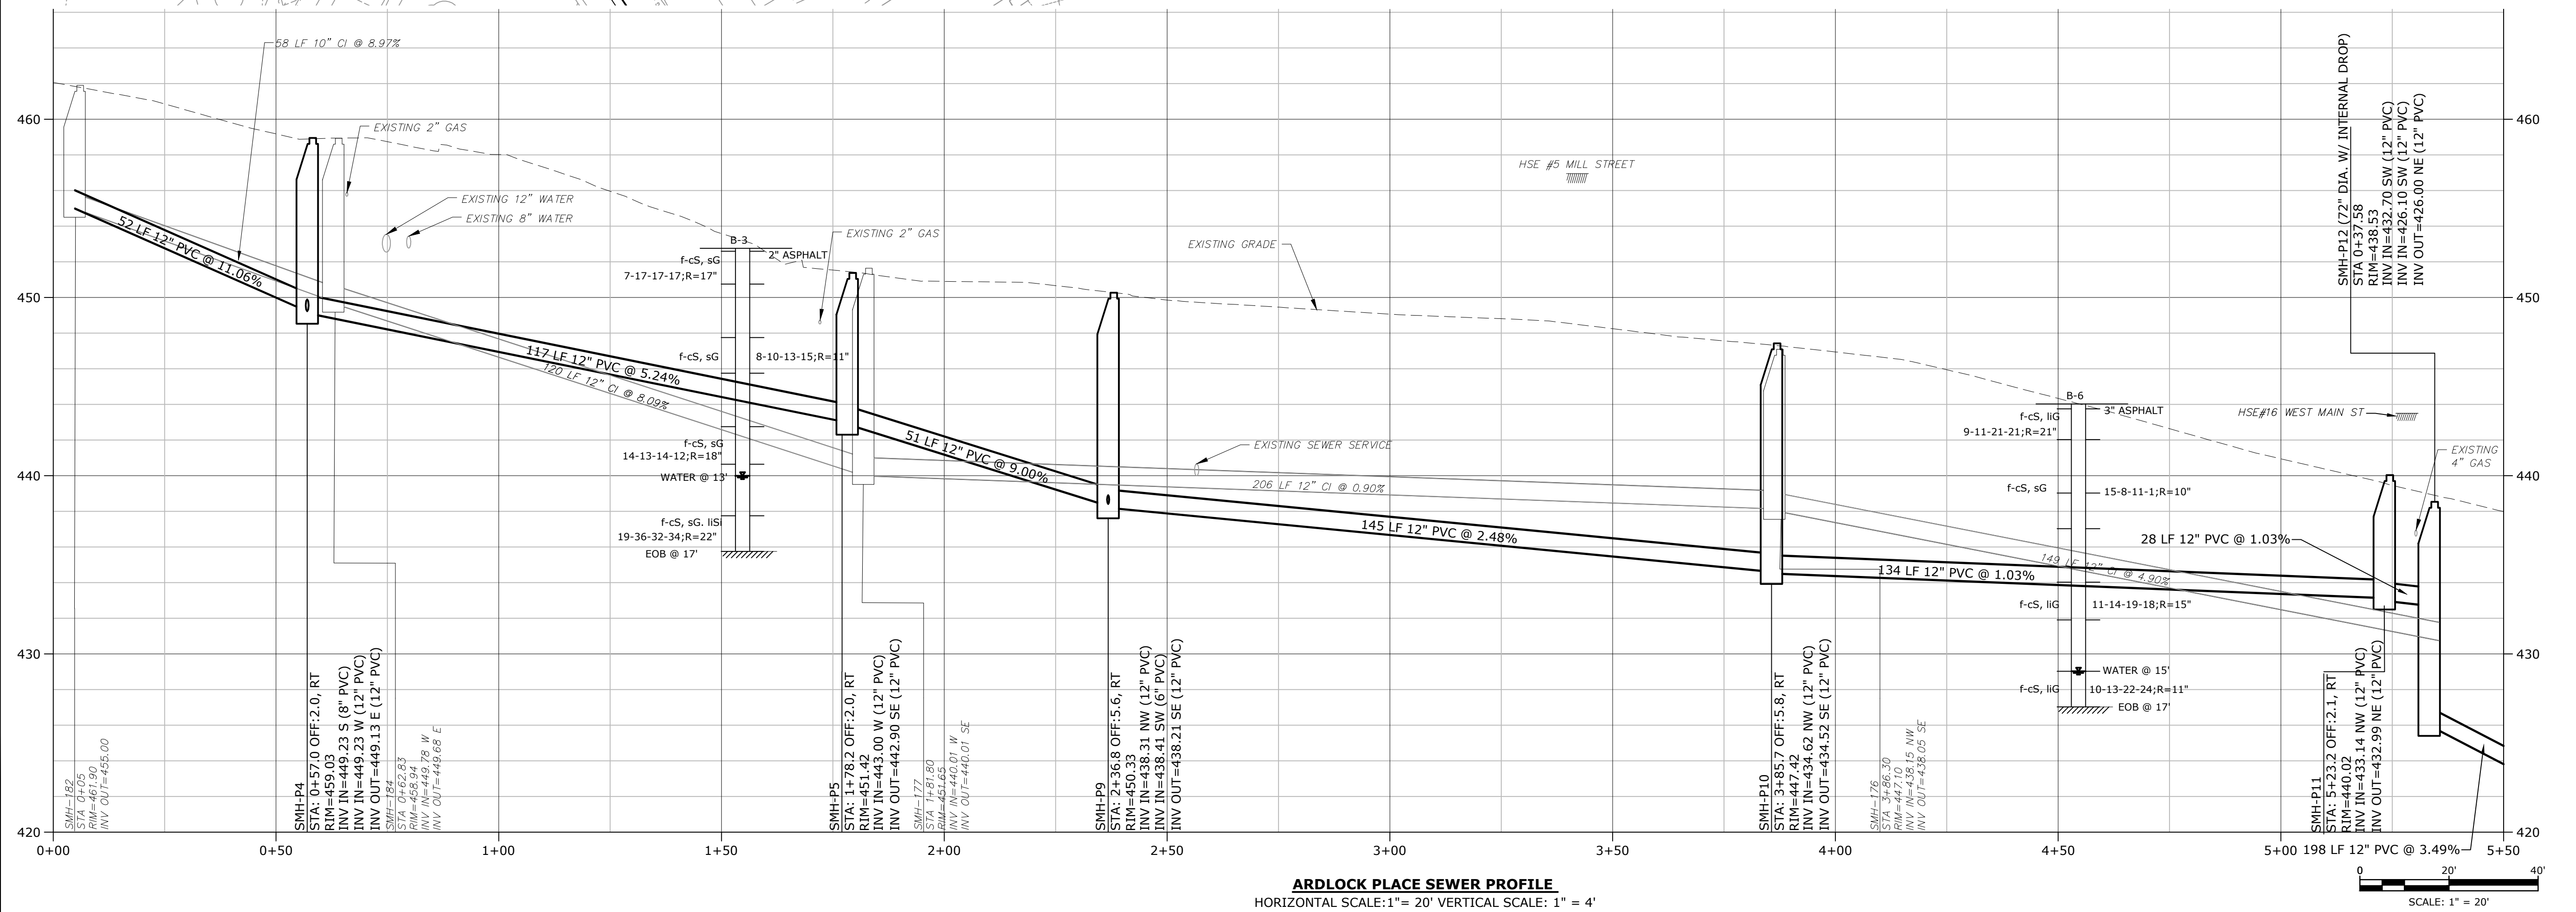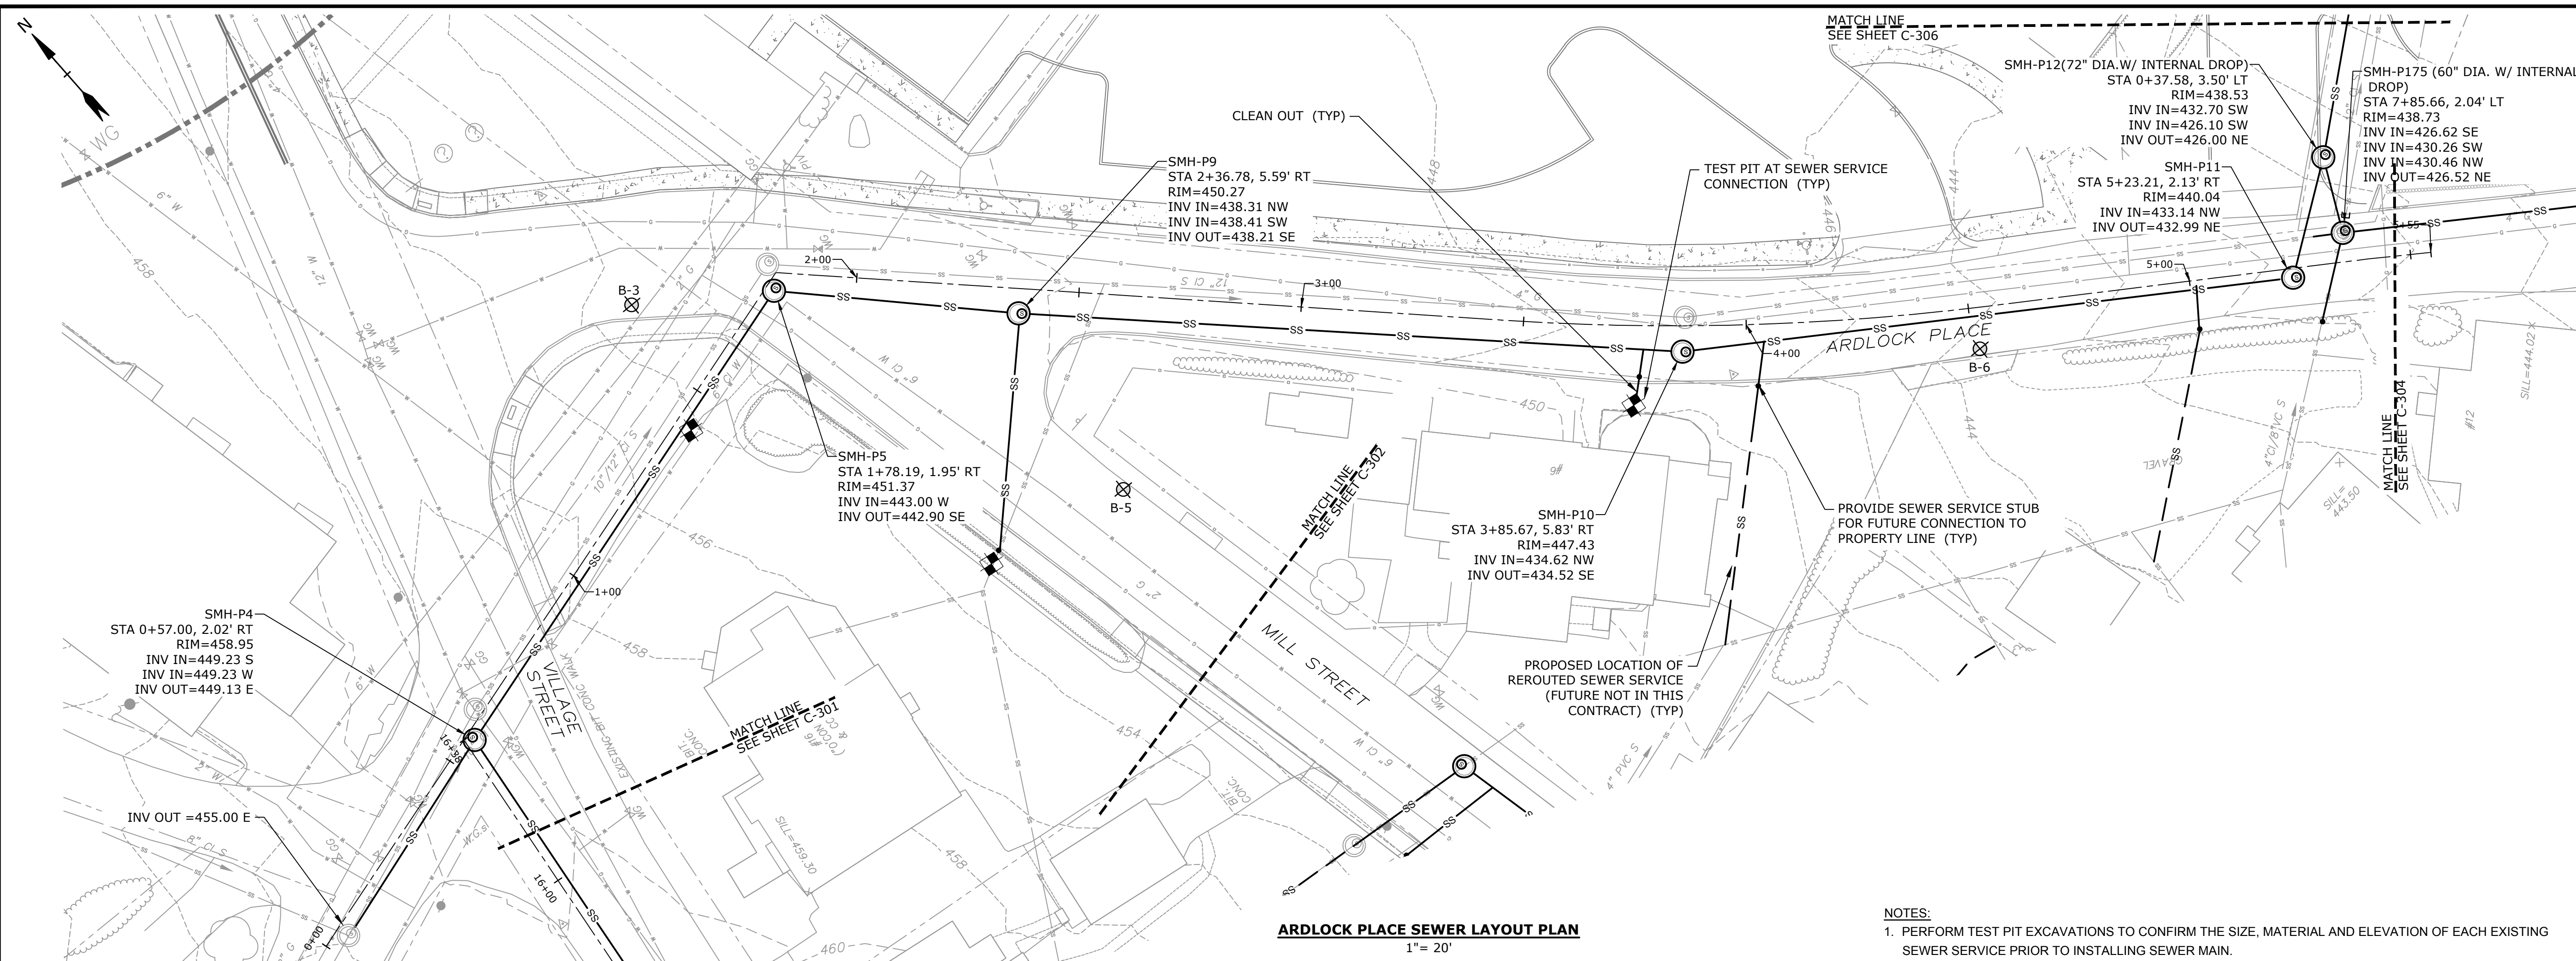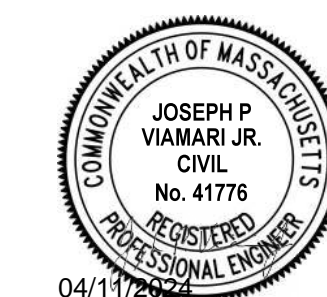

**Stevens Mill Sewer and Sidewalk Replacement Project**

Town of Dudley



Dudley, MA

0	04/10/2024	ISSUED FOR BIDDING
MARK	DATE	DESCRIPTION
PROJECT NO:	D5011-018	
DATE:	04/2024	
FILE:	D5011-018 Proposed.dwg	
DRAWN BY:	ND/ABS	
CHECKED BY:	MPW	
APPROVED BY:	JPV	


**ARDLOCK PLACE SEWER PLAN AND PROFILE-1**

SCALE: HORIZ. 1" = 20'; VERT. 1" = 4'

Last Saved: 4/10/2024 12:00pm By: NBay  
 Plotted On: Apr 10, 2024 4:12:00pm By: NBay  
 File: C:\Users\NBay\OneDrive\Documents\Drawings\Figures\AutoCAD\Sheet\DS011\_018\_Proposed.dwg

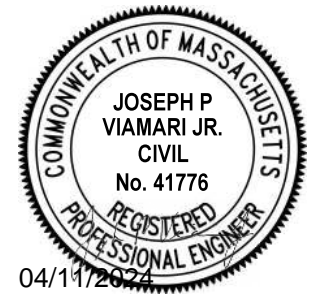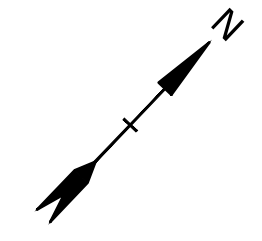


MATCH LINE  
SEE SHEET C-304

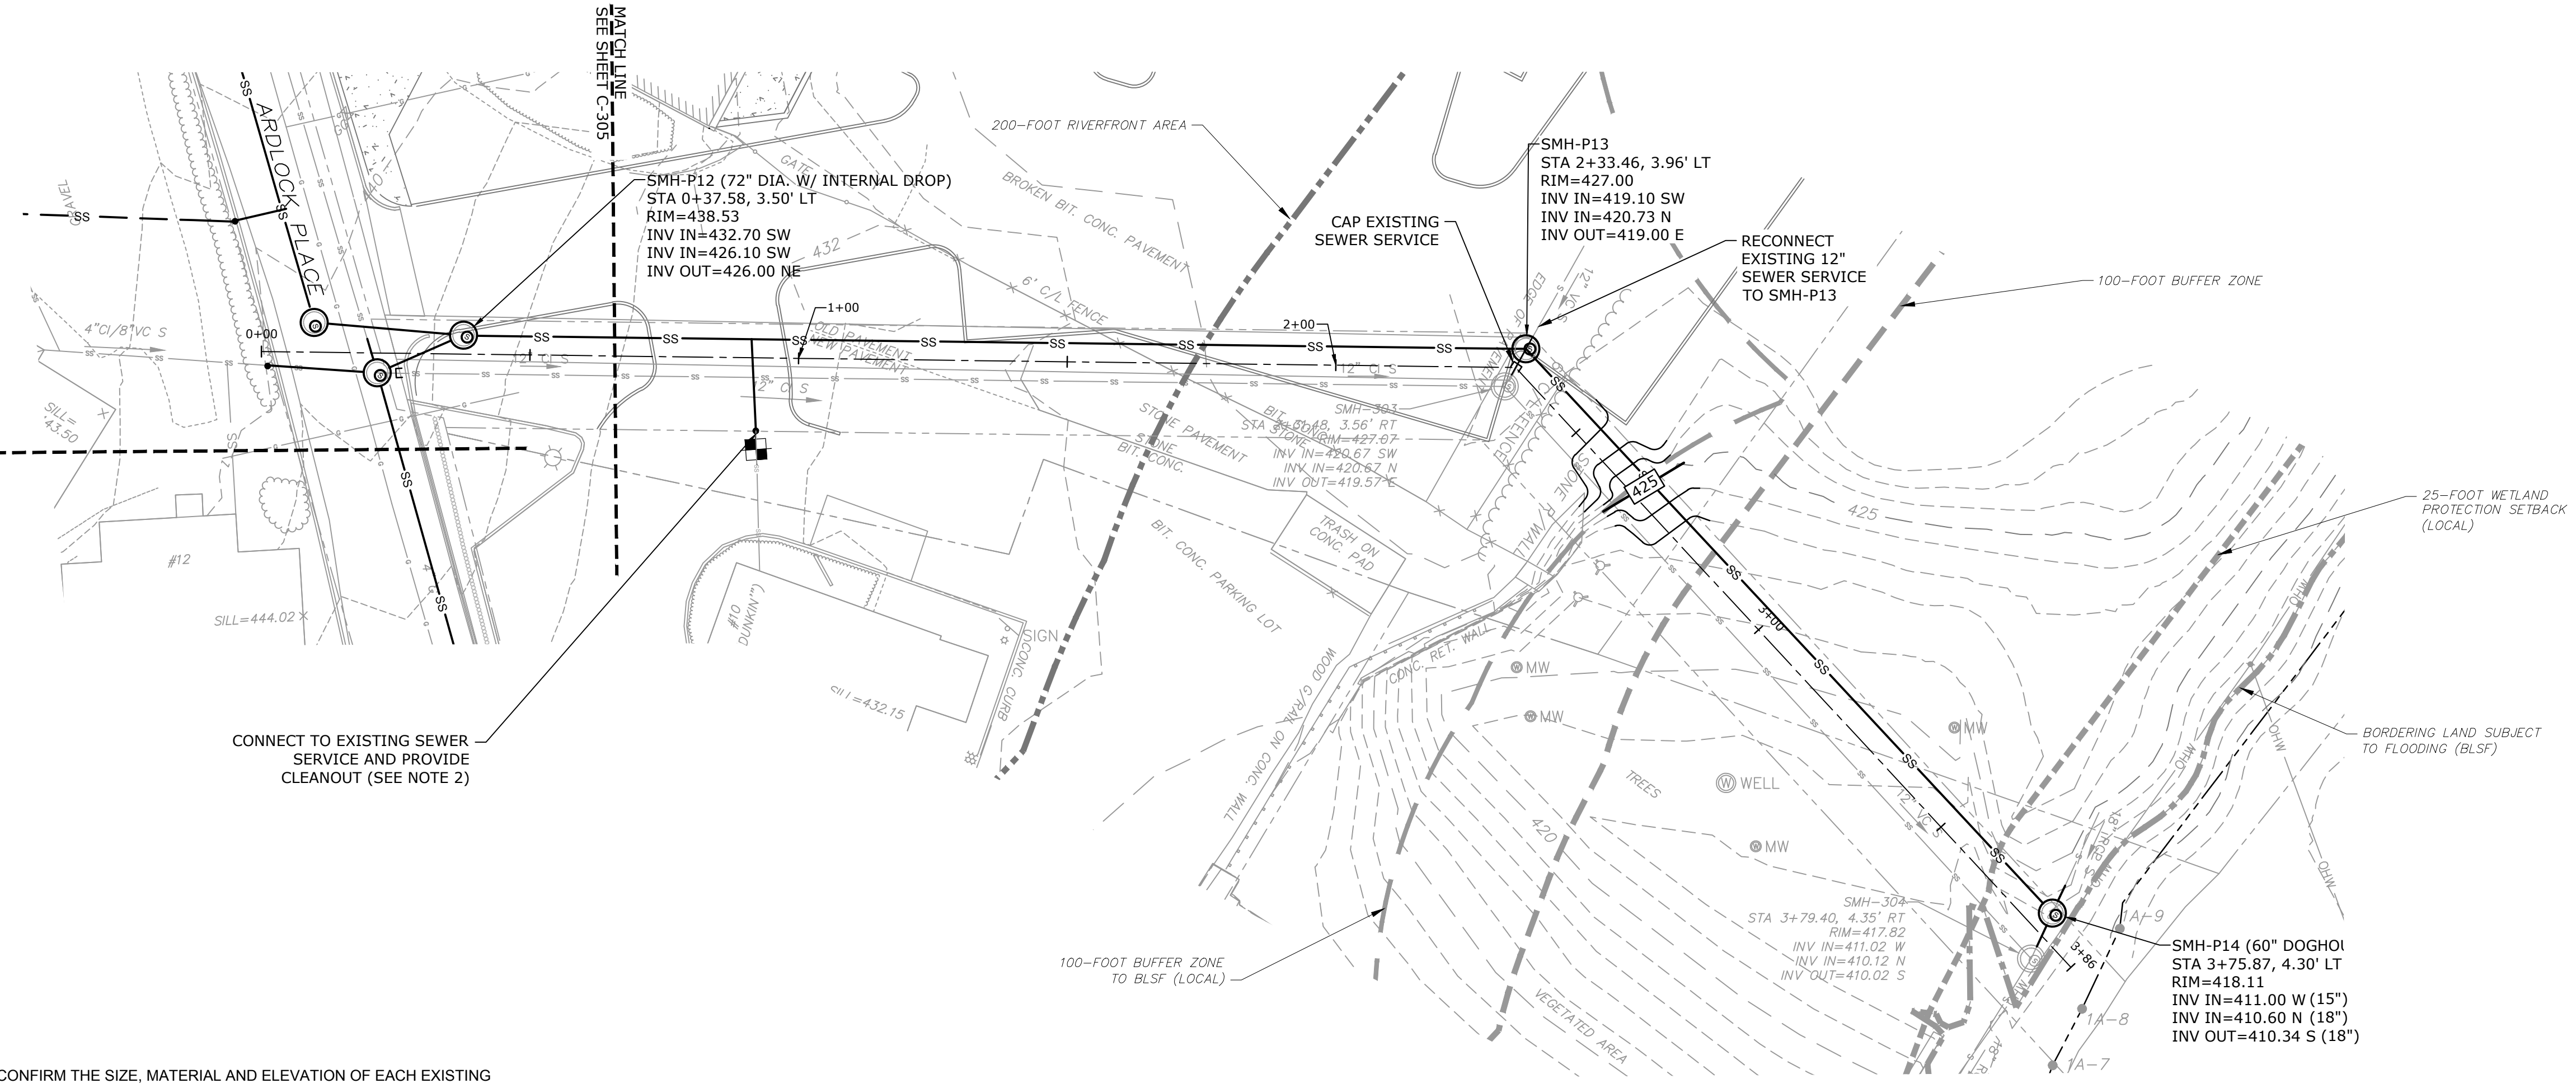

- NOTES:**
- PERFORM TEST PIT EXCAVATIONS TO CONFIRM THE SIZE, MATERIAL AND ELEVATION OF EACH EXISTING SEWER SERVICE PRIOR TO INSTALLING SEWER MAIN.
  - LOCATION OF SEWER SERVICE IS UNKNOWN. LOCATE AND CONNECT TO EXISTING SEWER SERVICE WITH CLEANOUT.

**ARDLOCK PLACE - EAST SEWER LAYOUT PLAN**  
1" = 20'

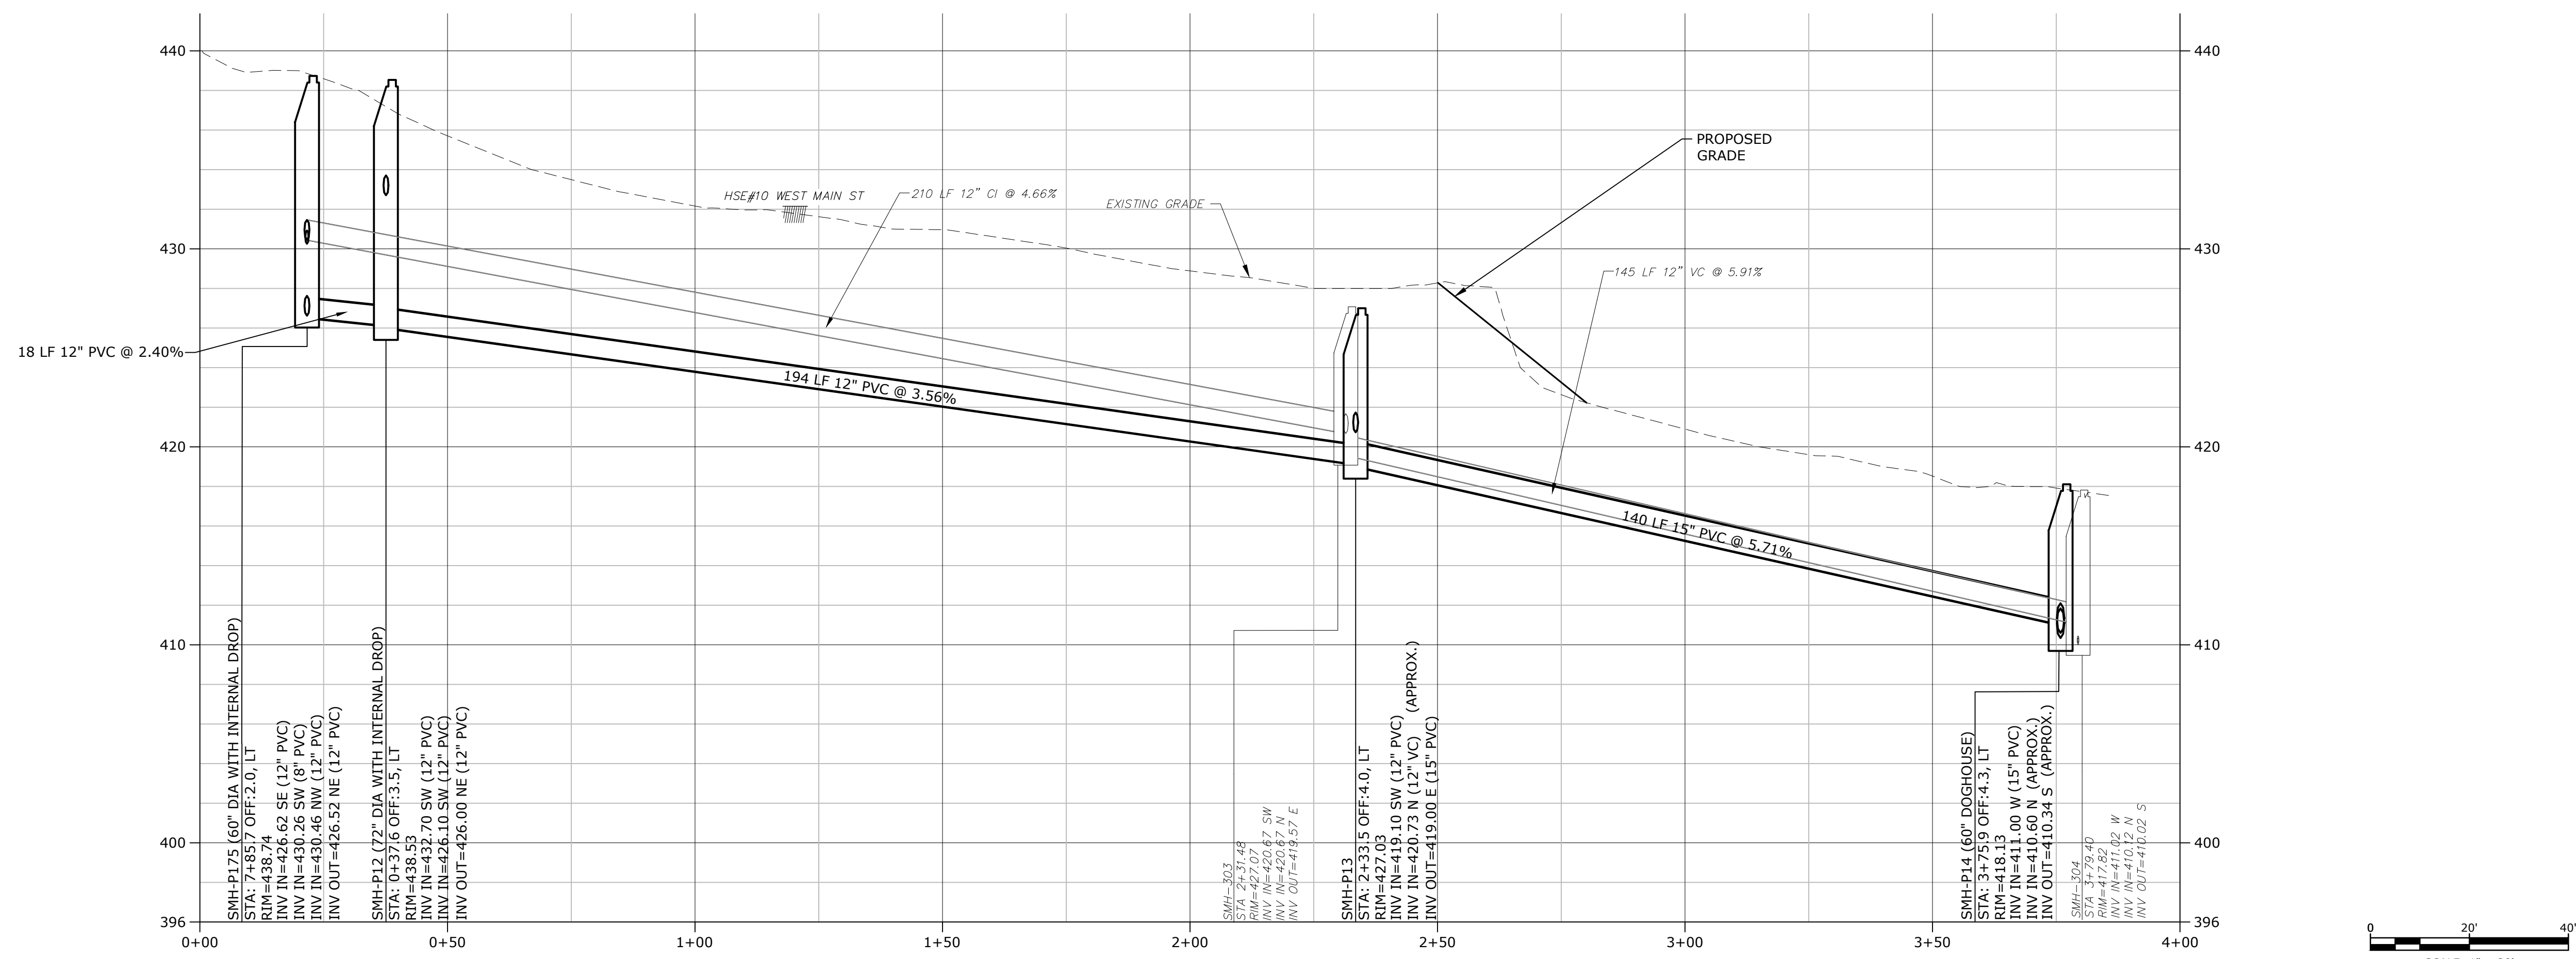

**ARDLOCK PLACE - EAST SEWER PROFILE**  
HORIZONTAL SCALE: 1" = 20' VERTICAL SCALE: 1" = 4'

**Stevens Mill Sewer and Sidewalk Replacement Project**

Town of Dudley


Dudley, MA

0	04/10/2024	ISSUED FOR BIDDING
MARK	DATE	DESCRIPTION
PROJECT NO: D5011-018		
DATE: 04/2024		
FILE: D5011-018 Proposed.dwg		
DRAWN BY: ND/ABS		
CHECKED BY: MPW		
APPROVED BY: JPV		


**ARDLOCK PLACE SEWER PLAN AND PROFILE-2**

SCALE: HORIZ. 1" = 20'; VERT. 1" = 4'


Last Saved: 4/10/2024 12:00pm By: NBay  
 Plotted On: Apr 10, 2024 12:00pm  
 Figure & Legend: 3:10:52:11 Stevens Mill MassWorks\Drawings\_Figures\AutoCAD\Sheet\DS011\_018\_Proposed.dwg

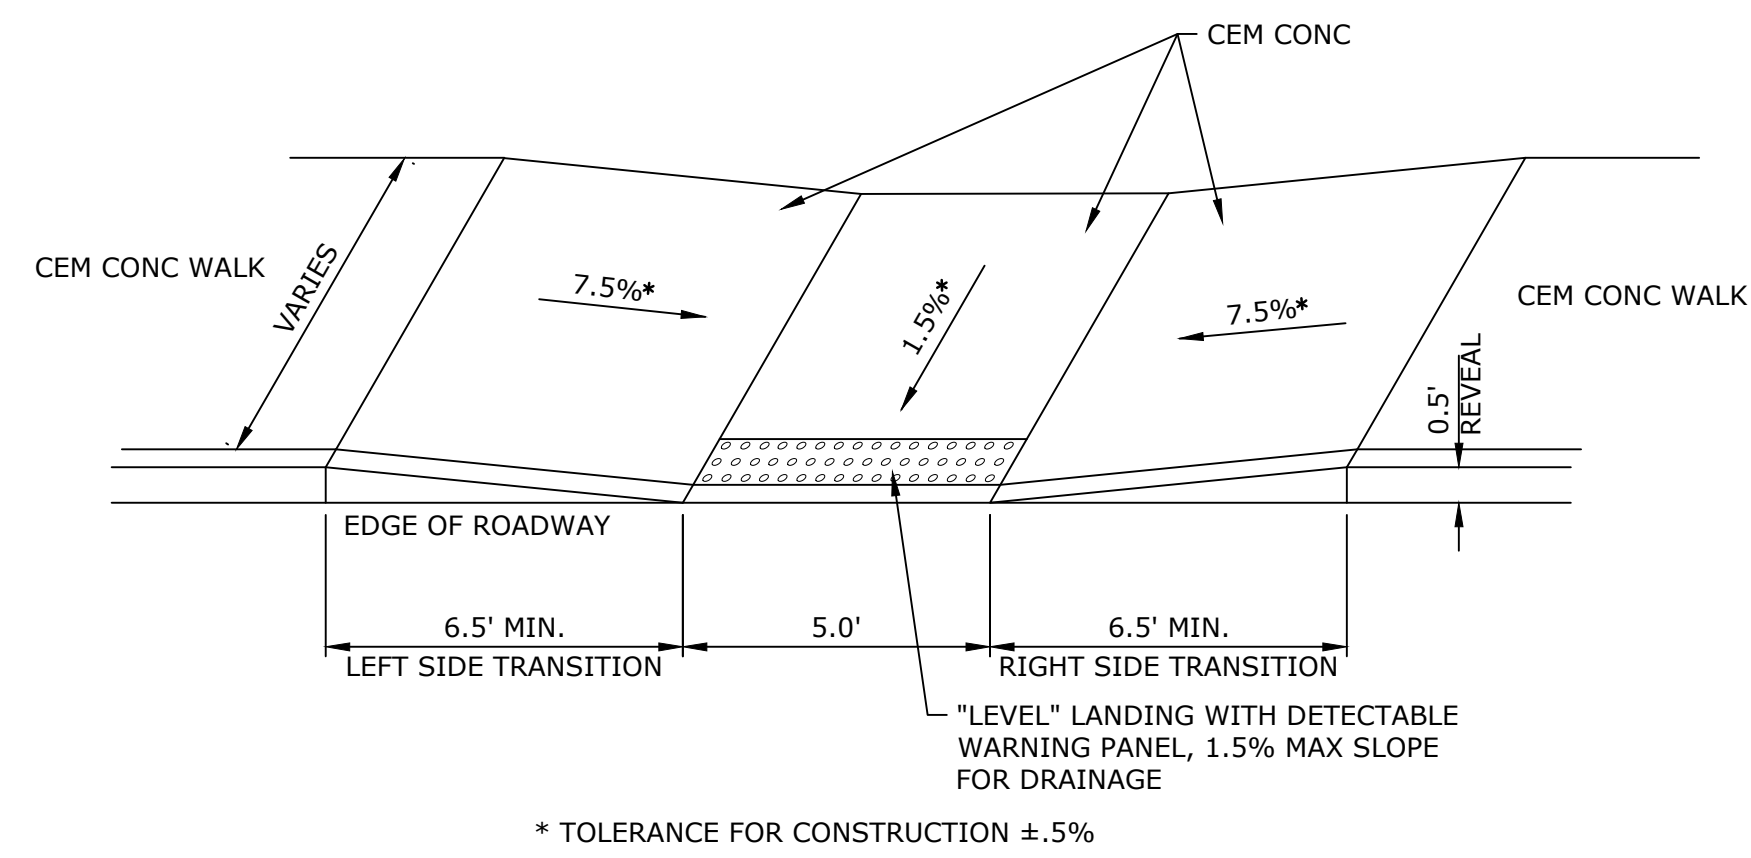


**TYPICAL WHEELCHAIR RAMP - TYPE 1**  
NO SCALE

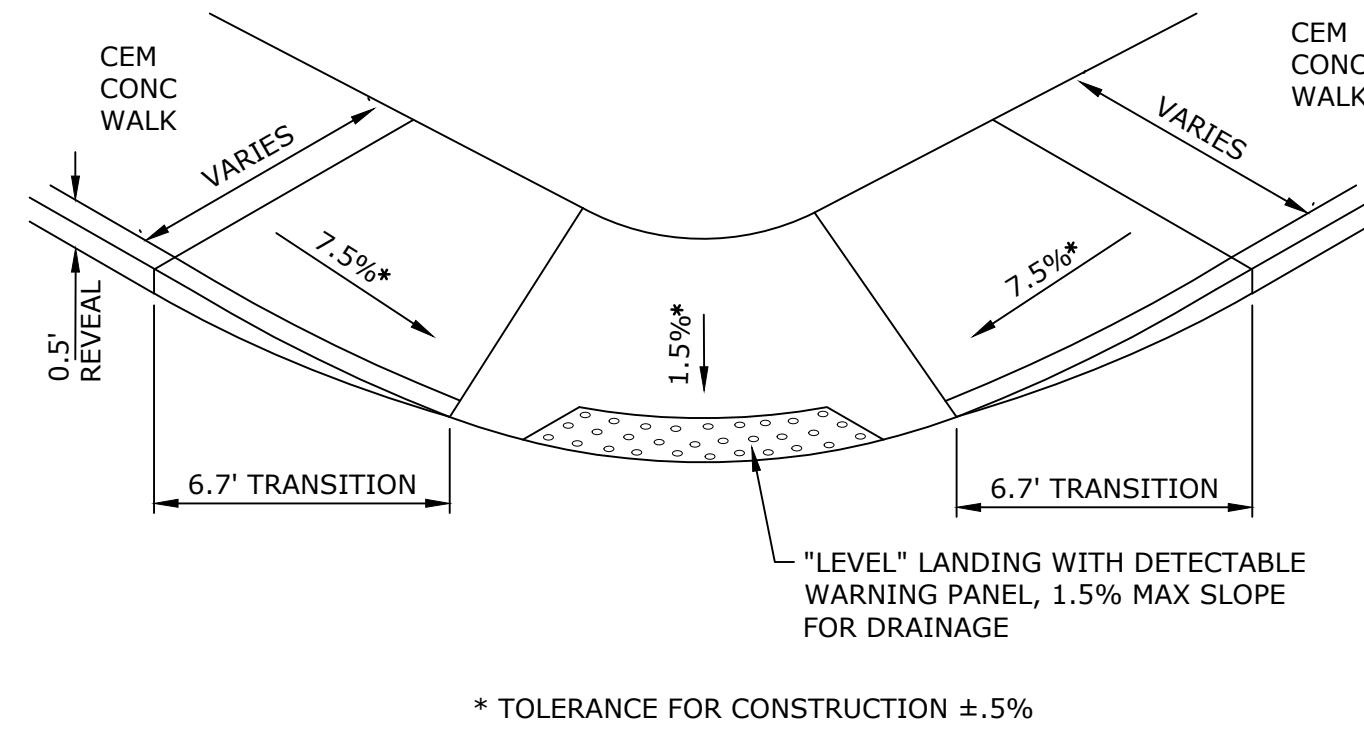


**TYPICAL WHEELCHAIR RAMP - TYPE 2**  
NO SCALE

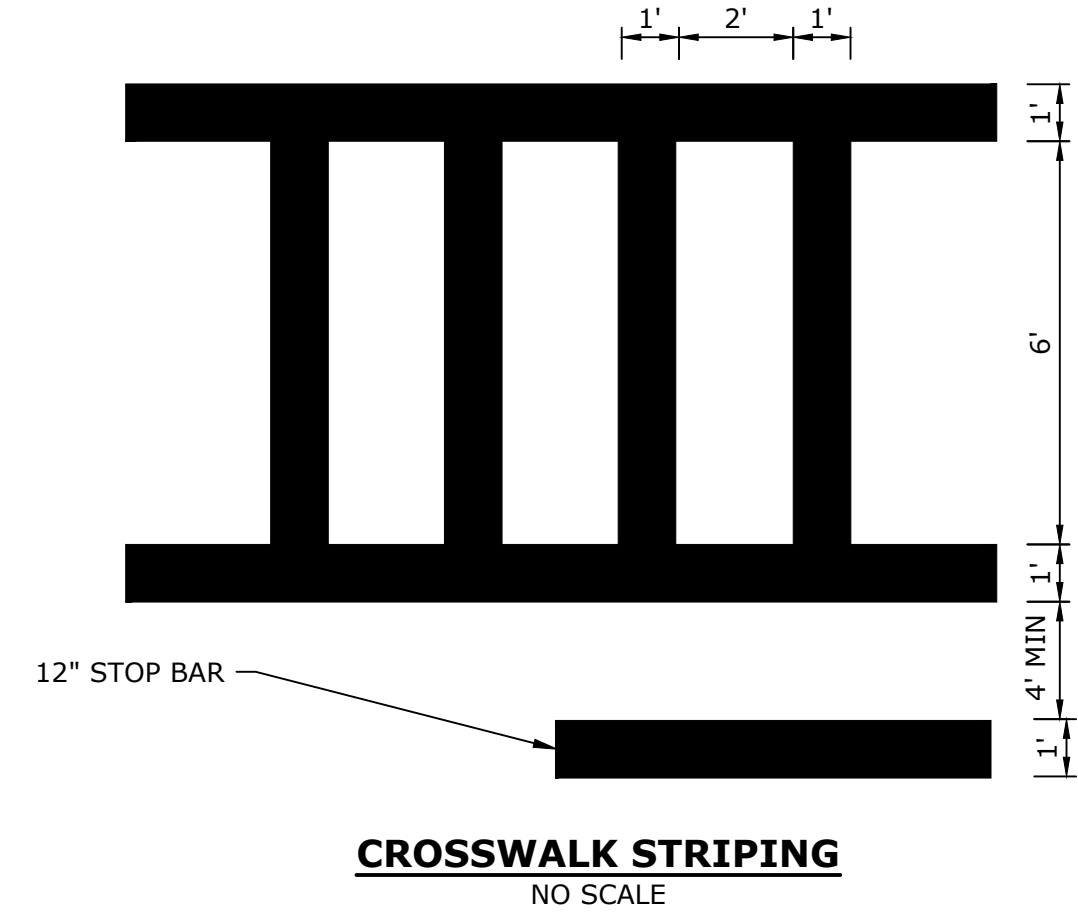


**CROSSWALK STRIPING**  
NO SCALE  
NOTE:  
1. CONTRACTOR TO USE DUDLEY DPW STANDARD CROSS WALK STENCIL.

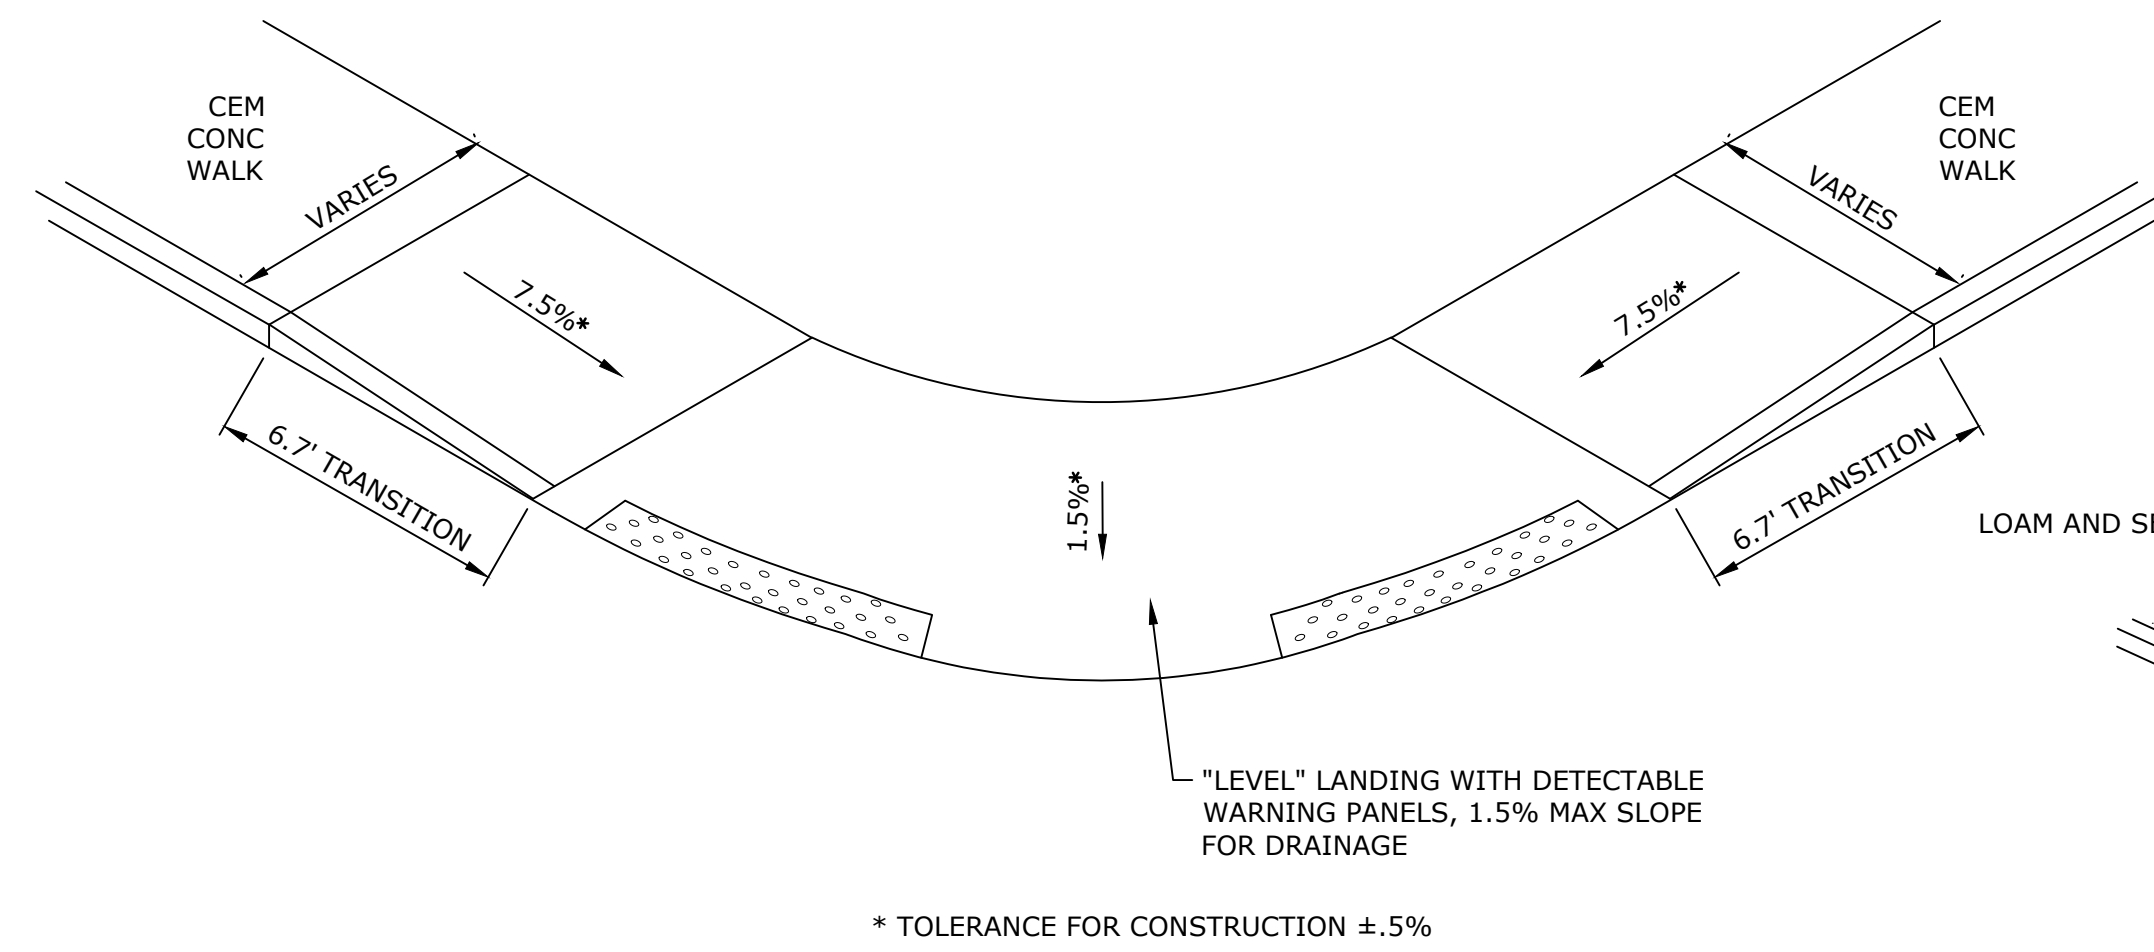

**TYPICAL WHEELCHAIR RAMP - TYPE 3**  
NO SCALE

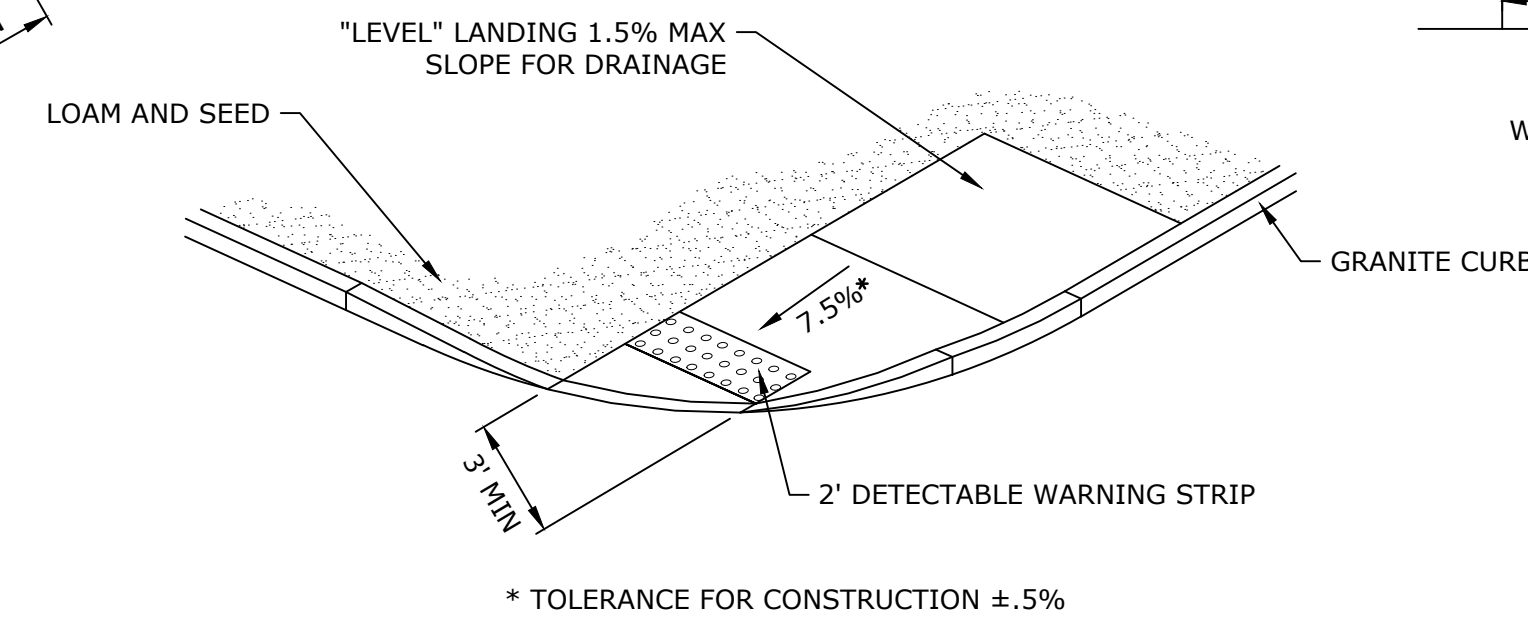

**TYPICAL WHEELCHAIR RAMP - TYPE 4**  
NO SCALE



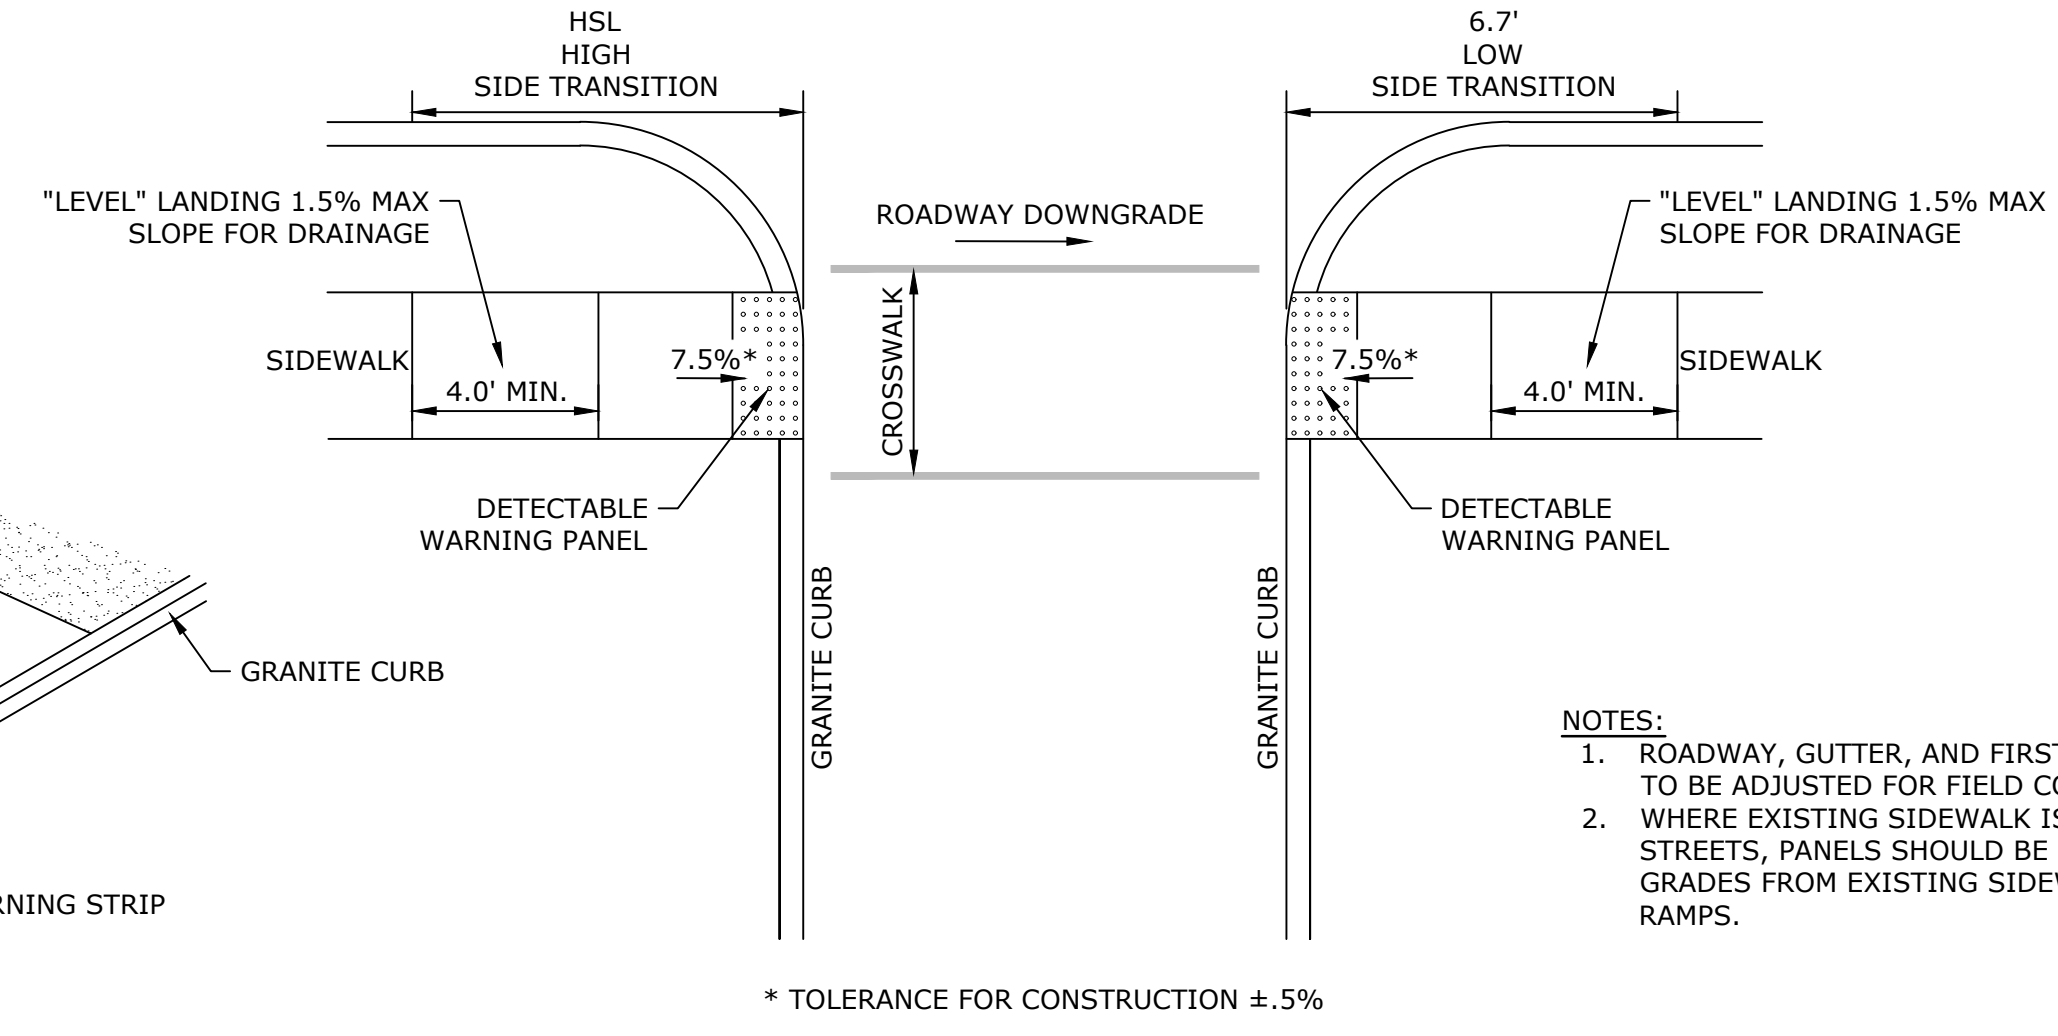


**TYPICAL WHEELCHAIR RAMP - TYPE 5**  
NO SCALE

- NOTES:
- ROADWAY, GUTTER, AND FIRST 6" OF SIDEWALK TO BE ADJUSTED FOR FIELD CONDITIONS.
  - WHERE EXISTING SIDEWALK IS PRESENT ON SIDE STREETS, PANELS SHOULD BE REBUILT TO BLEND GRADES FROM EXISTING SIDEWALK TO NEW RAMPS.

**SIDEWALK AND WHEELCHAIR RAMP NOTES:**

- WIDTH OF WALKWAYS SHALL NOT BE LESS THAN 48 INCHES, EXCLUDING CURB.
- AN UNOBSTRUCTED PATH OF TRAVEL SHALL BE PROVIDED WHICH IS AT LEAST 36 INCHES CLEAR, EXCLUDING CURB.
- LOW SIDE TRANSITION LENGTH SHALL BE A MINIMUM OF 6'-6".
- HIGH SIDE TRANSITION LENGTH AS SHOWN IN CURB TRANSITION LENGTHS TABLE.
- THE WHEELCHAIR RAMP MAXIMUM SLOPES AND SIDE SLOPES (TRANSITIONS) WILL BE 7.5% WITH A CONSTRUCTION TOLERANCE OF 0.5%±.
- WHERE THE ROAD PROFILE EXCEEDS 4%, THE HIGH SIDE TRANSITION LENGTH UNDER ANY CONDITIONS NEED NOT EXCEED 15-FEET.
- AT NO TIME IS ANY PART OF THE WHEELCHAIR RAMP, EXCLUDING CURB TRANSITIONS, TO BE LOCATED OUTSIDE THE CROSSWALK. THE WHEELCHAIR RAMP ENTRANCE IS TO BE CENTERED IN THE CROSSWALK WHENEVER POSSIBLE.
- THE ENTRANCE OF A WHEELCHAIR RAMP SHALL BE FLUSH WITH THE ROADWAY.
- TESTING SURFACE: WHEN TESTING WITH A STRAIGHTEDGE PLACED PARALLEL TO THE LINE OF SLOPE THERE SHALL BE NO DEVIATION FROM A TRUE SURFACE IN EXCESS OF 1/4".
- DETECTABLE WARNING PANELS ARE REQUIRED ON ALL OF THE PROPOSED WHEELCHAIR RAMPS AND ARE TO BE INSTALLED IN ACCORDANCE WITH THE MANUFACTURER'S SPECIFICATIONS.

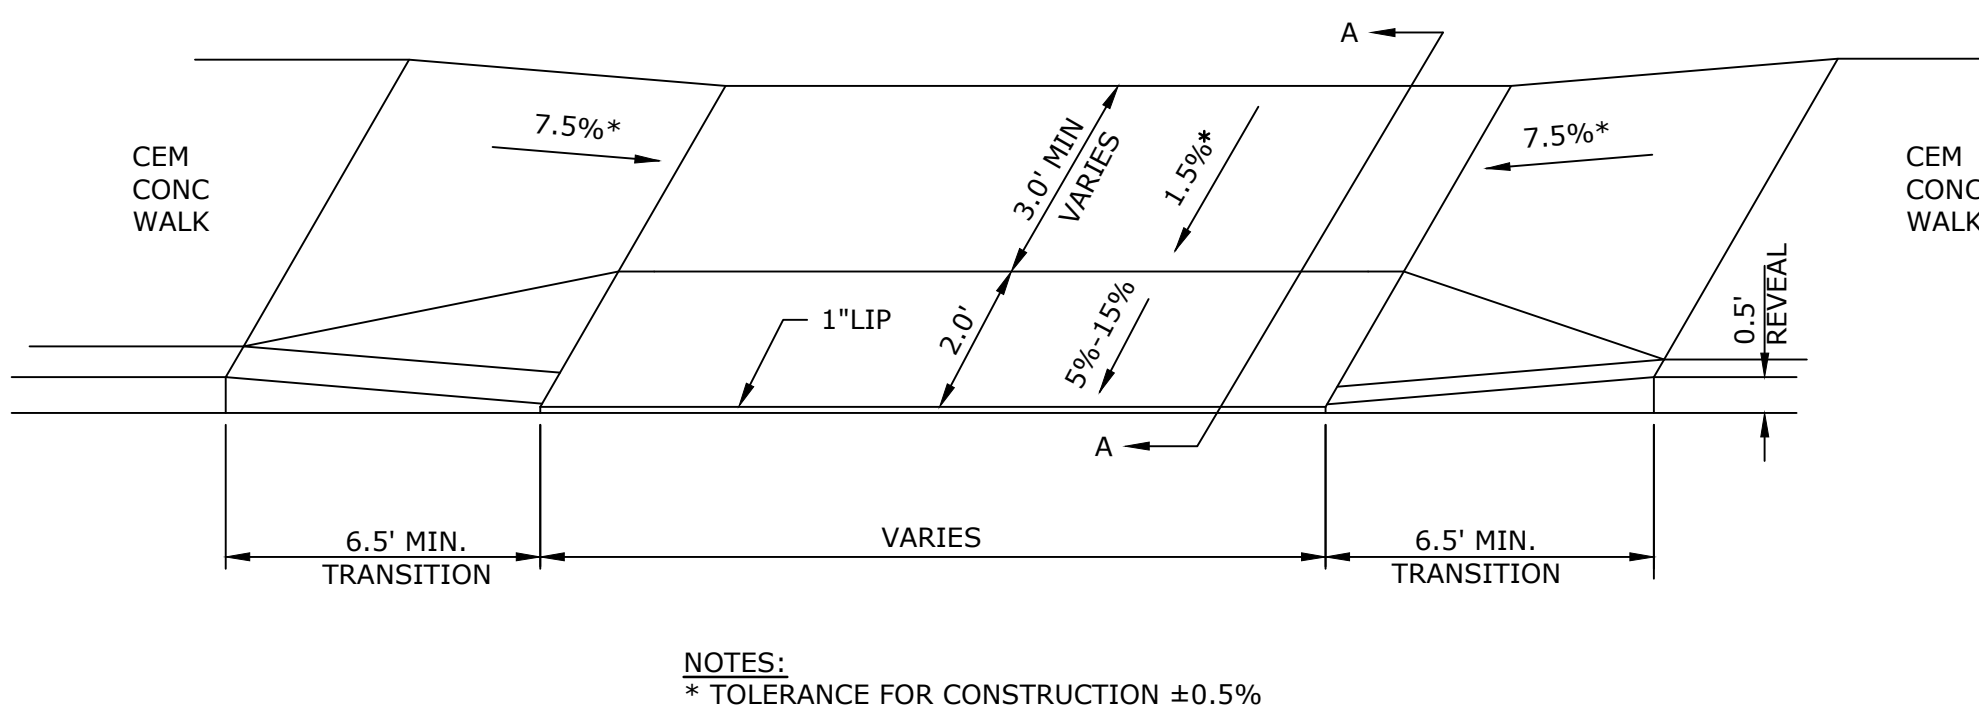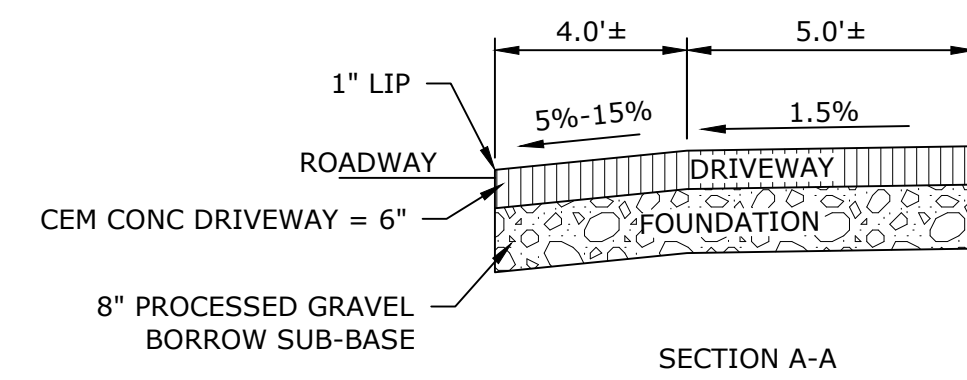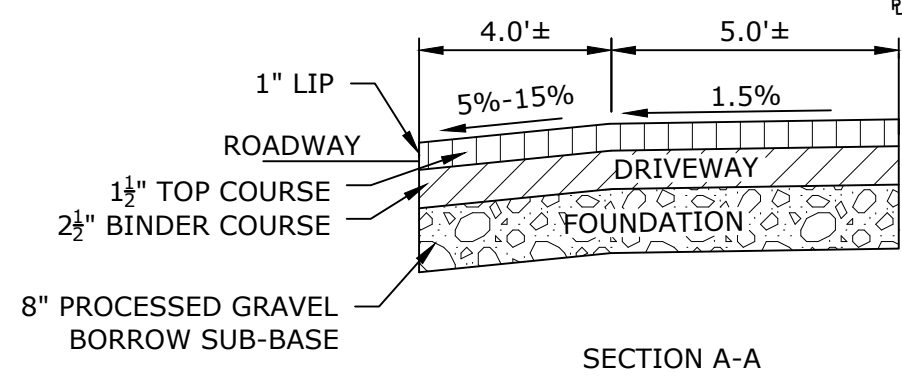


**SIDEWALK THROUGH DRIVEWAY - TYPE 1**  
NO SCALE

**\*\* HIGH SIDE TRANSITION LENGTH**

ROADWAY PROFILE GRADE, %	TRANSITION LENGTH
0	6'-6"
>0-1	7'-8"
>1-2	9'-0"
>2-3	11'-0"
>3-4	14'-0"
>4	15'-0" MAX

NOTE:  
\*\* BASED ON A DESIGN SLOPE OF 7.5% AND A CURB REVEAL OF 6".

**CURB TRANSITION LENGTHS**  
NO SCALE

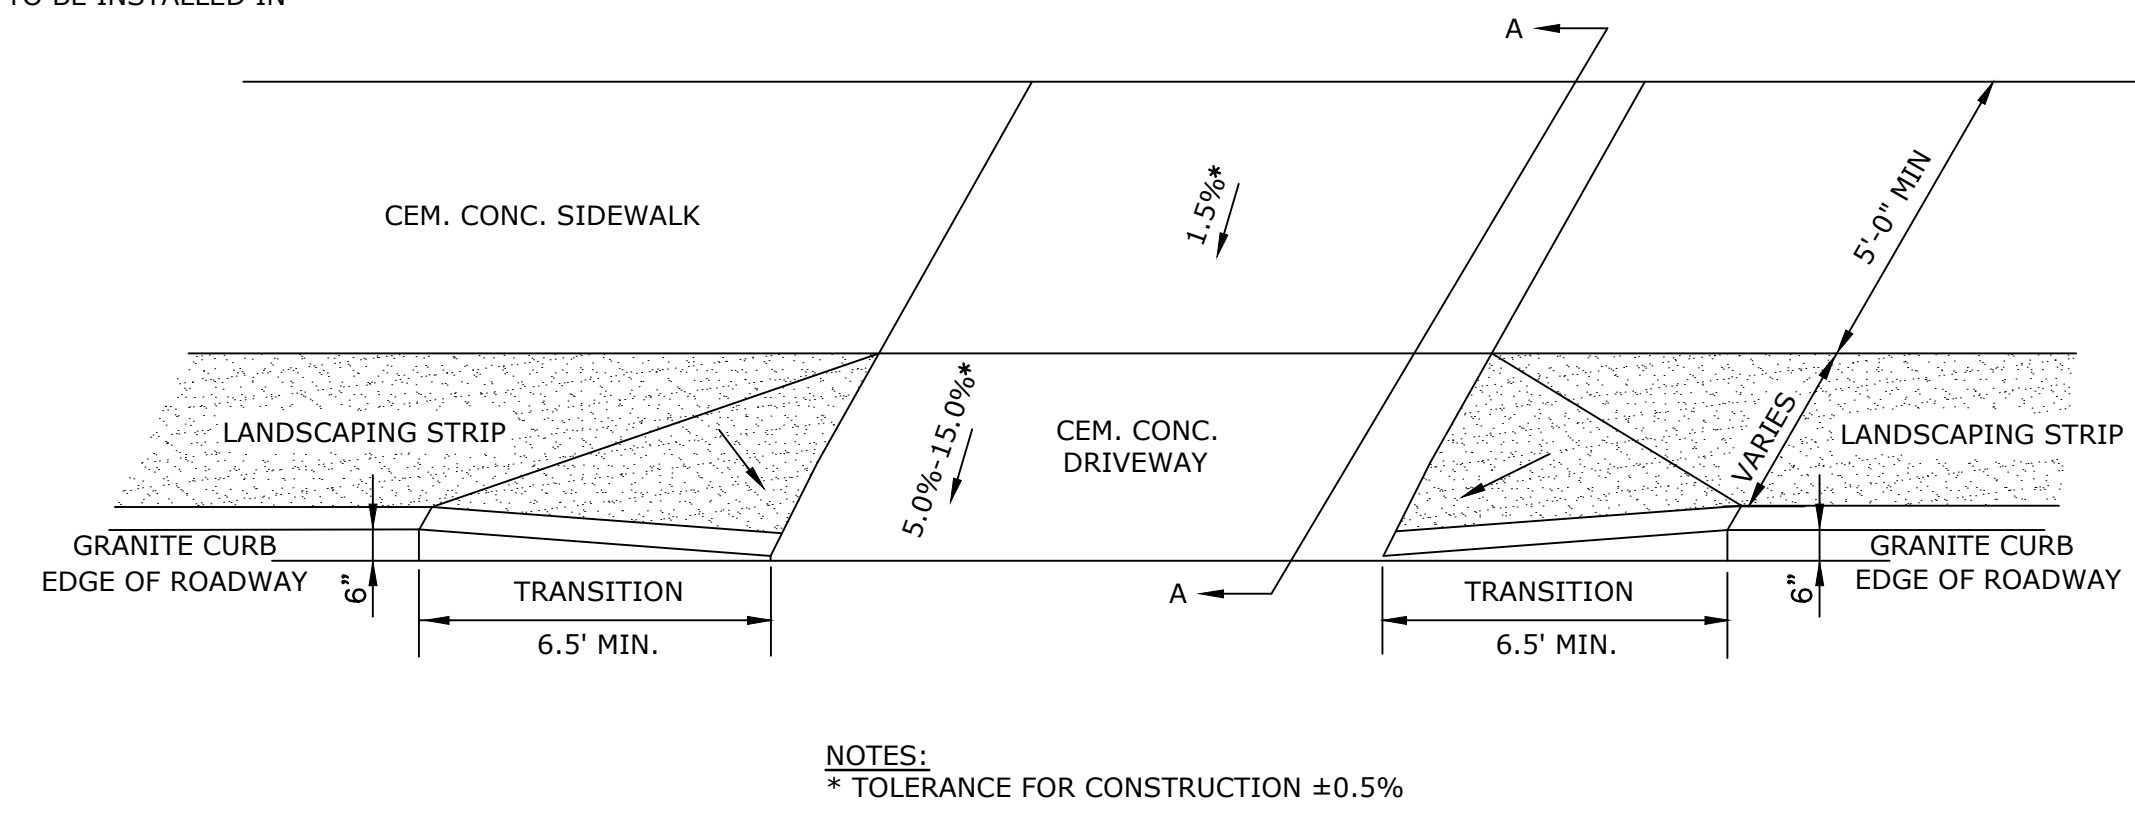

**SIDEWALK THROUGH DRIVEWAY - TYPE 2**  
NO SCALE

**Stevens Mill Sewer and Sidewalk Replacement Project**

Town of Dudley


Dudley, MA

0	04/10/2024	ISSUED FOR BIDDING
MARK	DATE	DESCRIPTION
PROJECT NO:	DS011-018	
DATE:	04/2024	
FILE:	Details.dwg	
DRAWN BY:	ND/ABS	
CHECKED BY:	MPW	
APPROVED BY:	JPV	


SITE DETAILS - 1

SCALE: AS SHOWN

C-501

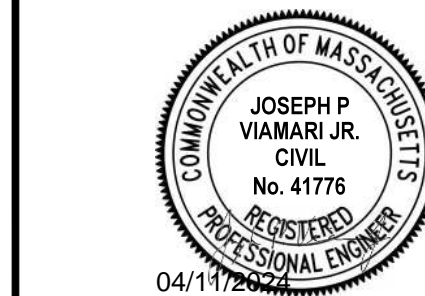

04/11/2024

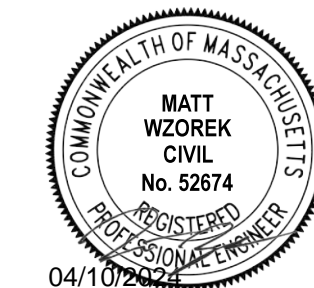

04/10/2024

**Stevens Mill Sewer and Sidewalk Replacement Project**

Town of Dudley


Dudley, MA

0	04/10/2024	ISSUED FOR BIDDING
MARK	DATE	DESCRIPTION
PROJECT NO:	D5011-018	
DATE:	04/2024	
FILE:	Details.dwg	
DRAWN BY:	ND/ABS	
CHECKED BY:	MPW	
APPROVED BY:	JPV	

SITE DETAILS - 2


SCALE: AS SHOWN

C-502

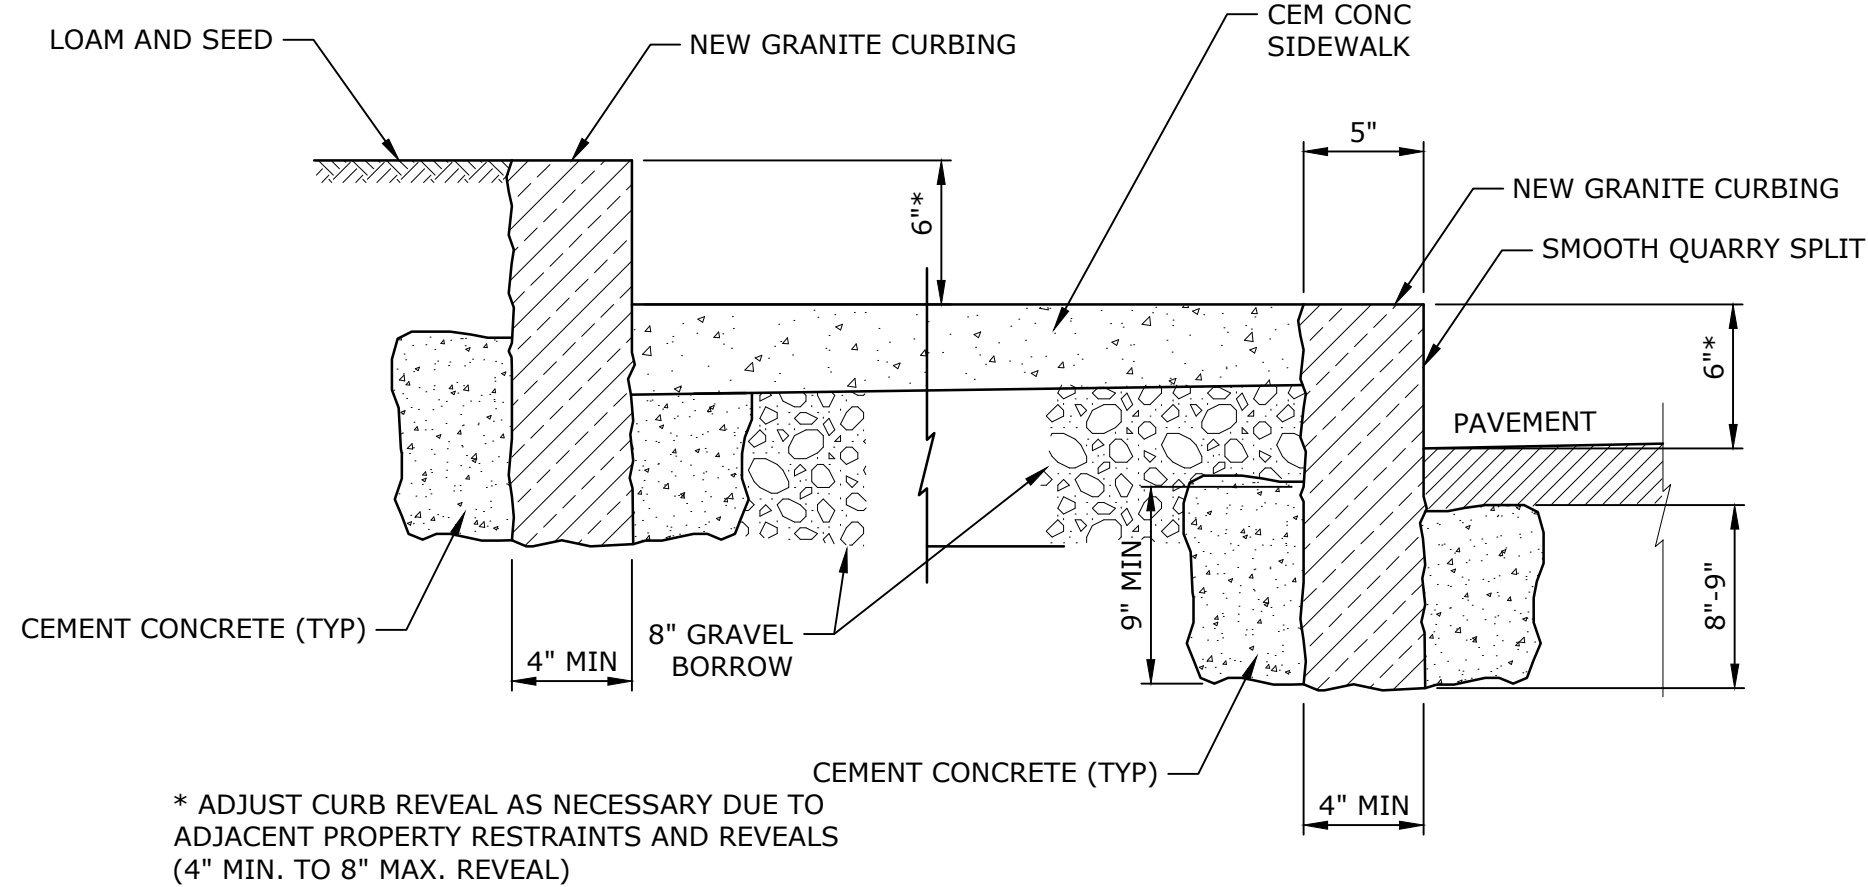

\* ADJUST CURB REVEAL AS NECESSARY DUE TO ADJACENT PROPERTY RESTRAINTS AND REVEALS (4" MIN. TO 8" MAX. REVEAL)

**DOUBLE GRANITE CURB ON MILL STREET**  
NO SCALE

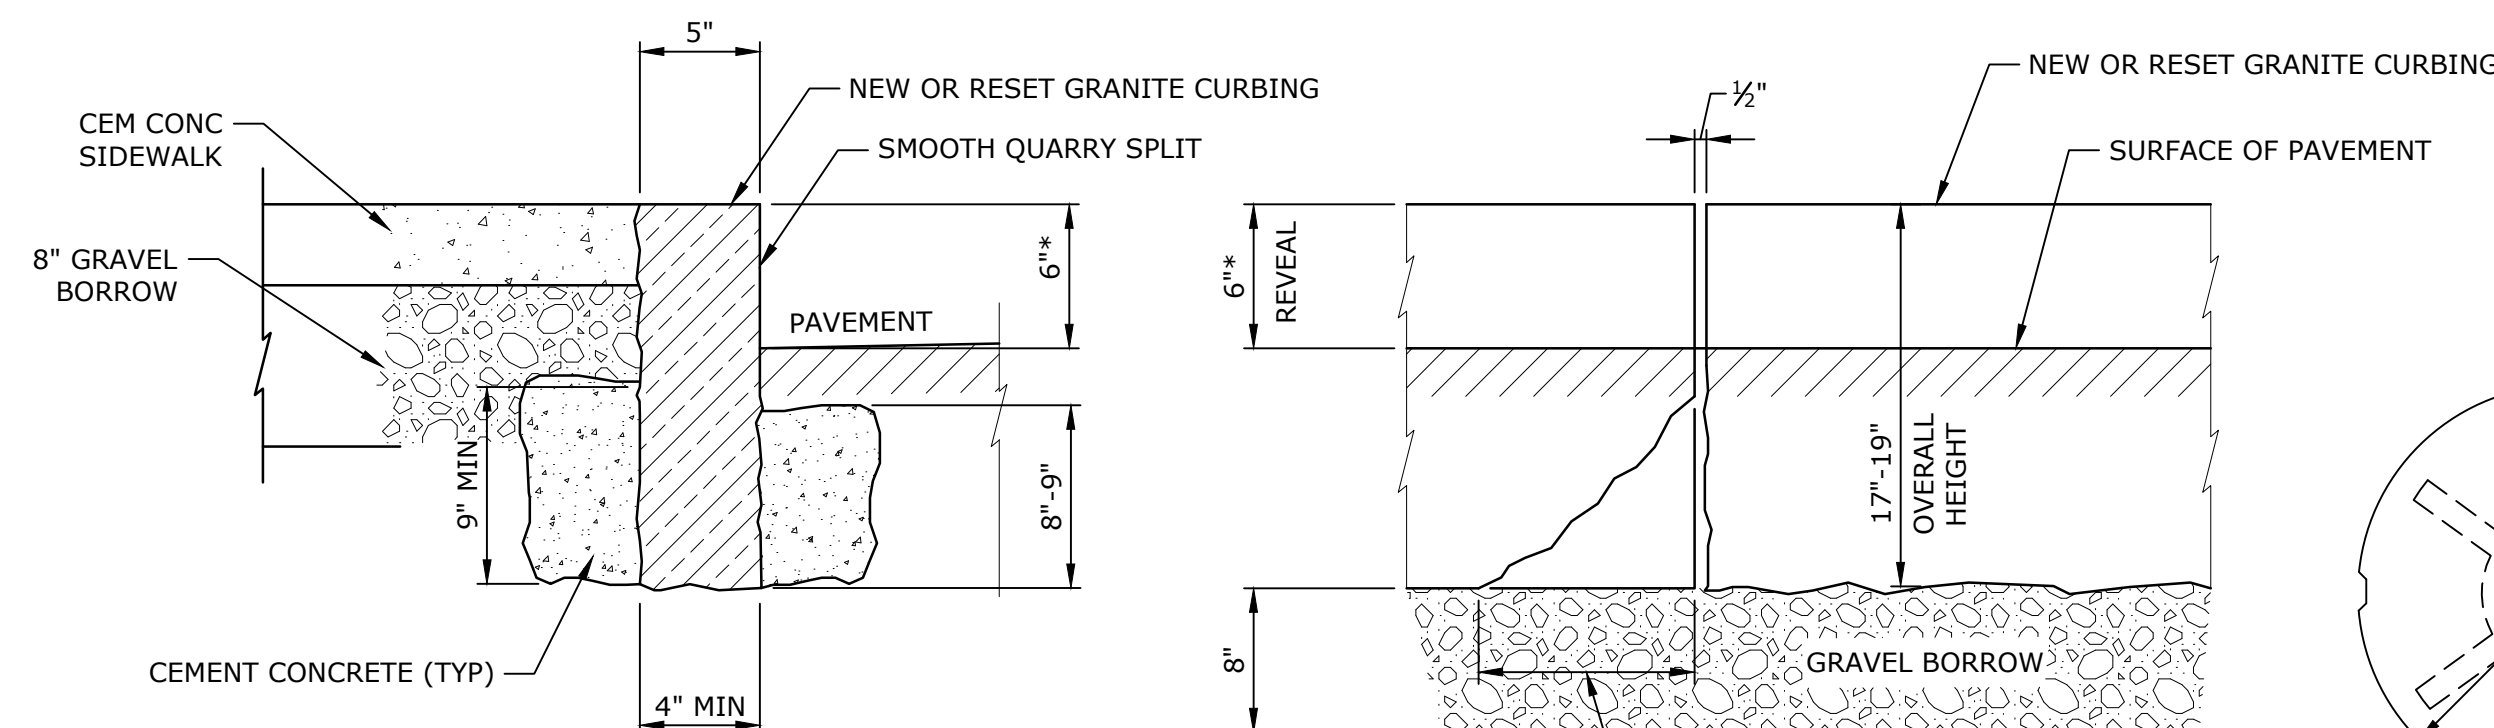


\* ADJUST CURB REVEAL AS NECESSARY DUE TO ADJACENT PROPERTY RESTRAINTS AND REVEALS (4" MIN. TO 8" MAX. REVEAL)

MAXIMUM ALLOWABLE BREAK BACK  
9" - FOR CURB LENGTHS OF 6'-0" OR MORE  
6" - FOR CURB LENGTHS OF LESS THAN 6'-0"

SECTION

**GRANITE CURB**  
NO SCALE

ELEVATION

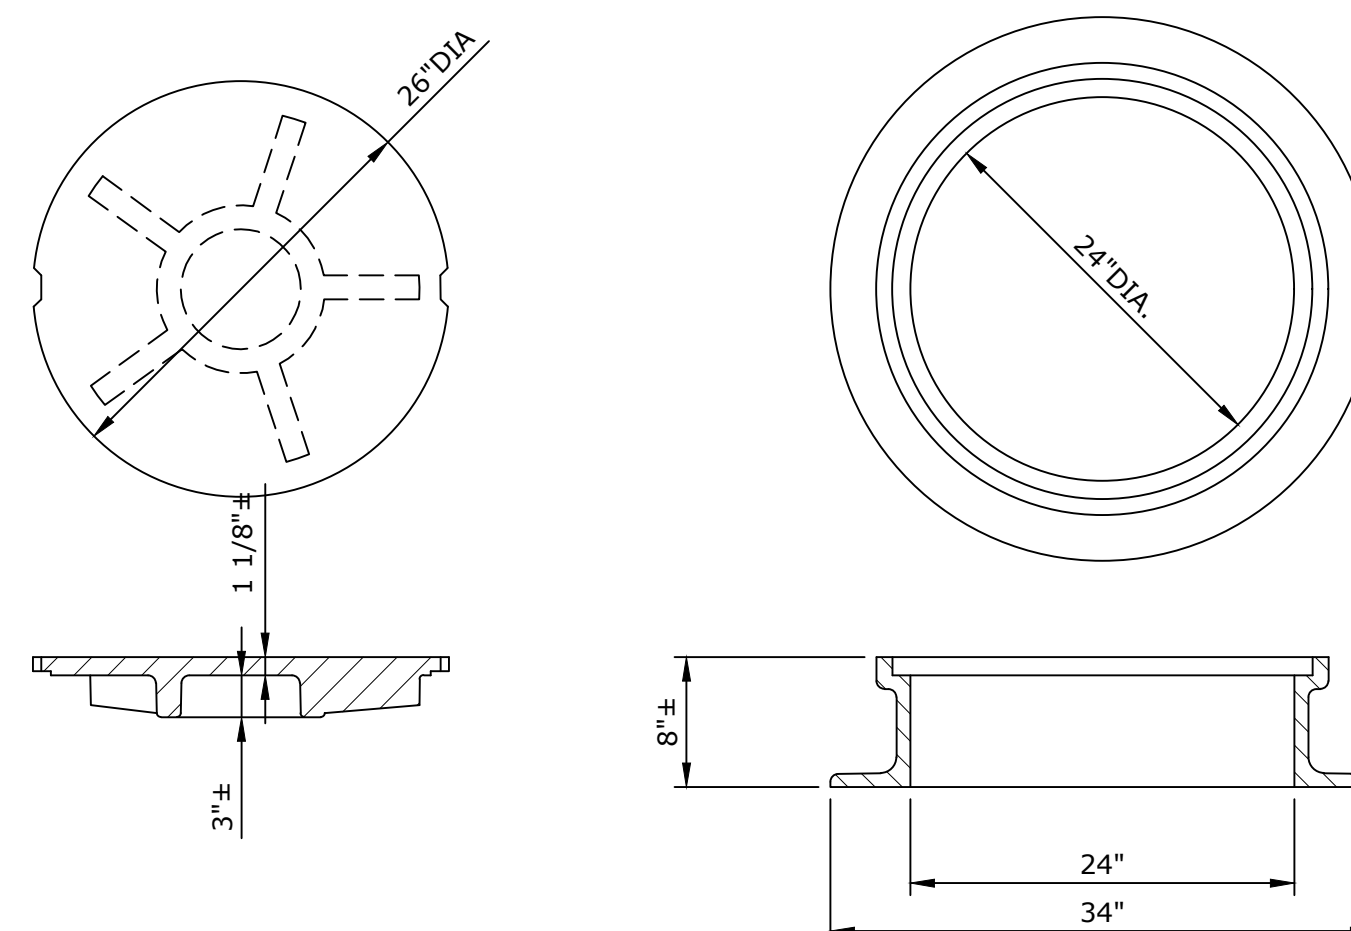


STANDARD MANHOLE COVER  
MINIMUM WEIGHT: 200 LBS.

STANDARD MANHOLE FRAME  
MINIMUM WEIGHT: 240 LBS.


- NOTES:
1. FRAME AND COVER SHALL BE PROVIDED FROM THE SAME MANUFACTURER.
  2. LETTERING SHALL BE CAST INTO COVERS AS SPECIFIED.

**MANHOLE FRAME & COVER**  
NO SCALE

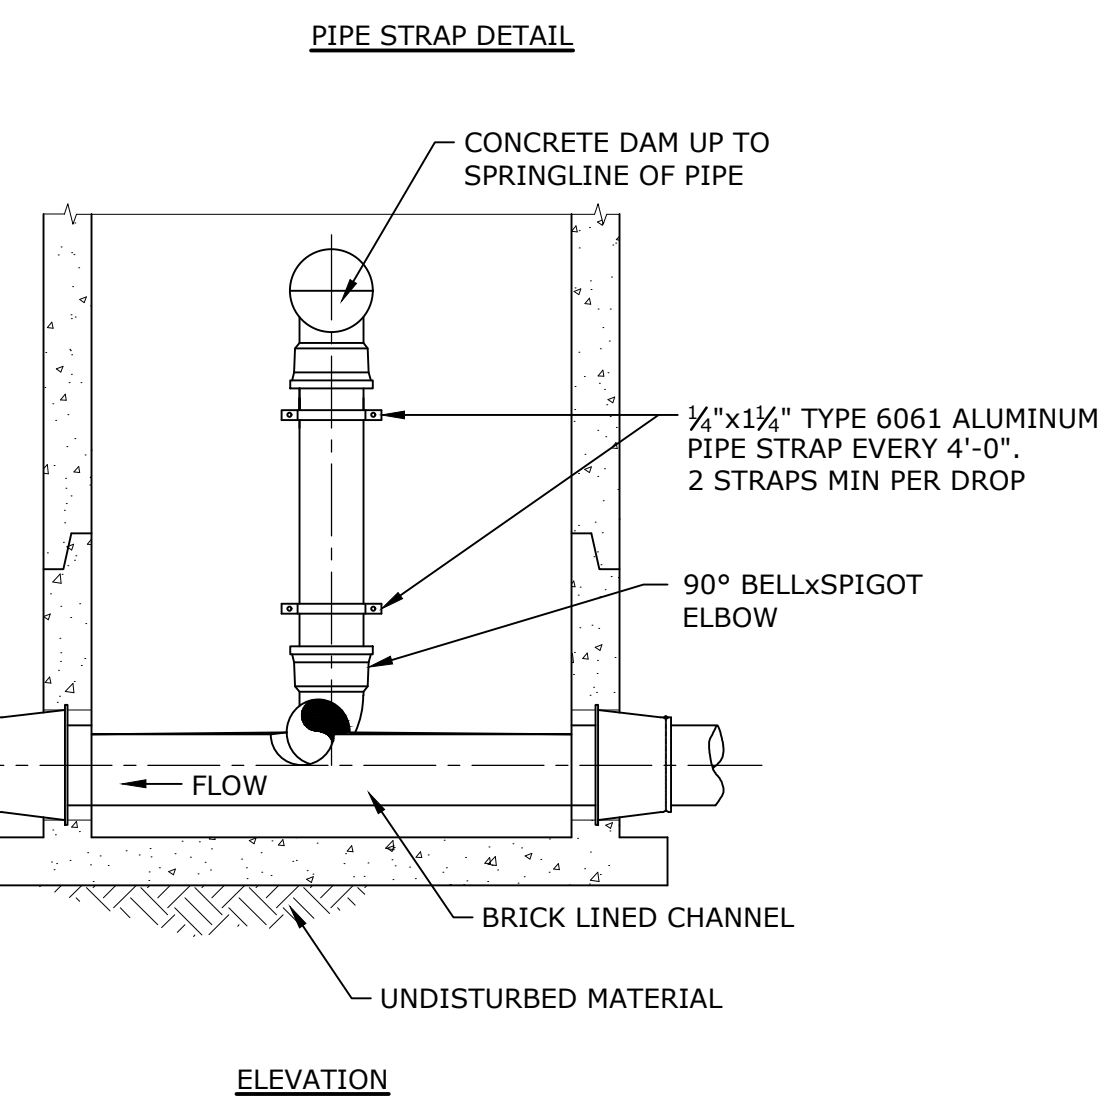


ELEVATION

**INTERIOR MANHOLE CHIMNEY**  
NO SCALE

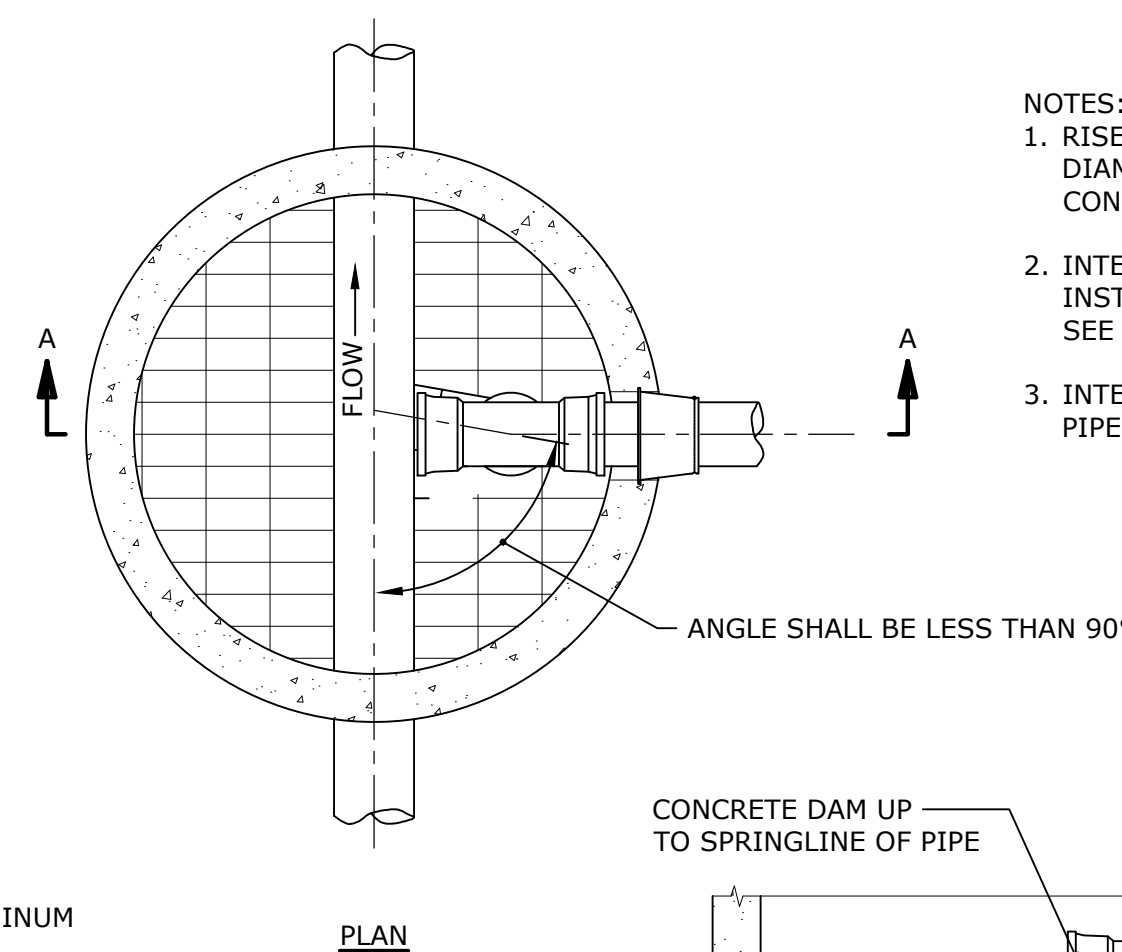


PLAN

- NOTES:
1. RISER PIPE AND FITTINGS SHALL BE THE SAME DIAMETER AS THE INLET PIPE AND SHALL BE CONSTRUCTED OF SDR35 PVC PIPE
  2. INTERIOR MANHOLE CHIMNEYS SHALL ONLY BE INSTALLED IN 60" DIAMETER OR LARGER MANHOLE. SEE MANHOLE DETAIL FOR FURTHER INFORMATION.
  3. INTERIOR CHIMNEY TO BE USED FOR ALL SEWER PIPE CONNECTIONS 12" OR LESS IN DIAMETER.

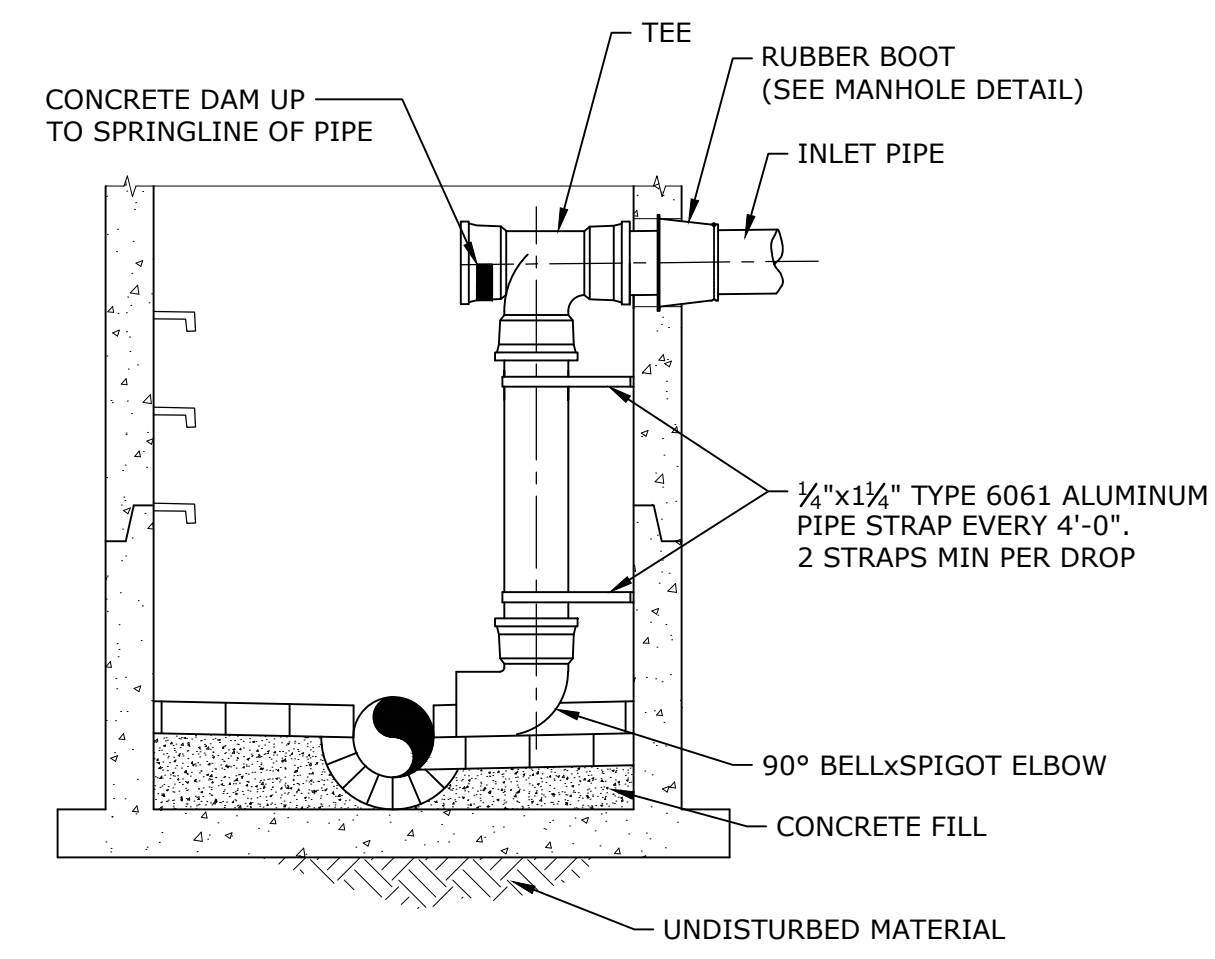


SECTION A-A

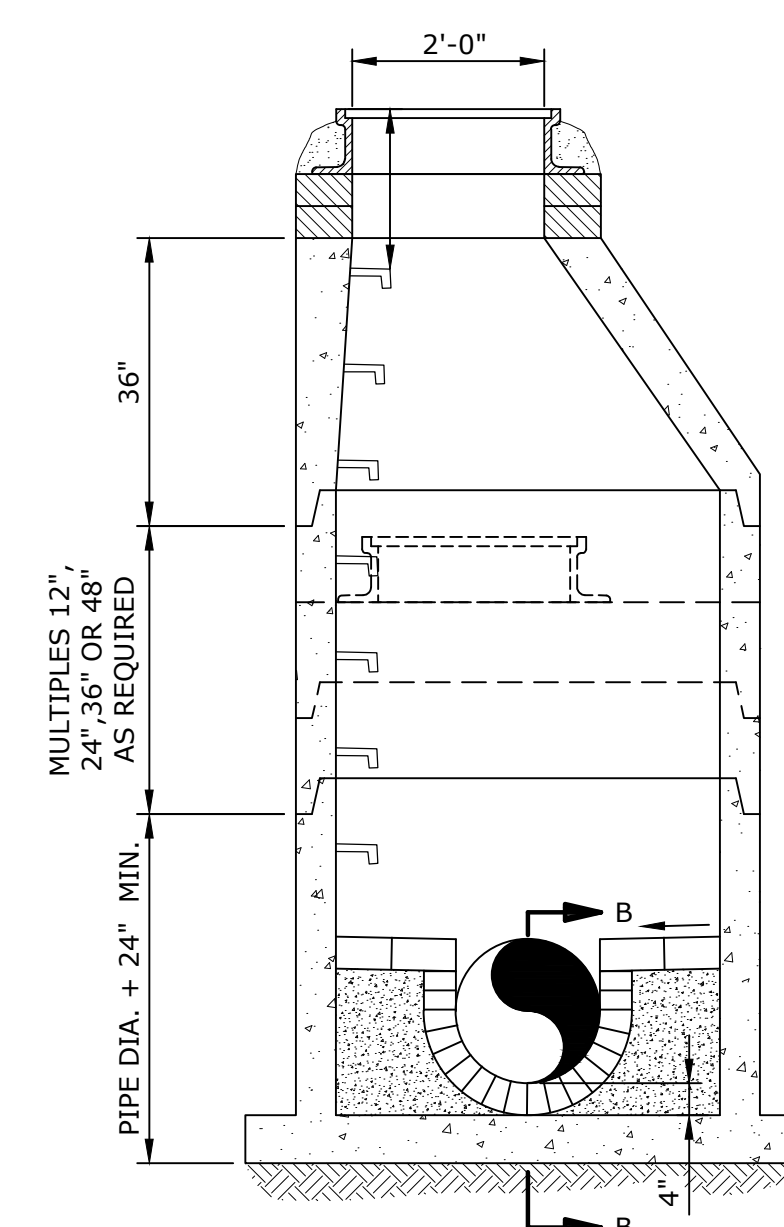

SECTION B-B



SECTION A-A

**48" PRECAST SANITARY SEWER MANHOLE**  
NO SCALE

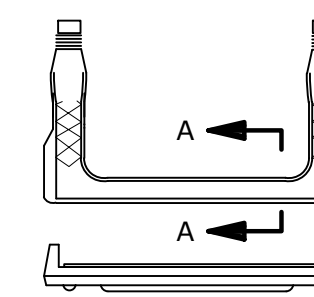


STANDARD MANHOLE RUNG

Last Saved: 4/10/2024 12:01pm By: NBay  
 Plotted On: Apr 10, 2024 12:01pm  
 Figure & Detail: 3:10:05211 - Stevens Mill Sewer and Sidewalk Replacement - Figures\AutoCAD\Sheet\Details.dwg

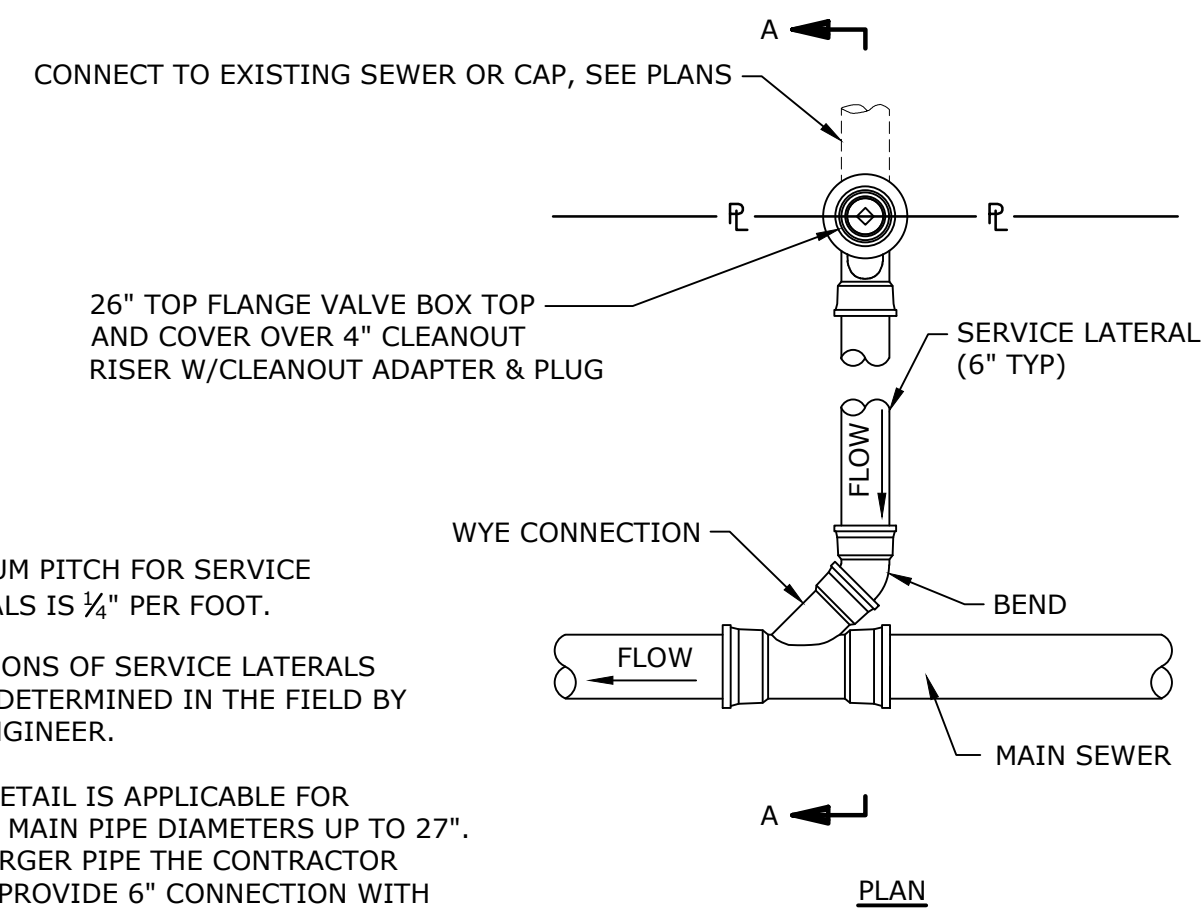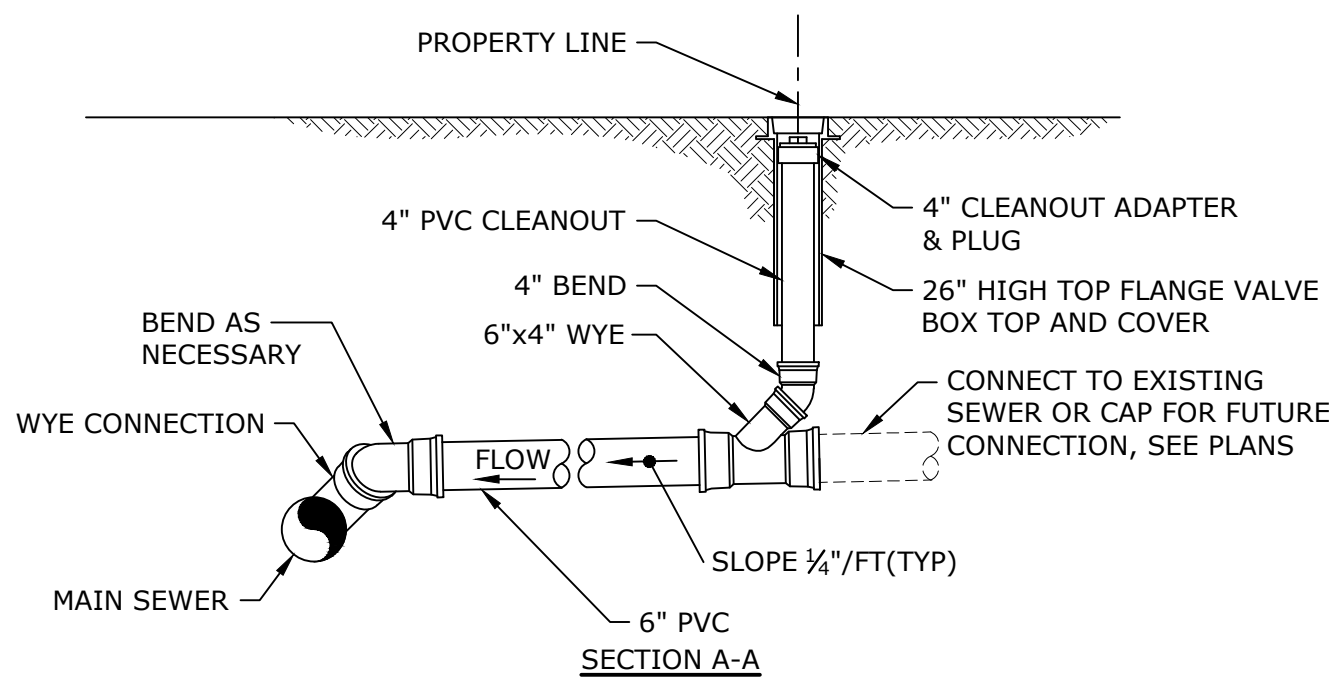

- NOTES:**
1. MINIMUM PITCH FOR SERVICE LATERALS IS 1/4" PER FOOT.
  2. LOCATIONS OF SERVICE LATERALS TO BE DETERMINED IN THE FIELD BY THE ENGINEER.
  3. THIS DETAIL IS APPLICABLE FOR SEWER MAIN PIPE DIAMETERS UP TO 27". FOR LARGER PIPE THE CONTRACTOR SHALL PROVIDE 6" CONNECTION WITH SADDLE AND TAP.



**SANITARY SERVICE LATERAL WITH CLEANOUT**  
NO SCALE

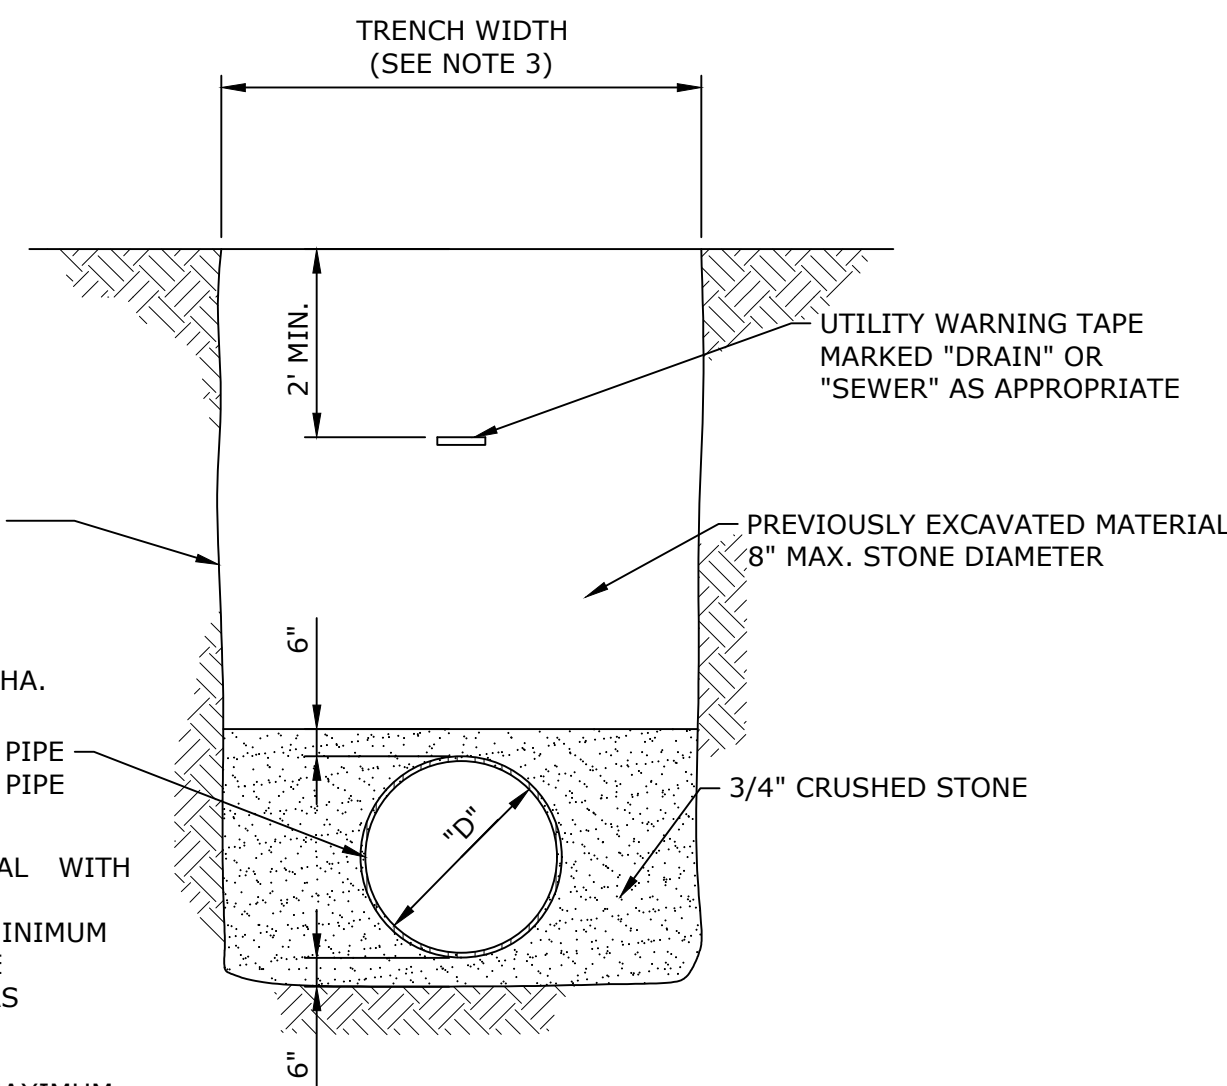


CONTRACTOR TO PROVIDE TRENCH BOX, SHEETING OR OTHER MEANS ACCORDING TO OSHA STANDARDS. THE CONTRACTOR SHALL BE RESPONSIBLE FOR ALL SAFETY REQUIREMENTS ACCORDING TO OSHA.

- NOTES:**
1. COMPACT ALL BACKFILL MATERIAL WITH VIBRATORY PLATE EQUIPMENT (MINIMUM TWO PASSES) TO A MINIMUM DENSITY OF 95 PERCENT OF THE STANDARD PROCTOR DENSITY AS DETERMINED BY ASTM D698.
  2. PLACE BACKFILL MATERIAL IN MAXIMUM ONE FOOT LIFTS.
  3. FOR PIPES LESS THAN 24" IN DIAMETER THE TRENCH WIDTH SHALL BE 5.0'. FOR PIPES 24" IN DIAMETER AND GREATER, TRENCH WIDTH SHALL BE THE PIPE DIAMETER + 3.0'.


**TYPICAL SEWER TRENCH SECTION**  
NO SCALE

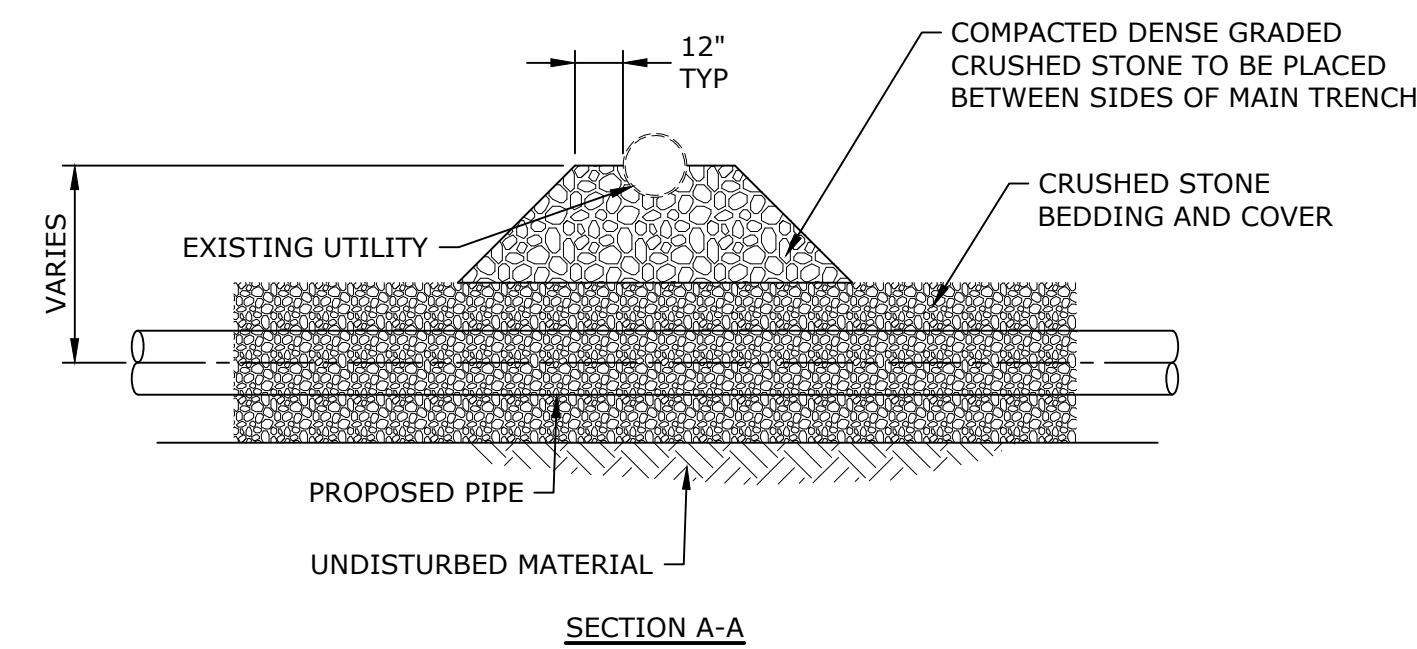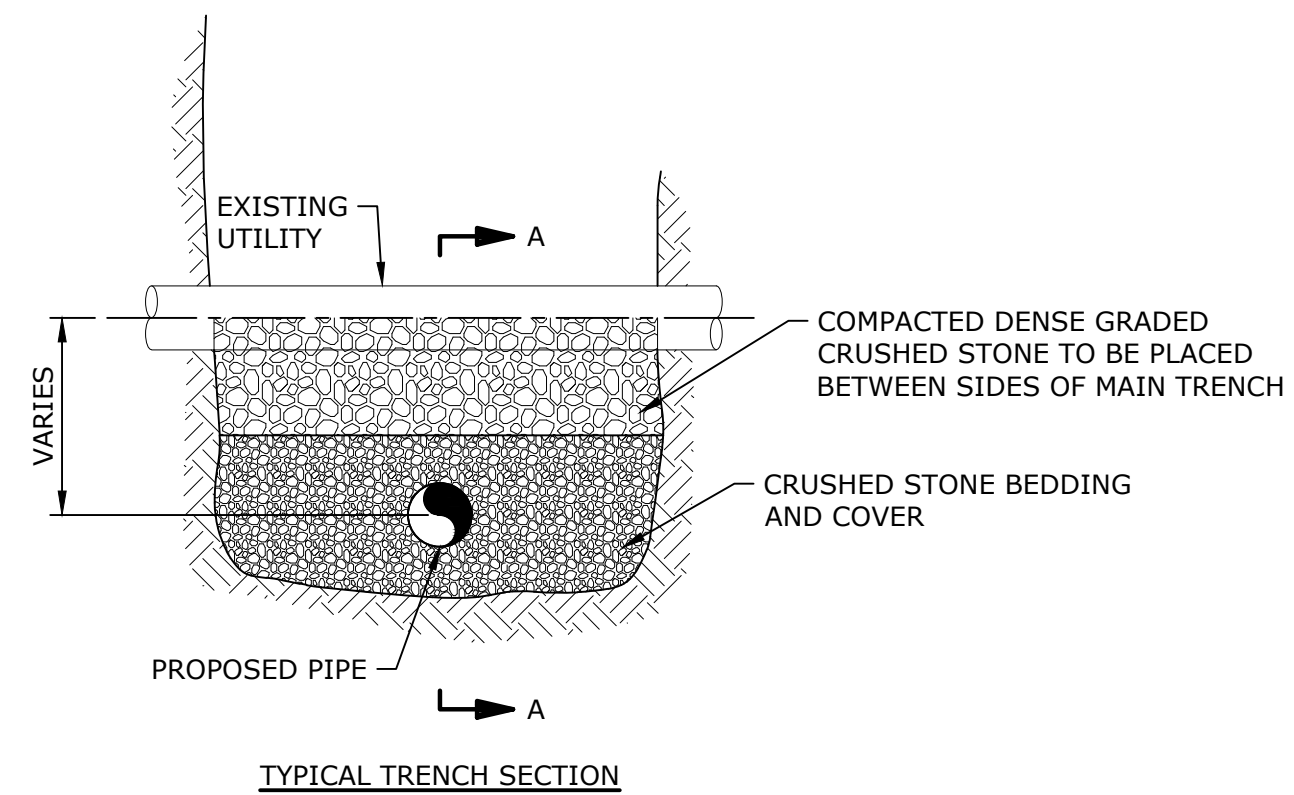

**UTILITY CROSSING DETAIL**  
NO SCALE

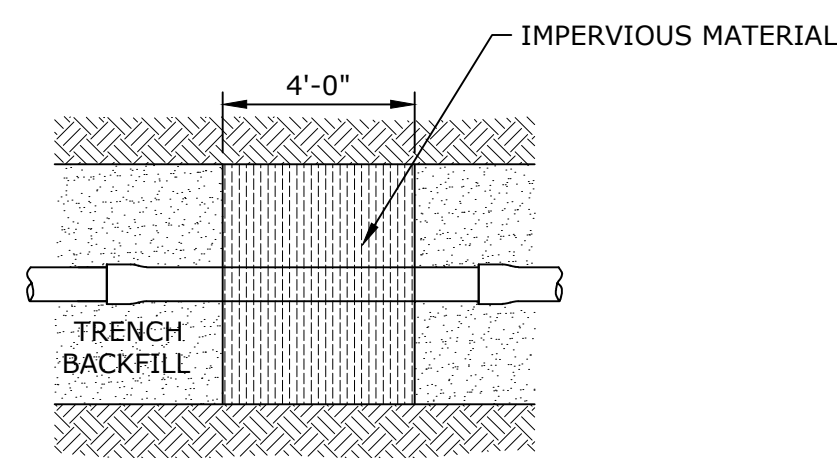

- NOTES:**
1. IMPERVIOUS MATERIAL SHALL HAVE A COEFFICIENT OF PERMEABILITY NOT TO EXCEED 10<sup>-7</sup> CM/SEC
  2. IMPERVIOUS TRENCH DAMS SHALL BE INSTALLED AT 100' O.C. INTERVALS (MIN)

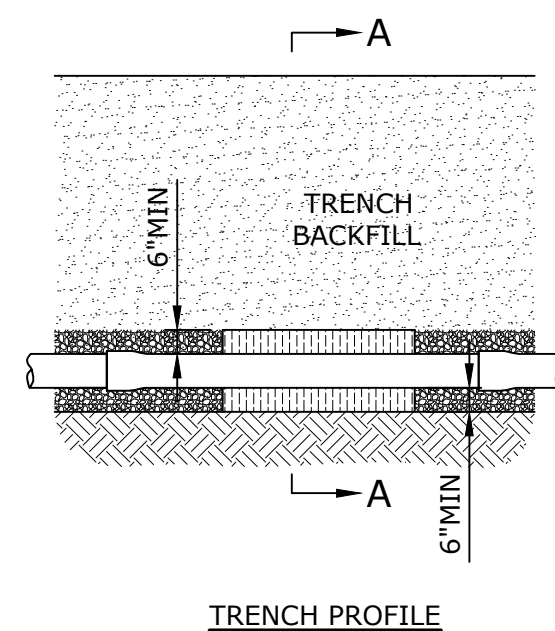

**IMPERVIOUS TRENCH DAMS**  
NO SCALE

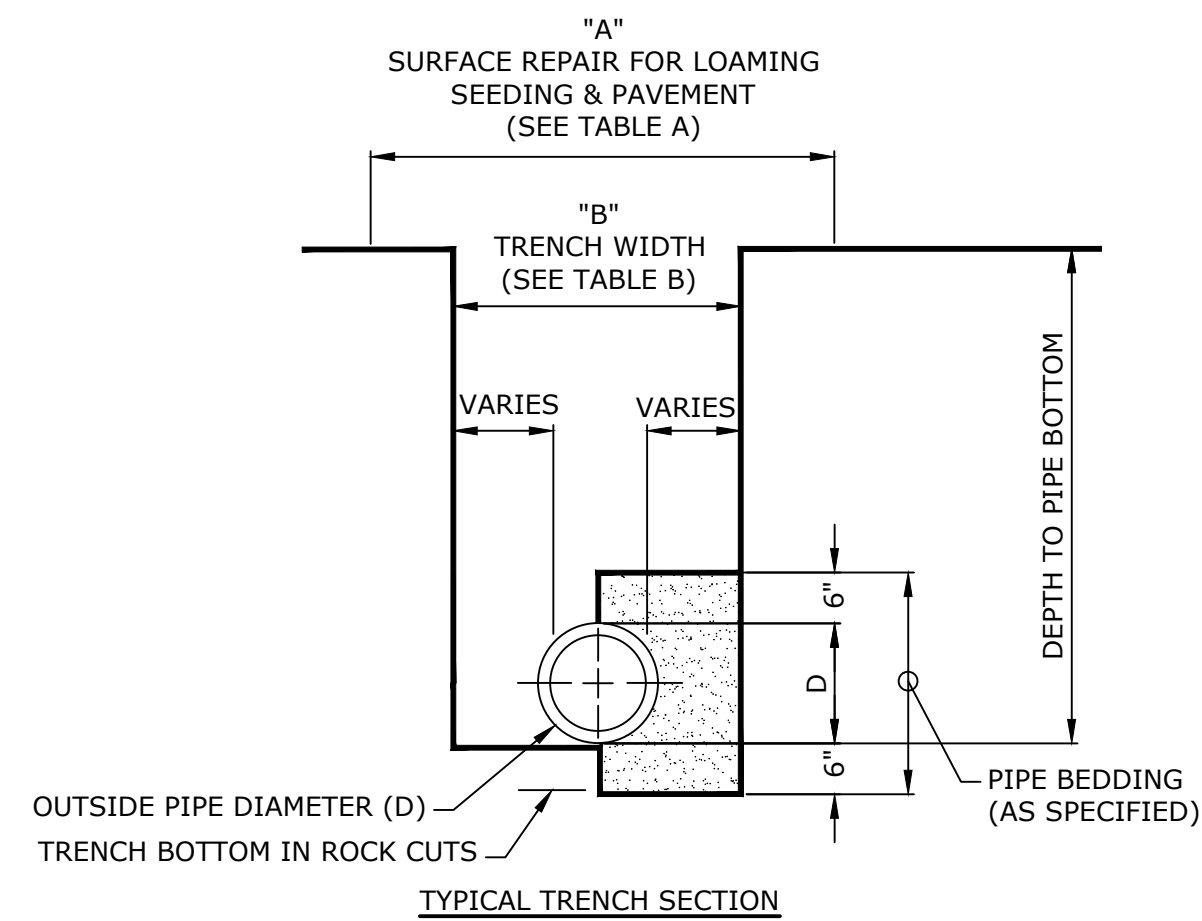
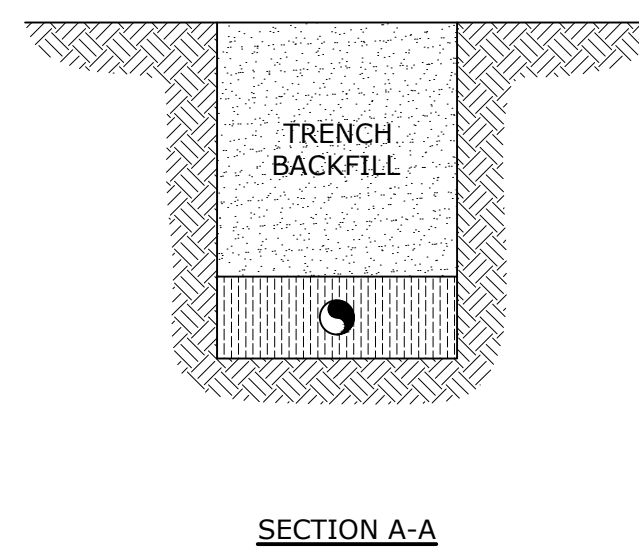


TABLE A - MAXIMUM SURFACE REPAIR PAY WIDTHS (SEE NOTE)			
OUTSIDE PIPE DIAMETER 0 - 24"		OUTSIDE PIPE DIAMETER GREATER THAN 24"	
TEMPORARY PAVEMENT	PERMANENT PAVEMENT & LOAMING & SEEDING	TEMPORARY PAVEMENT	PERMANENT PAVEMENT & LOAMING & SEEDING
6'-6" MAX.	8'-6" MAX.	D + 4'-0" MAX.	D + 6'-0" MAX.

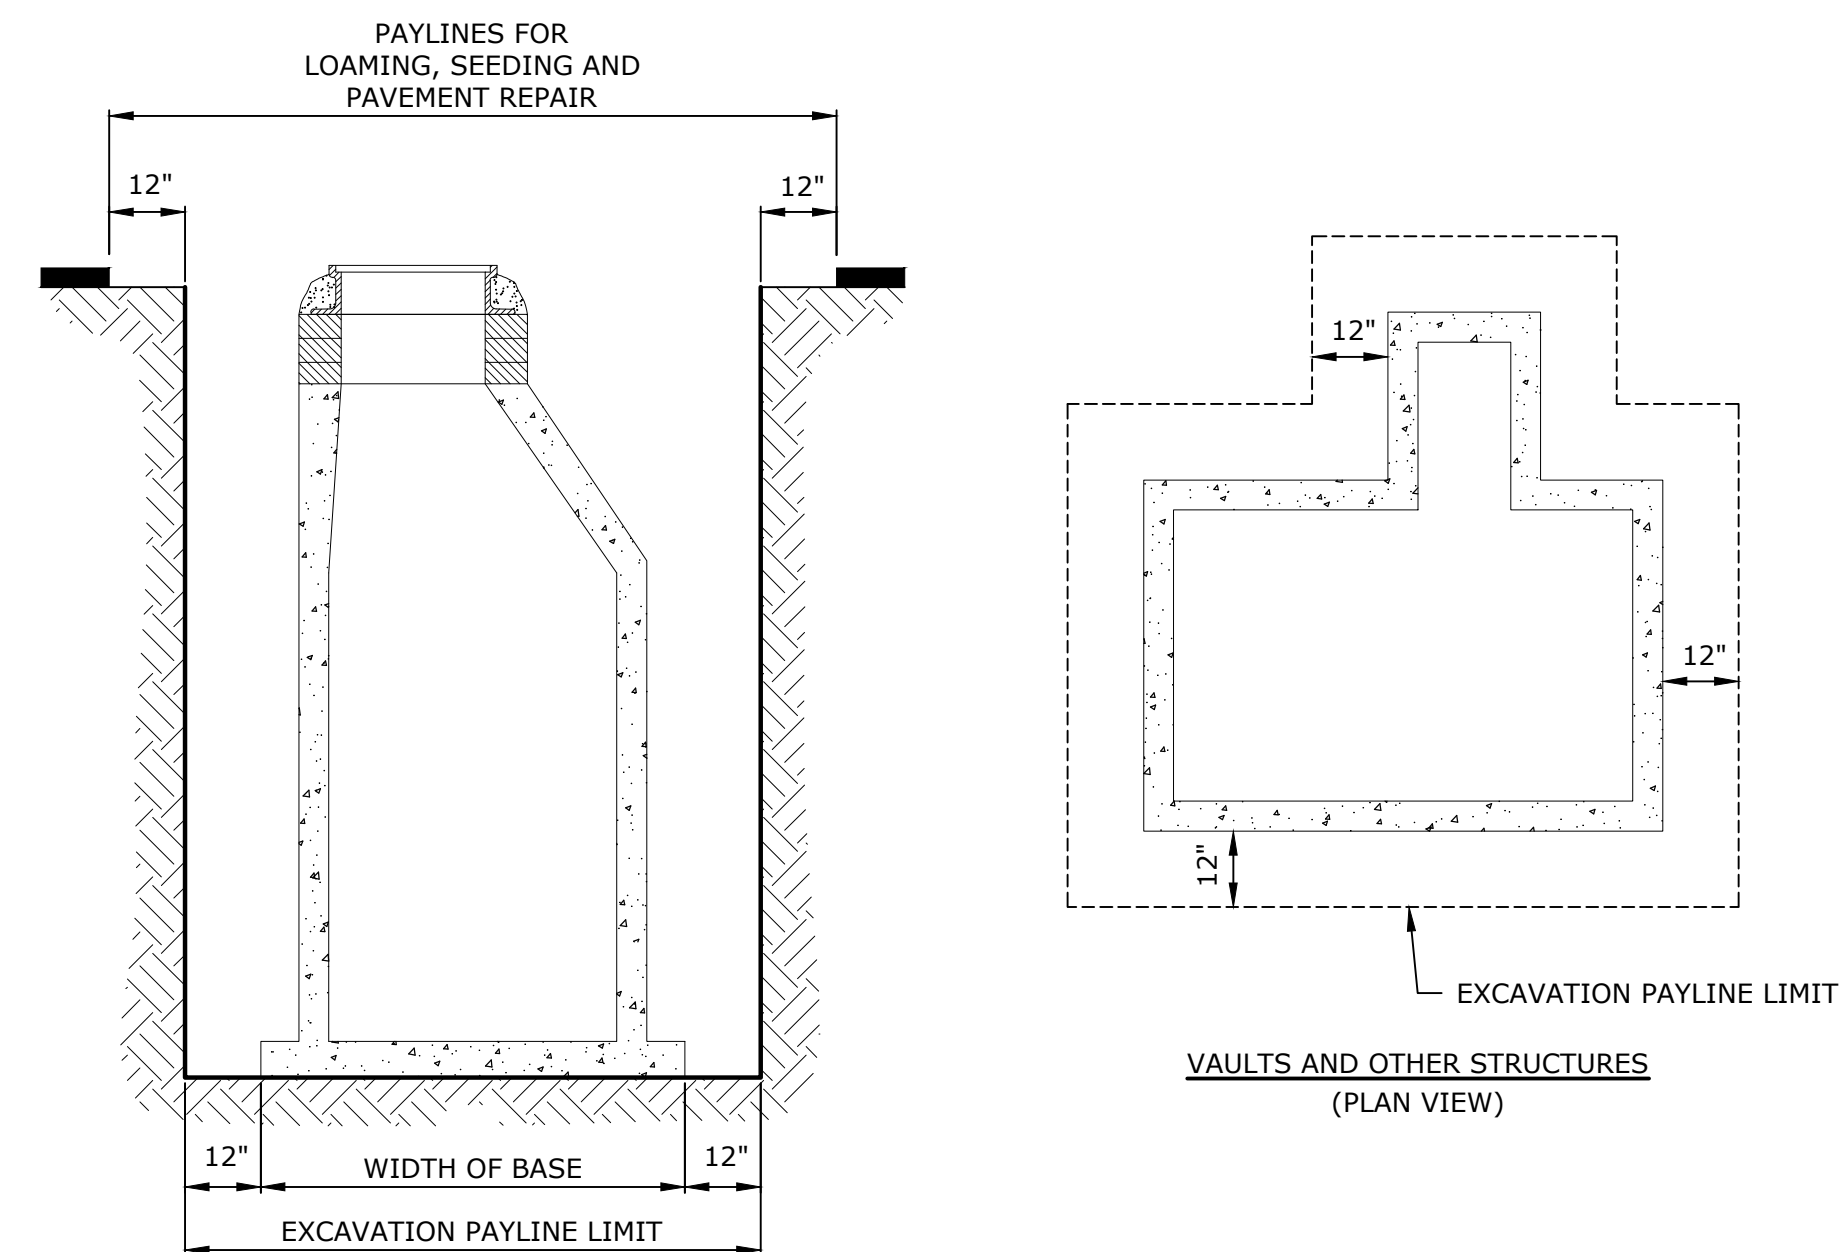
  

TABLE B - MAXIMUM TRENCH EXCAVATION PAY WIDTHS (SEE NOTE)	
OUTSIDE PIPE DIAMETER 0 - 24"	OUTSIDE PIPE DIAMETER GREATER THAN 24"
5'-0"	D + 3'-0"



**NOTE:**

THE PAYLINE DIMENSIONS SHOWN REPRESENT THE MAXIMUM PAYLINE LIMITS TO BE PAID. WHEN THE ACTUAL SURFACE REPAIR OR TRENCH WIDTH IS LESS, THE ACTUAL WIDTH SHALL BE PAID FOR AT THE APPLICABLE UNIT PRICE.

**TRENCH PAYLINES**  
NO SCALE



**PAYLINES FOR STRUCTURES**  
NO SCALE

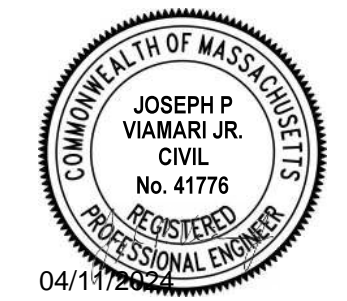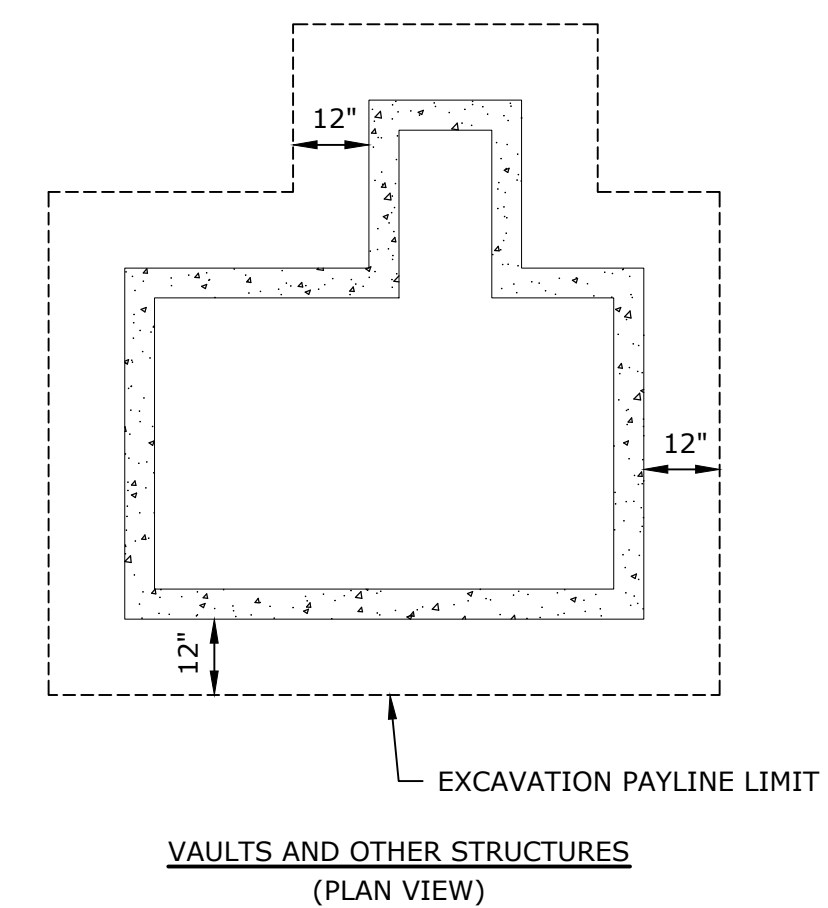

**Stevens Mill Sewer and Sidewalk Replacement Project**

Town of Dudley


Dudley, MA

MARK	DATE	DESCRIPTION
0	04/10/2024	ISSUED FOR BIDDING
PROJECT NO: D5011-018		
DATE: 04/2024		
FILE: Details.dwg		
DRAWN BY: ND/ABS		
CHECKED BY: MPW		
APPROVED BY: JPV		

SITE DETAILS - 3


SCALE: AS SHOWN

C-503

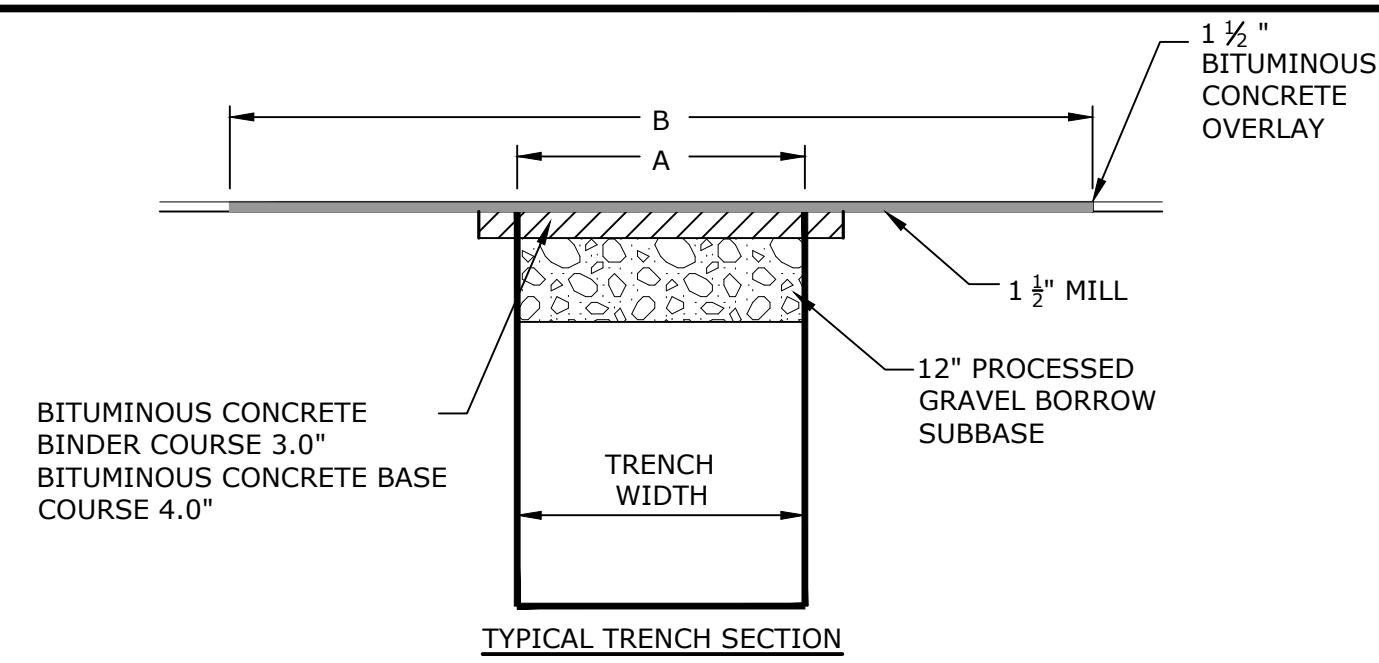


A = TRENCH PATCH PAYLINE LIMIT, WHICH SHALL BE THE ACTUAL PAVEMENT PATCH WIDTH REPAIRED, UP TO A MAXIMUM WIDTH OF 6'-6" FOR PIPES LESS THAN OR EQUAL TO 24" DIAMETER AND THE PIPE DIAMETER PLUS 4 FT FOR PIPES GREATER THAN 24" DIAMETER.

B = FULL WIDTH PAVEMENT OVERLAY PAYLINE LIMIT, WHICH SHALL BE THE ACTUAL EXISTING ROADWAY WIDTH.

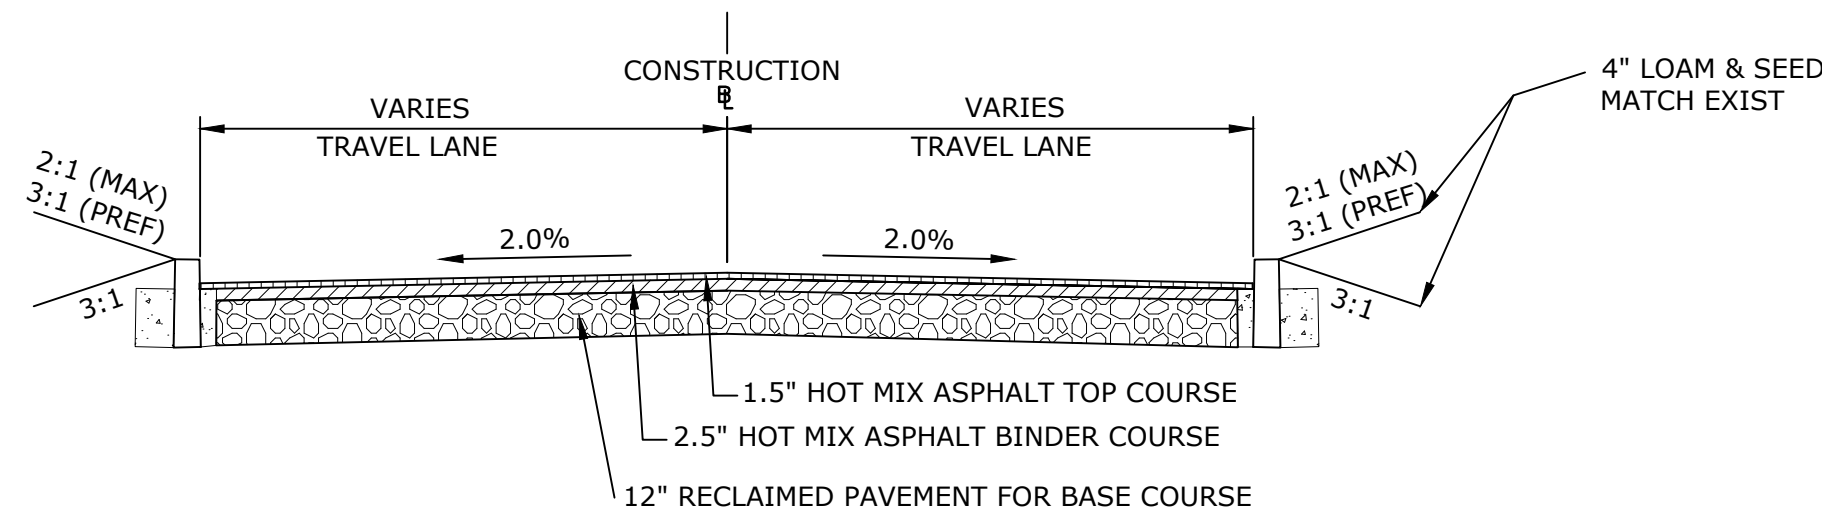


- NOTE:**
- ROAD SECTION SHOWN IS CONSIDERED TYPICAL. FIELD MODIFICATIONS TO MATCH EXISTING CONDITIONS ARE ANTICIPATED.
  - GRANITE CURB TO BE INSTALLED AS SHOWN ON THE PLANS.
  - REMOVE AND DISPOSE OF EXCESS MATERIAL.

**TYPICAL PAVEMENT RECLAMATION SECTION**  
NO SCALE

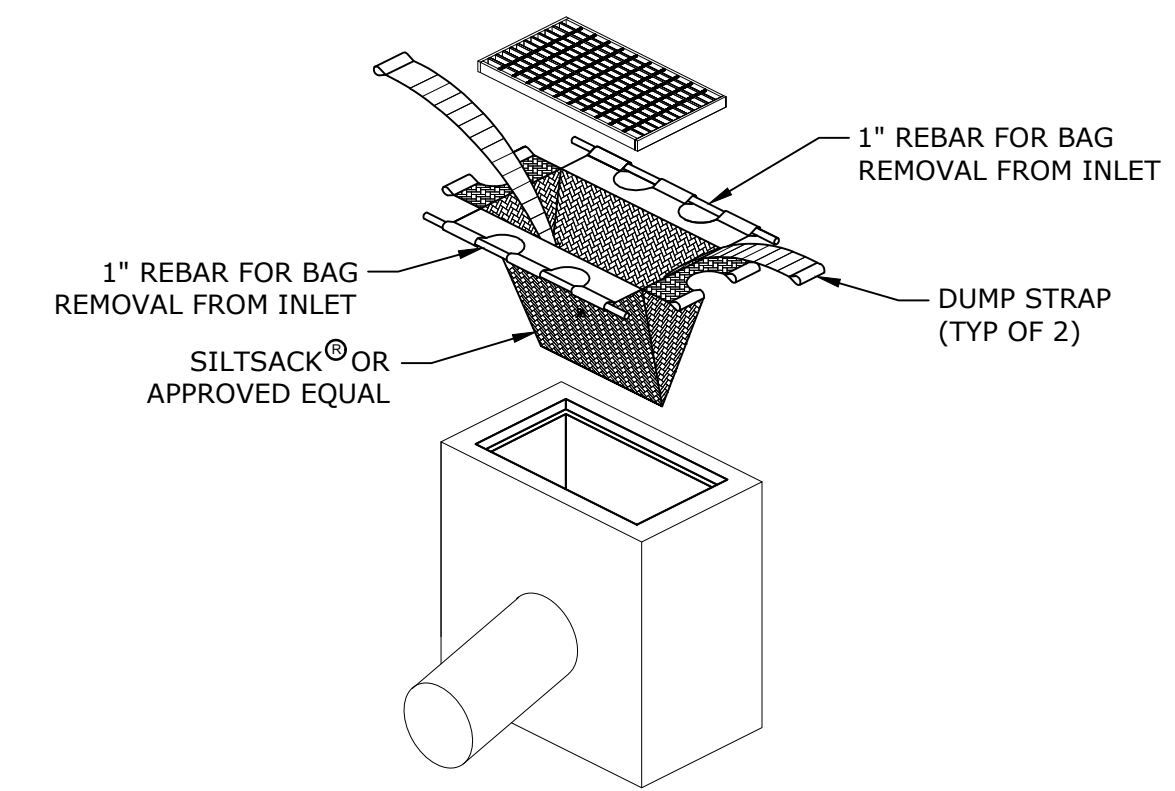


**CATCH BASIN SEDIMENTATION CONTROL DEVICE**  
NO SCALE

**FULL WIDTH MILL AND OVERLAY - WEST MAIN STREET**  
NO SCALE

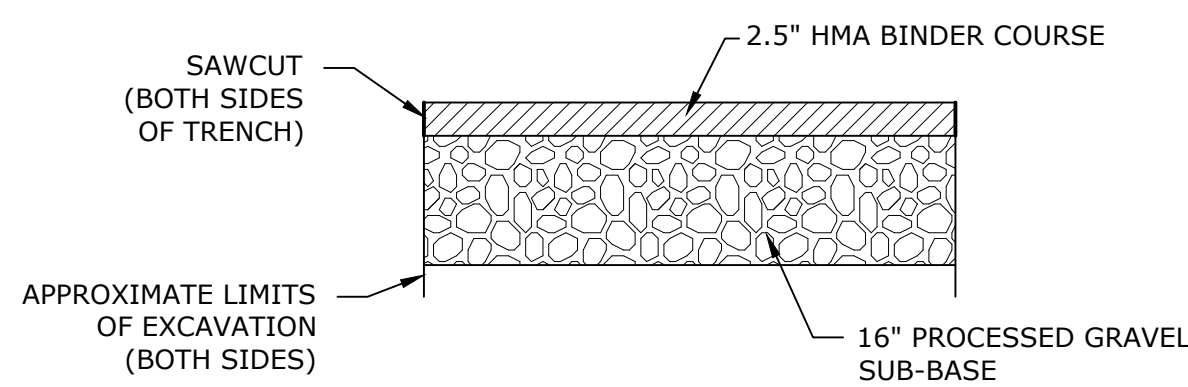


- NOTES:**
- PLACED WEEKLY ON FRIDAYS (OR LAST DAY OF THE WORK WEEK) ON TOWN ROADS.
  - ANY ROUGH OR DAMAGED TRENCH EDGES SHALL BE SAWCUT CLEAN AND REPAVED.

**TEMPORARY TRENCH REPAIR**  
NO SCALE

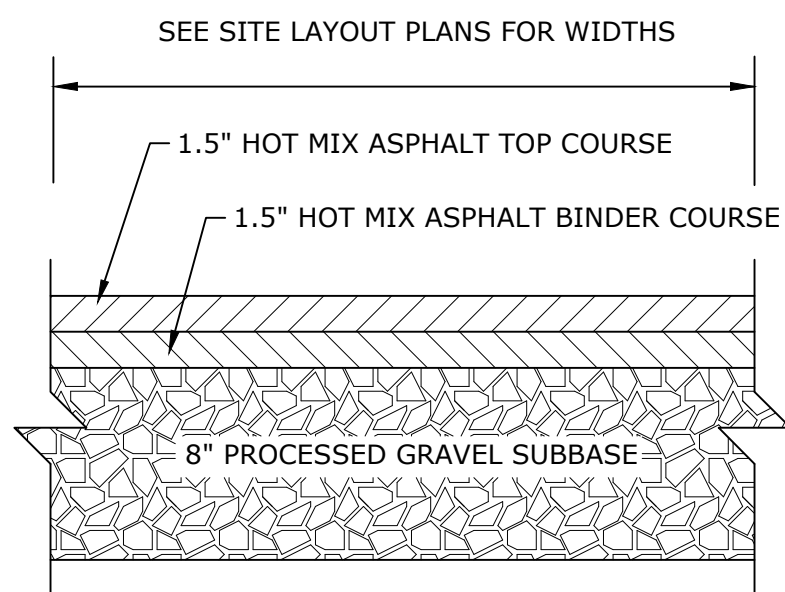


**HMA DRIVEWAY AND SIDEWALK REPAIR**  
NO SCALE

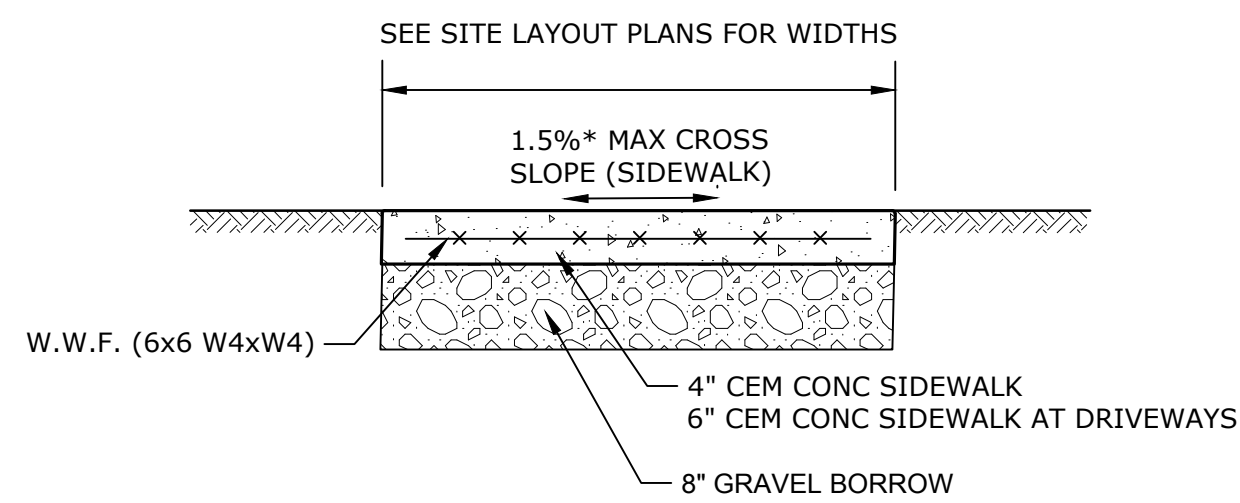

**CEMENT CONCRETE SIDEWALK SECTION**  
NO SCALE



\* TOLERANCE FOR CROSS SLOPE ±.5%

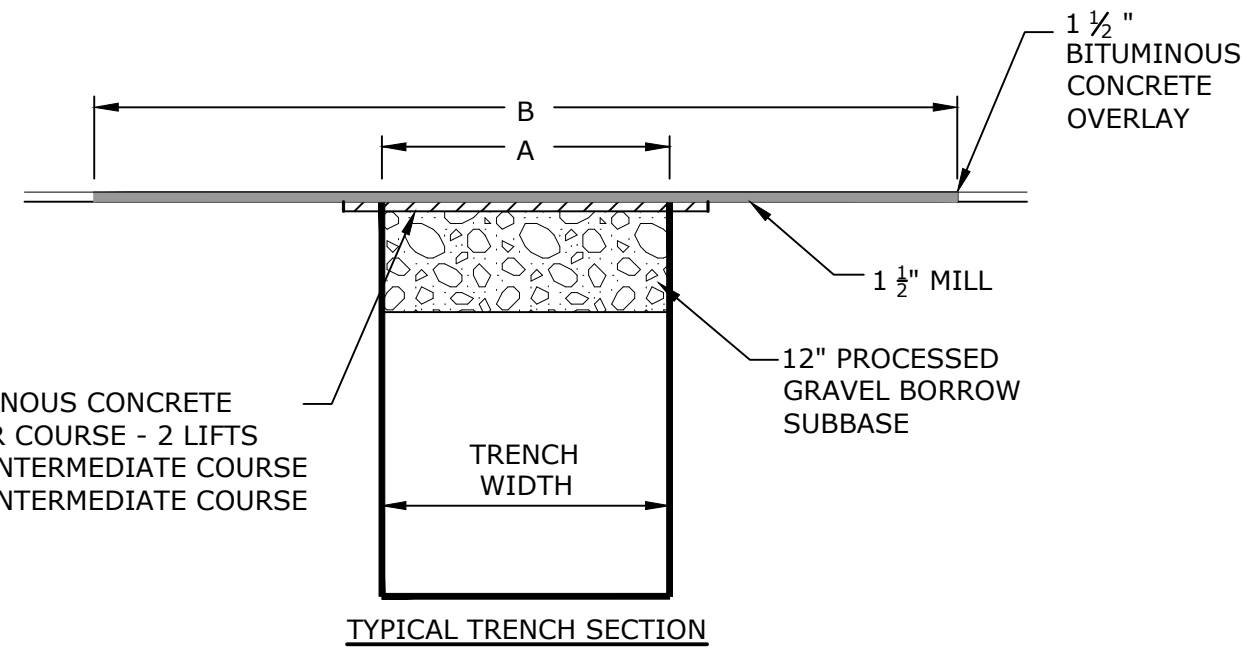



A = TRENCH PATCH PAYLINE LIMIT, WHICH SHALL BE THE ACTUAL PAVEMENT PATCH WIDTH REPAIRED, UP TO A MAXIMUM WIDTH OF 6'-6" FOR PIPES LESS THAN OR EQUAL TO 24" DIAMETER AND THE PIPE DIAMETER PLUS 4 FT FOR PIPES GREATER THAN 24" DIAMETER.

B = FULL WIDTH PAVEMENT OVERLAY PAYLINE LIMIT, WHICH SHALL BE THE ACTUAL EXISTING ROADWAY WIDTH.

**FULL WIDTH MILL AND OVERLAY - VILLIAGE STREET**  
NO SCALE

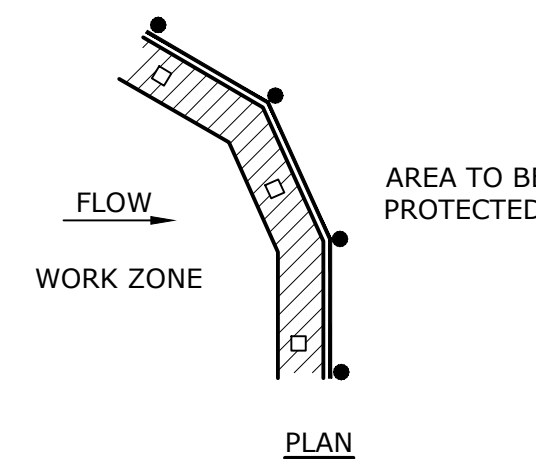
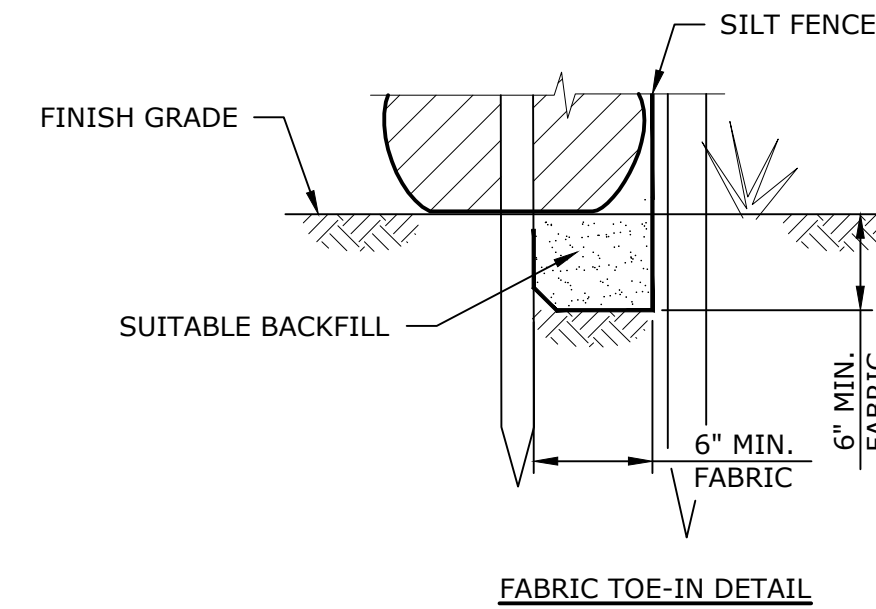


**EROSION CONTROL BARRIER DETAIL**  
NO SCALE

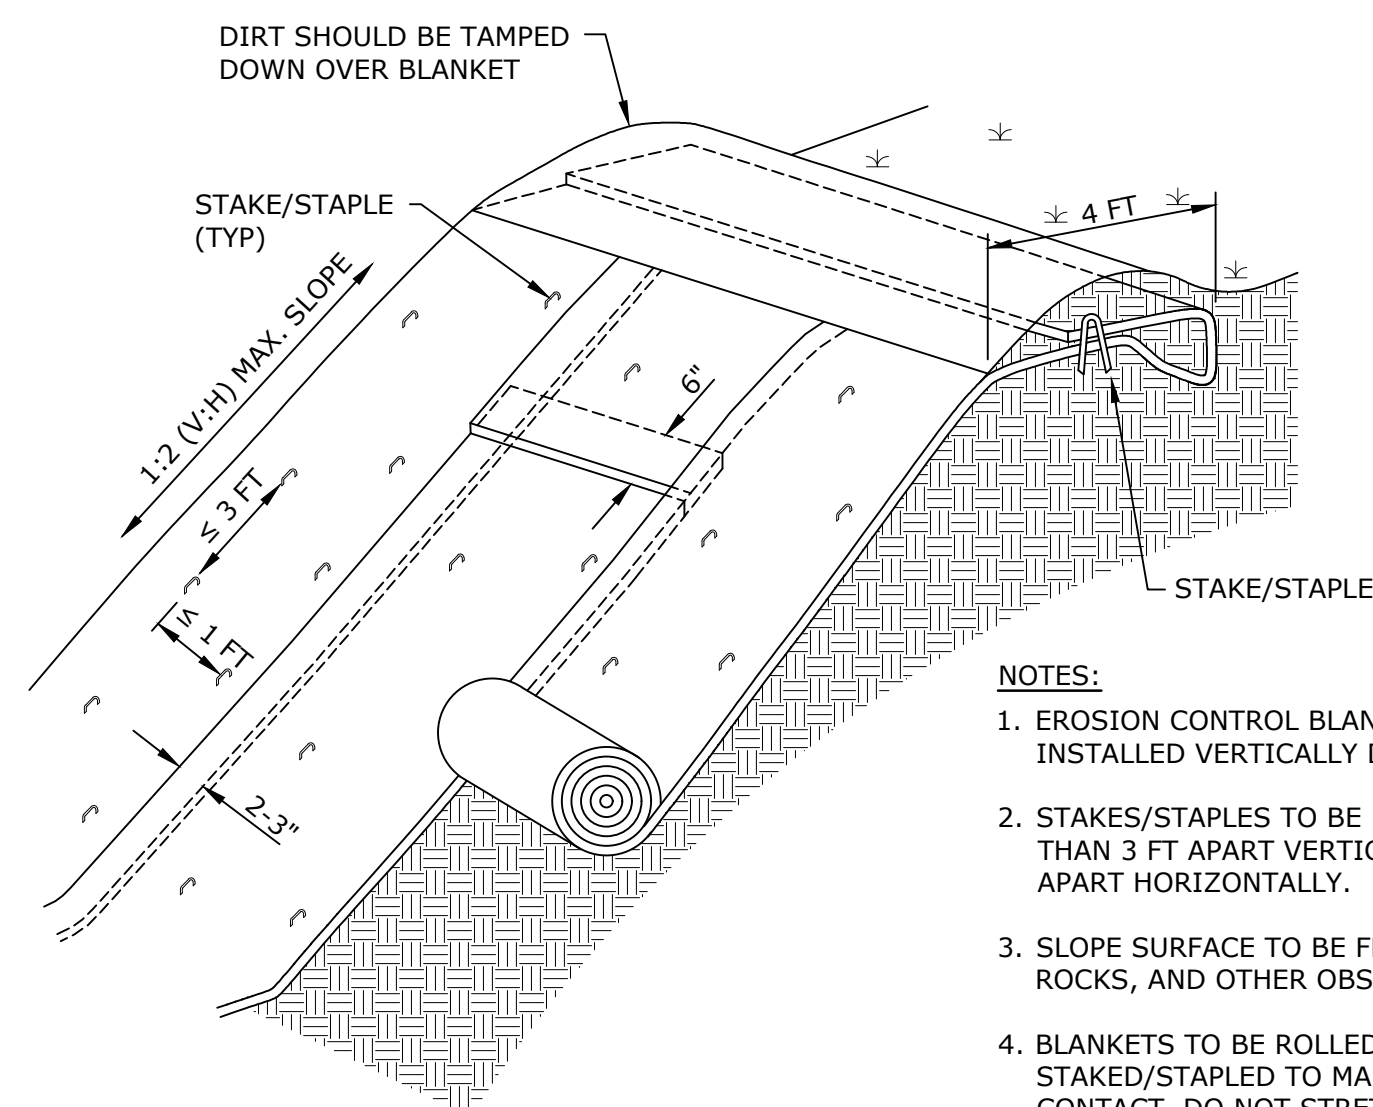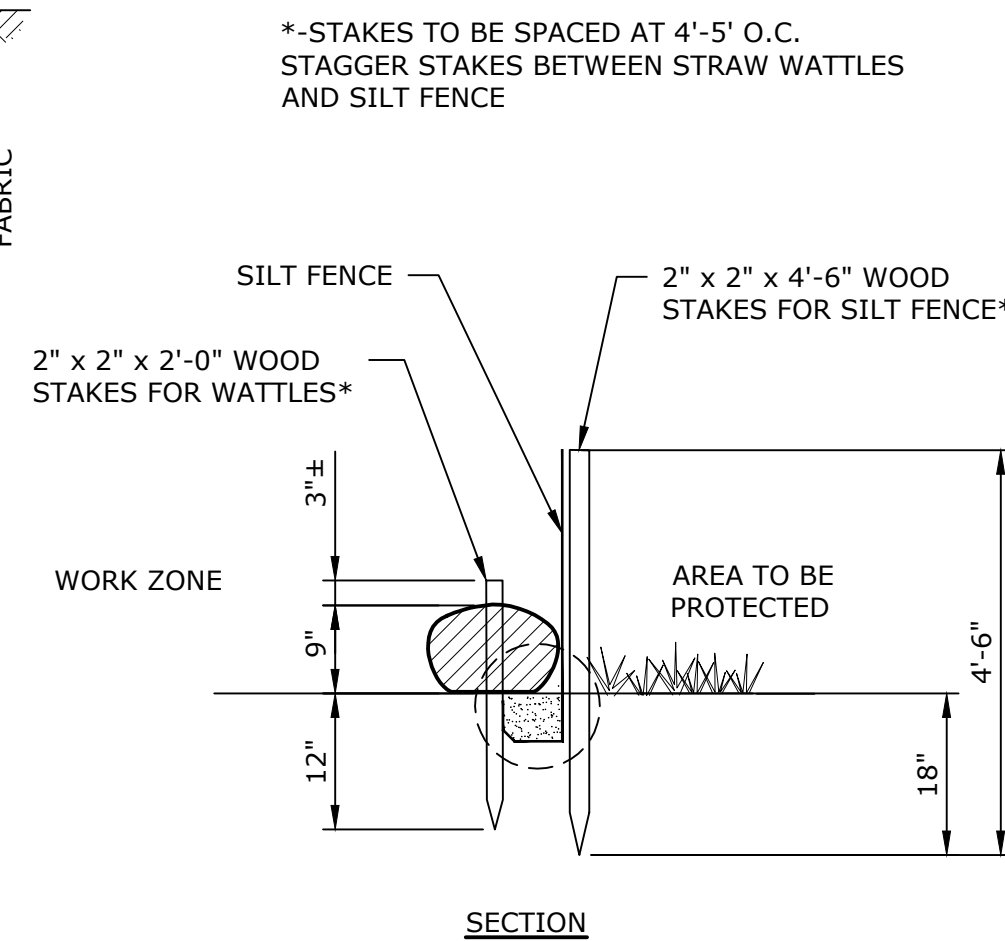


- NOTES:**
- EROSION CONTROL BLANKET TO BE INSTALLED VERTICALLY DOWNSLOPE.
  - STAKES/STAPLES TO BE PLACED NO MORE THAN 3 FT APART VERTICALLY, AND 1 FT APART HORIZONTALLY.
  - SLOPE SURFACE TO BE FREE OF STICKS, ROCKS, AND OTHER OBSTRUCTIONS.
  - BLANKETS TO BE ROLLED OUT LOOSELY AND STAKED/STAPLED TO MAINTAIN DIRECT SOIL CONTACT. DO NOT STRETCH THE BLANKETS.
  - AREA TO BE SEEDED WITH SLOPE RESTORATION SEED MIX.

**EROSION CONTROL BLANKET**  
NO SCALE

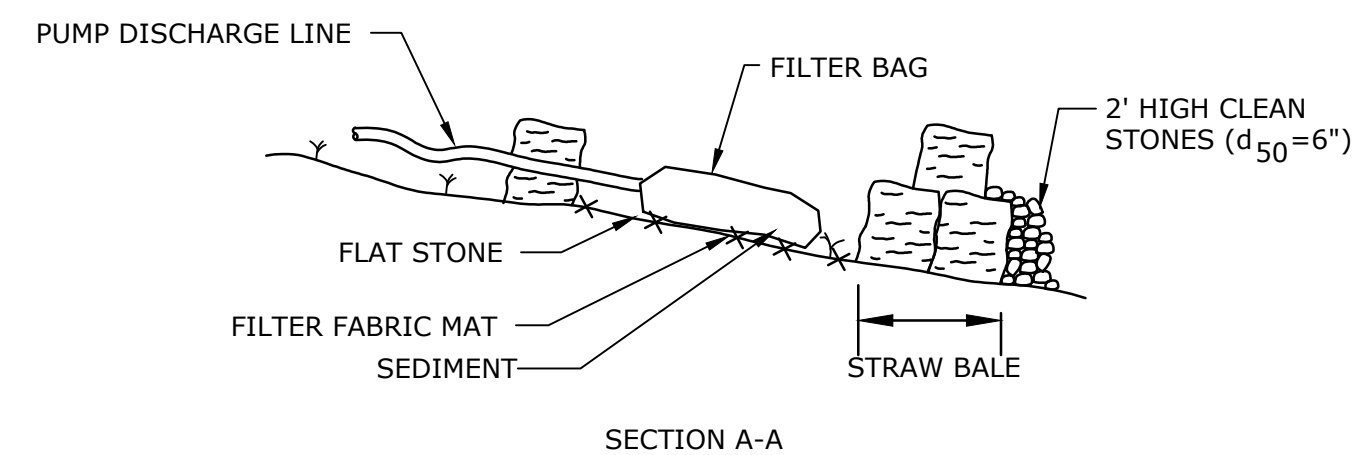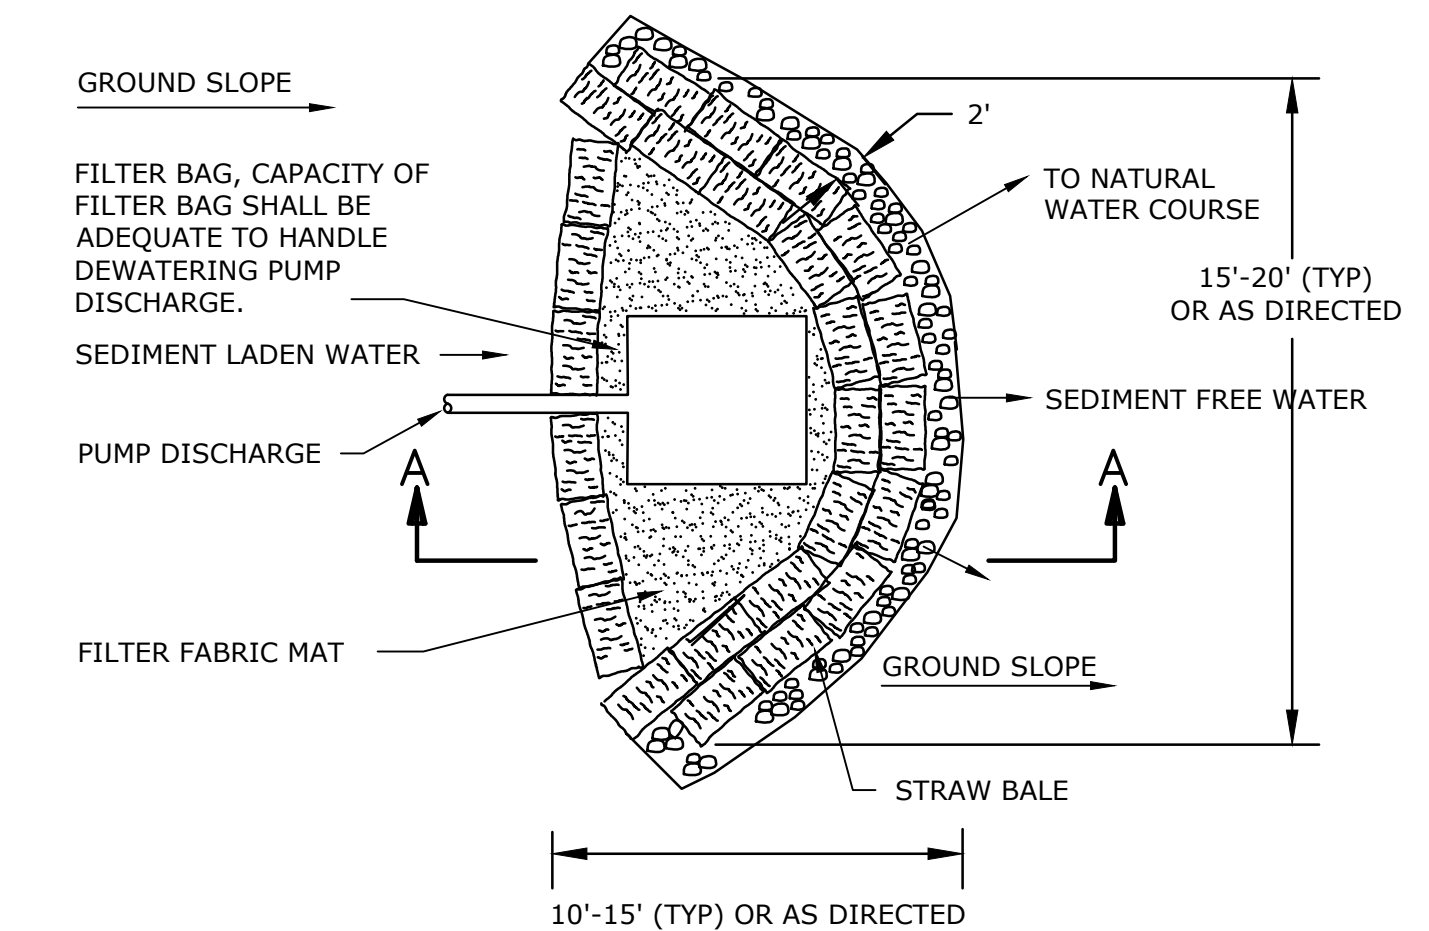

**SEDIMENTATION DEWATERING BASIN**  
NO SCALE

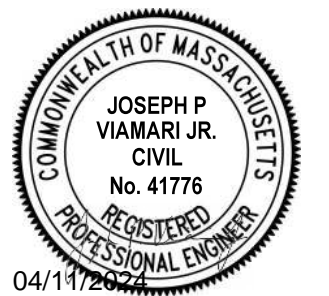

**Stevens Mill Sewer and Sidewalk Replacement Project**

Town of Dudley

Dudley, MA

MARK	DATE	DESCRIPTION
0	04/10/2024	ISSUED FOR BIDDING
	04/2024	
		Details.dwg
		ND/ABS
		MPW
		JPV


SITE DETAILS - 4

SCALE: AS SHOWN

C-504

**TRAFFIC SIGN SUMMARY**



IDENTIFICATION NUMBER	SIZE OF SIGN		TEXT	NUMBER OF SIGNS REQ'D		TEXT DIMENSIONS (inches)						COLOR			POST SIZE AND NUMBER REQUIRED		AREA IN SQUARE FEET		NOTES			
	WIDTH (inches)	HEIGHT (inches)		BASE BID	ALTERNATE 2	LETTER HEIGHT	VERTICAL SPACING	ARROW RTE MKR	BACK-GROUND	LEGEND	BORDER	BASE BID	ALTERNATE 2	BASE BID	ALTERNATE 2							
W11-2	36	36		-	4	SEE MUTCD STANDARDS																
W16-7P	30	18		-	2																	
R1-1	30	30		5	-																	
W16-9P	24	12		-	2																	
R10-7	24	30		1	-																	
				<b>TOTALS</b>																		

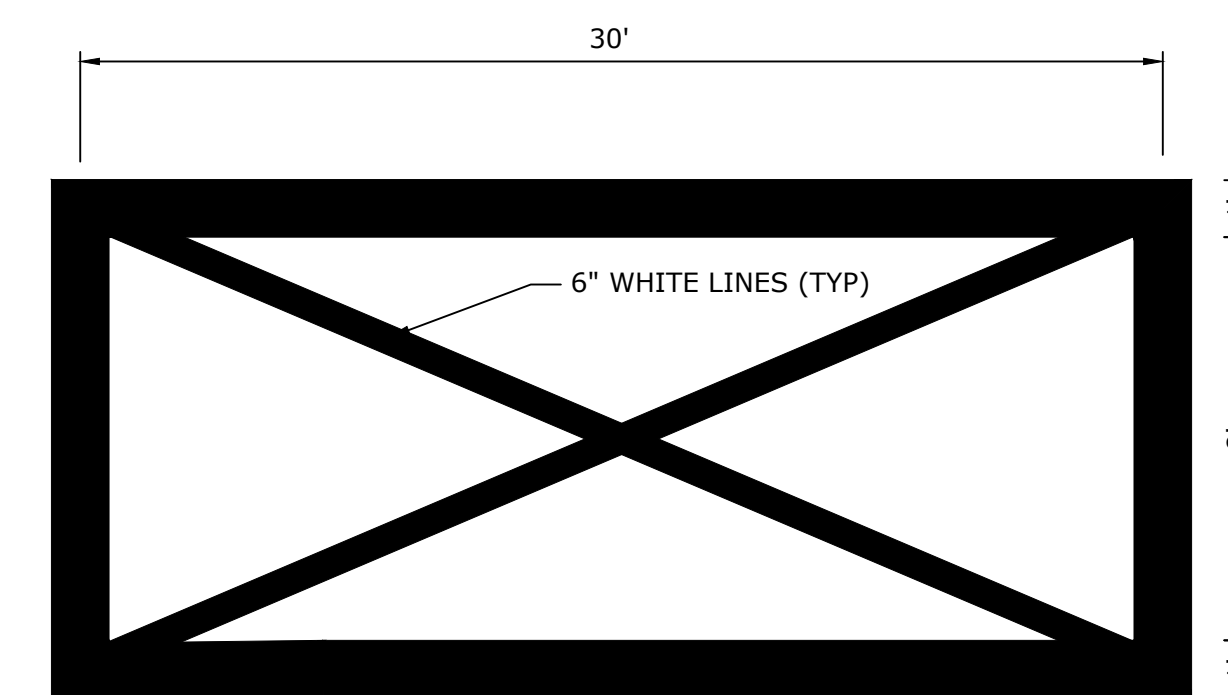

**DO NOT BLOCK INTERSECTION DETAIL**  
NO SCALE

NOTE:

1. CONTRACTOR TO USE REFLECTIVE WHITE PAINT
2. PAVEMENT MARKING MATERIALS AND LAYOUT TO CONFORM TO RELEVANT PROVISIONS OF THE MASSDOT STANDARD SPECIFICATIONS AND THE MUTCD STANDARDS

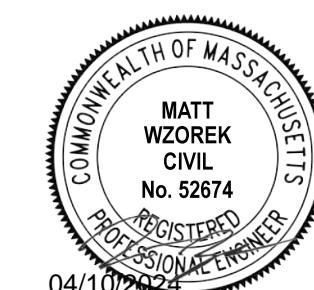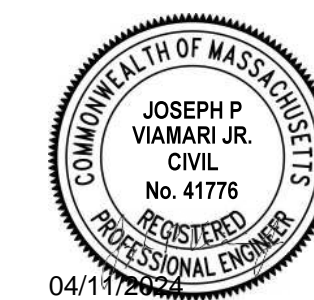

**Stevens Mill  
Sewer and  
Sidewalk  
Replacement  
Project**

Town of Dudley



Dudley, MA

0	04/10/2024	ISSUED FOR BIDDING
MARK	DATE	DESCRIPTION
PROJECT NO: DS011-018		
DATE: 04/2024		
FILE: Details.dwg		
DRAWN BY: ND/ABS		
CHECKED BY: MPW		
APPROVED BY: JPV		

SITE DETAILS - 5

SCALE: AS SHOWN

**C-505**

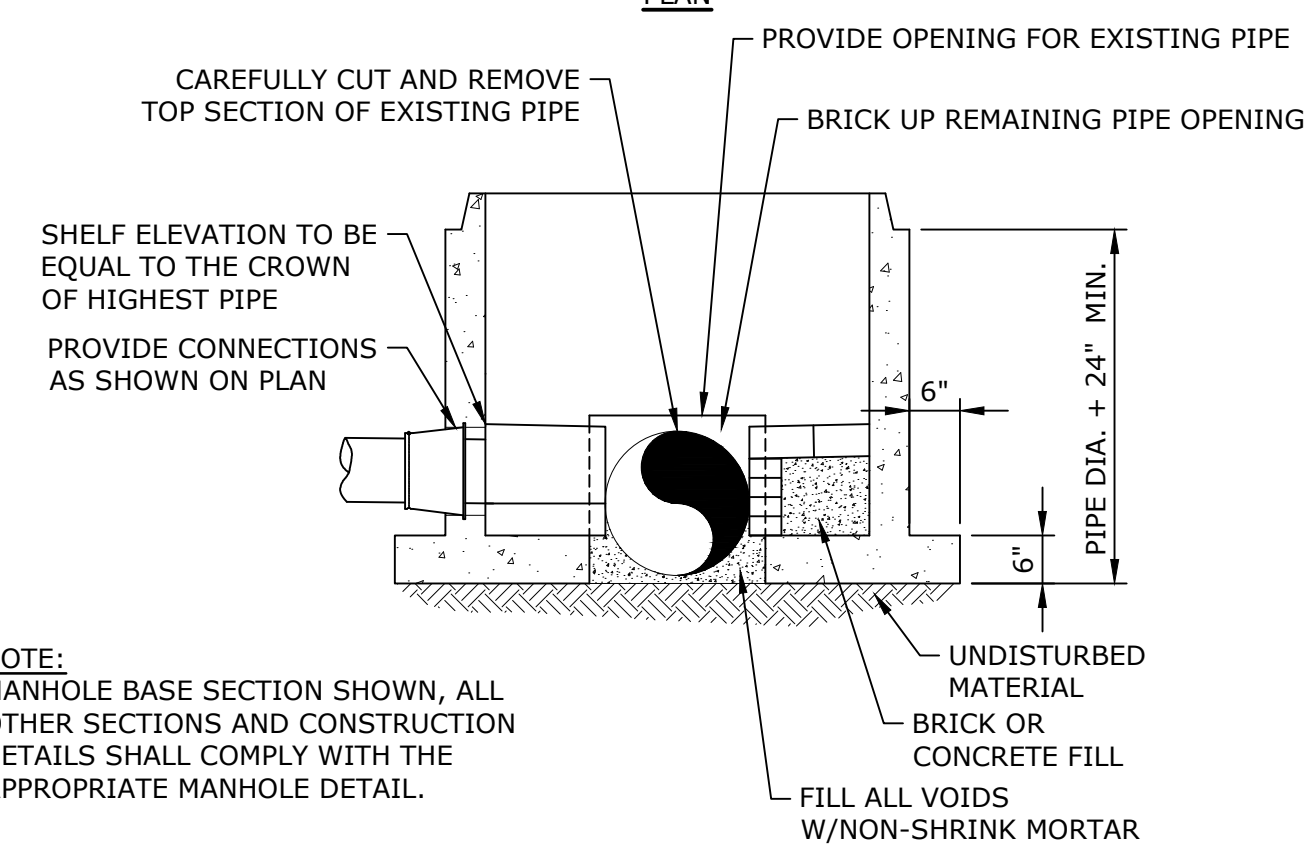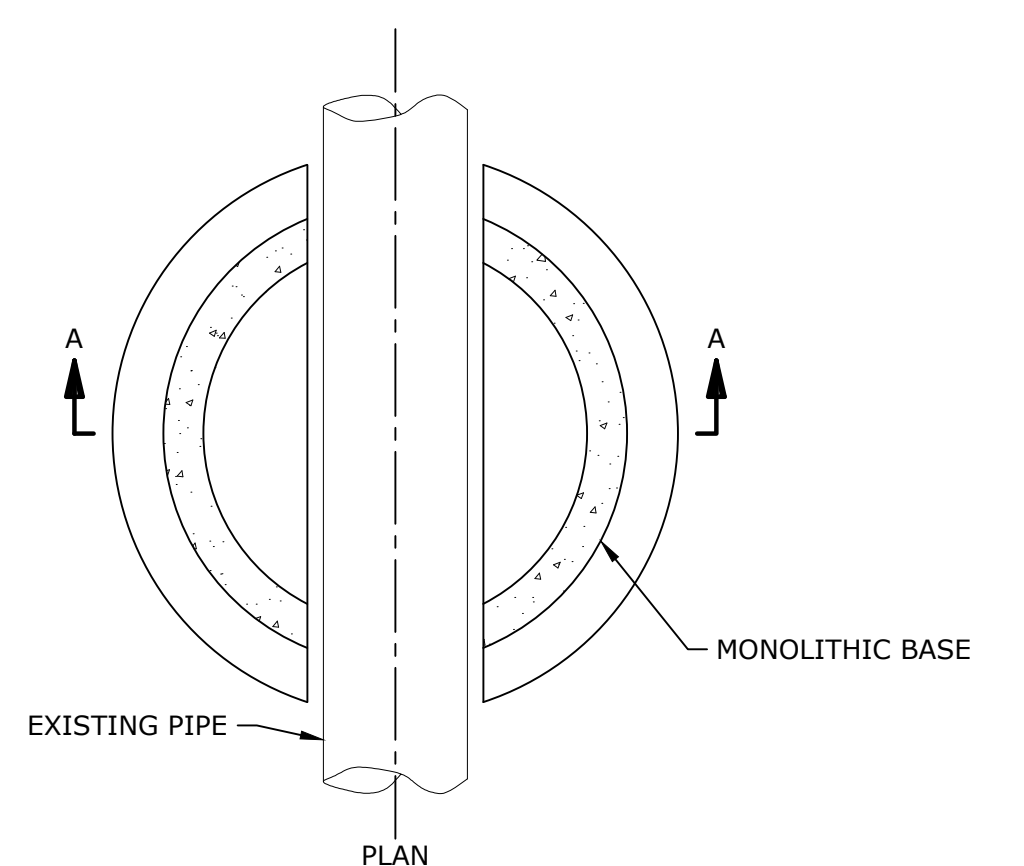

NOTE:  
MANHOLE BASE SECTION SHOWN, ALL OTHER SECTIONS AND CONSTRUCTION DETAILS SHALL COMPLY WITH THE APPROPRIATE MANHOLE DETAIL.

**PRECAST "DOGHOUSE"  
MANHOLE BASE**  
NO SCALE



**GENERAL NOTES:**

- ALL TEMPORARY TRAFFIC CONTROL WORK SHALL CONFORM TO THE LATEST ADOPTED EDITION OF THE "MANUAL ON UNIFORM TRAFFIC CONTROL DEVICES" (MUTCD) AND ALL REVISIONS AND MASSACHUSETTS AMENDMENTS, UNLESS SUPERCEDED BY THESE PLANS.
- ALL SIGN LEGENDS, BORDERS, AND MOUNTING SHALL BE IN ACCORDANCE WITH THE MUTCD.
- TEMPORARY CONSTRUCTION SIGNING AND ALL OTHER TRAFFIC CONTROL DEVICES SHALL BE IN PLACE PRIOR TO THE START OF ANY WORK.
- TEMPORARY CONSTRUCTION SIGNING, BARRICADES, AND ALL OTHER NECESSARY WORK ZONE TRAFFIC CONTROL DEVICES SHALL BE REMOVED FROM THE HIGHWAY OR COVERED WHEN THEY ARE NOT REQUIRED FOR CONTROL OF TRAFFIC.
- SIGNS AND SIGN SUPPORTS LOCATED ON OR NEAR THE TRAVELED WAY, CHANNELIZING DEVICES, BARRIERS, AND CRASH ATTENUATORS MUST PASS THE CRITERIA SET FORTH IN NCHRP REPORT 350, "RECOMMENDED PROCEDURES FOR THE SAFETY PERFORMANCE EVALUATION OF HIGHWAY FEATURES" AND/OR "MANUAL FOR ASSESSING SAFETY HARDWARE" (MASH).
- CONTRACTORS SHALL NOTIFY EACH ABUTTER AT LEAST 24 HOURS IN ADVANCE OF THE START OF ANY WORK THAT WILL REQUIRE THE TEMPORARY CLOSURE OF ACCESS, SUCH AS CONDUIT INSTALLATION, EXISTING PAVEMENT EXCAVATION, TEMPORARY DRIVEWAY PAVEMENT PLACEMENT, AND SIMILAR OPERATIONS.
- THE FIRST FIVE PLASTIC DRUMS OF A TAPER SHALL BE MOUNTED WITH TYPE A LIGHTS.
- THE ADVISORY SPEED LIMIT, IF REQUIRED, SHALL BE DETERMINED BY THE ENGINEER.
- MAXIMUM SPACING OF TRAFFIC DEVICES IN A TAPER (DRUMS OR CONES) IS EQUAL IN FEET TO THE SPEED LIMIT IN MPH.
- MINIMUM LANE WIDTH IS TO BE 11 FEET UNLESS OTHERWISE SHOWN. MINIMUM LANE WIDTH TO BE MEASURED FROM THE EDGE OF DRUMS OR MEDIAN BARRIER.
- ALL SIGNS SHALL BE MOUNTED ON THEIR OWN STANDARD SIGN SUPPORTS.
- SIGN MA-R2-10a AND MA-R2-10e SHALL BE LOCATED AT THE PROJECT LIMITS FOR THE DURATION OF THE WORK.

**LEGEND:**

- REFLECTORIZED PLASTIC DRUM OR 36" CONE
- POLICE/FLAGGER DETAIL
- TYPE III BARRICADE
- ARROW BOARD
- WORK ZONE
- DIRECTION OF TRAFFIC
- SIGN

**WORK ZONES**  
SPEEDING FINES DOUBLED  
MA-R2-10a

**END ROAD WORK**  
DOUBLE FINES END  
MA-R2-10e


R2-10  
60"X48"

**WORK ZONE LIMIT SIGNS**  
SEE NOTE 12

**FORMULAS FOR DETERMINING TAPER LENGTHS**

SPEED LIMIT (S)	TAPER LENGTH (L) FEET
40 MPH OR LESS	$L = \frac{WS^2}{60}$
45 MPH OR MORE	$L = WS$


**WHERE:**  
L = TAPER LENGTH IN FEET  
W = WIDTH OF OFFSET IN FEET  
S = POSTED SPEED LIMIT, OR OFF-PEAK 85TH-PERCENTILE SPEED PRIOR TO WORK STARTING, OR THE ANTICIPATED OPERATING SPEED IN MPH

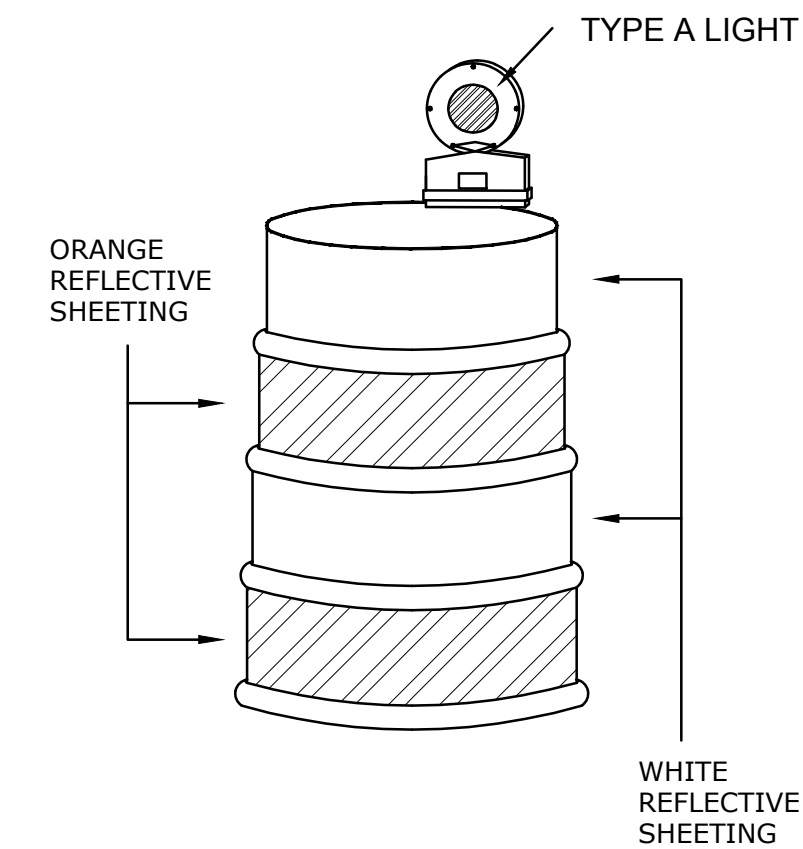


**NOTES:**

- DRUM DESIGN AND APPLICATION SHALL BE AS PER THE CURRENT EDITION OF THE MUTCD.
- DRUMS SHALL BE APPROXIMATELY 36" IN HEIGHT, HAVING A MINIMUM WALL THICKNESS OF 3/32" AND A MINIMUM DIAMETER OF 18" REGARDLESS OF ORIENTATION.
- DRUM MATERIAL MUST BE APPROVED UV RESISTANT, LOW DENSITY, IMPACT RESISTANT, LINEAR POLYETHYLENE (OR APPROVED EQUIVALENT).
- SHEETING SHALL BE APPROVED ORANGE AND WHITE TYPE IV REFLECTORIZED SHEETING CONFORMING TO M9.30.0.
- ALL DRUMS SHALL BE WELL MAINTAINED INCLUDING REMOVAL OF DUST OR ROAD FILM, SO AS NOT TO REDUCE REFLECTIVE EFFICIENCY. WHEN A DRUM LOSES TARGET VALUE IT SHALL BE REPLACED.
- STORE UNUSED DRUMS IN ONE LOCATION, AWAY FROM ALL TRAFFIC, OR REMOVE FROM SITE ENTIRELY.


**PLASTIC DRUMS**

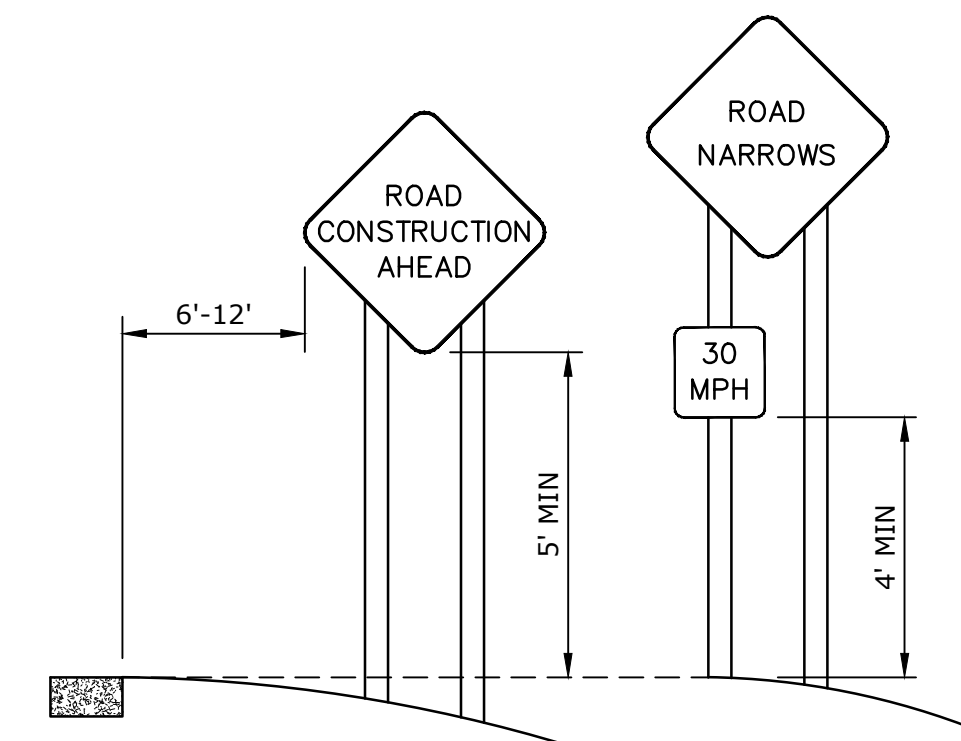

**TYPICAL INSTALLATION OF PROJECT SIGNS**

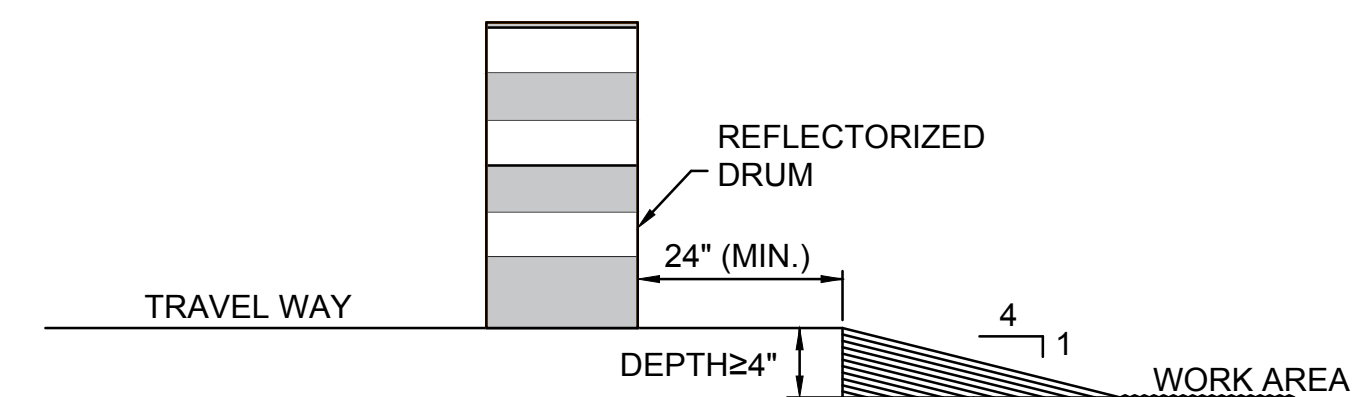


**LATERAL DROP-OFF DETAIL**  
NOT TO SCALE

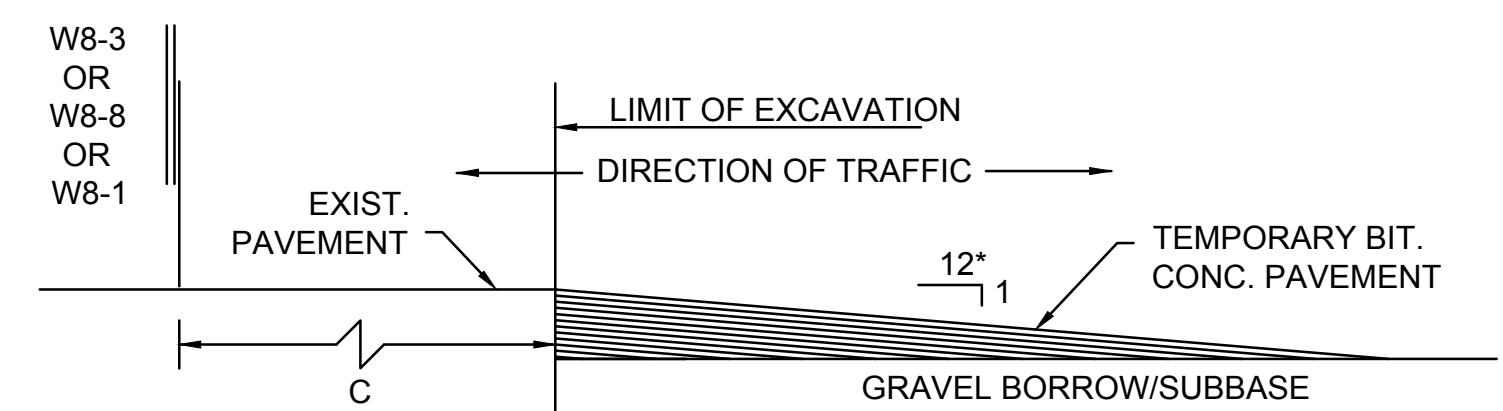


**LONGITUDINAL DROP-OFF DETAIL**  
NOT TO SCALE

\* - INCREASE SLOPE RATIO FOR HIGHER SPEEDS


**LATERAL AND LONGITUDINAL DROP-OFF DETAILS**

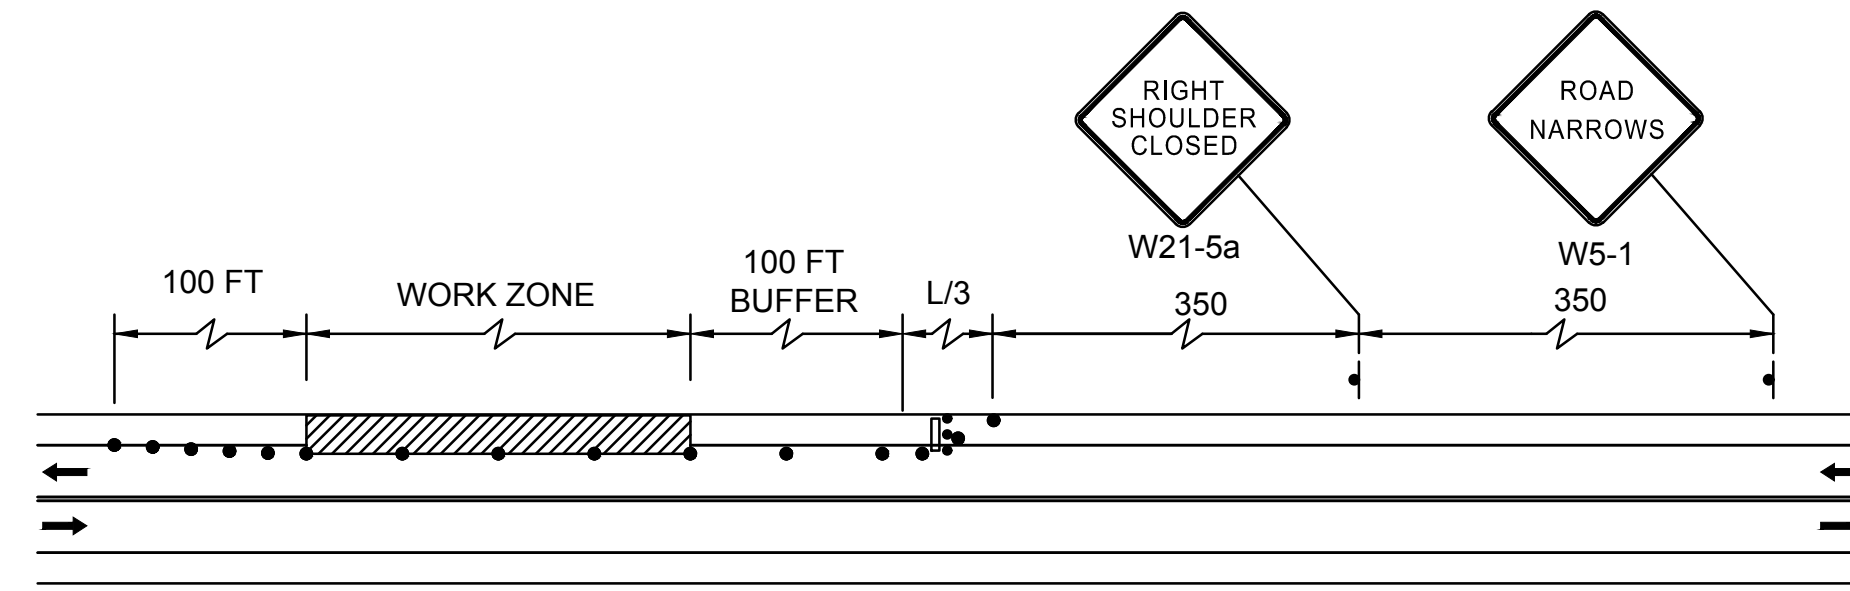


**TWO LANE ROAD SHOULDER CLOSED**

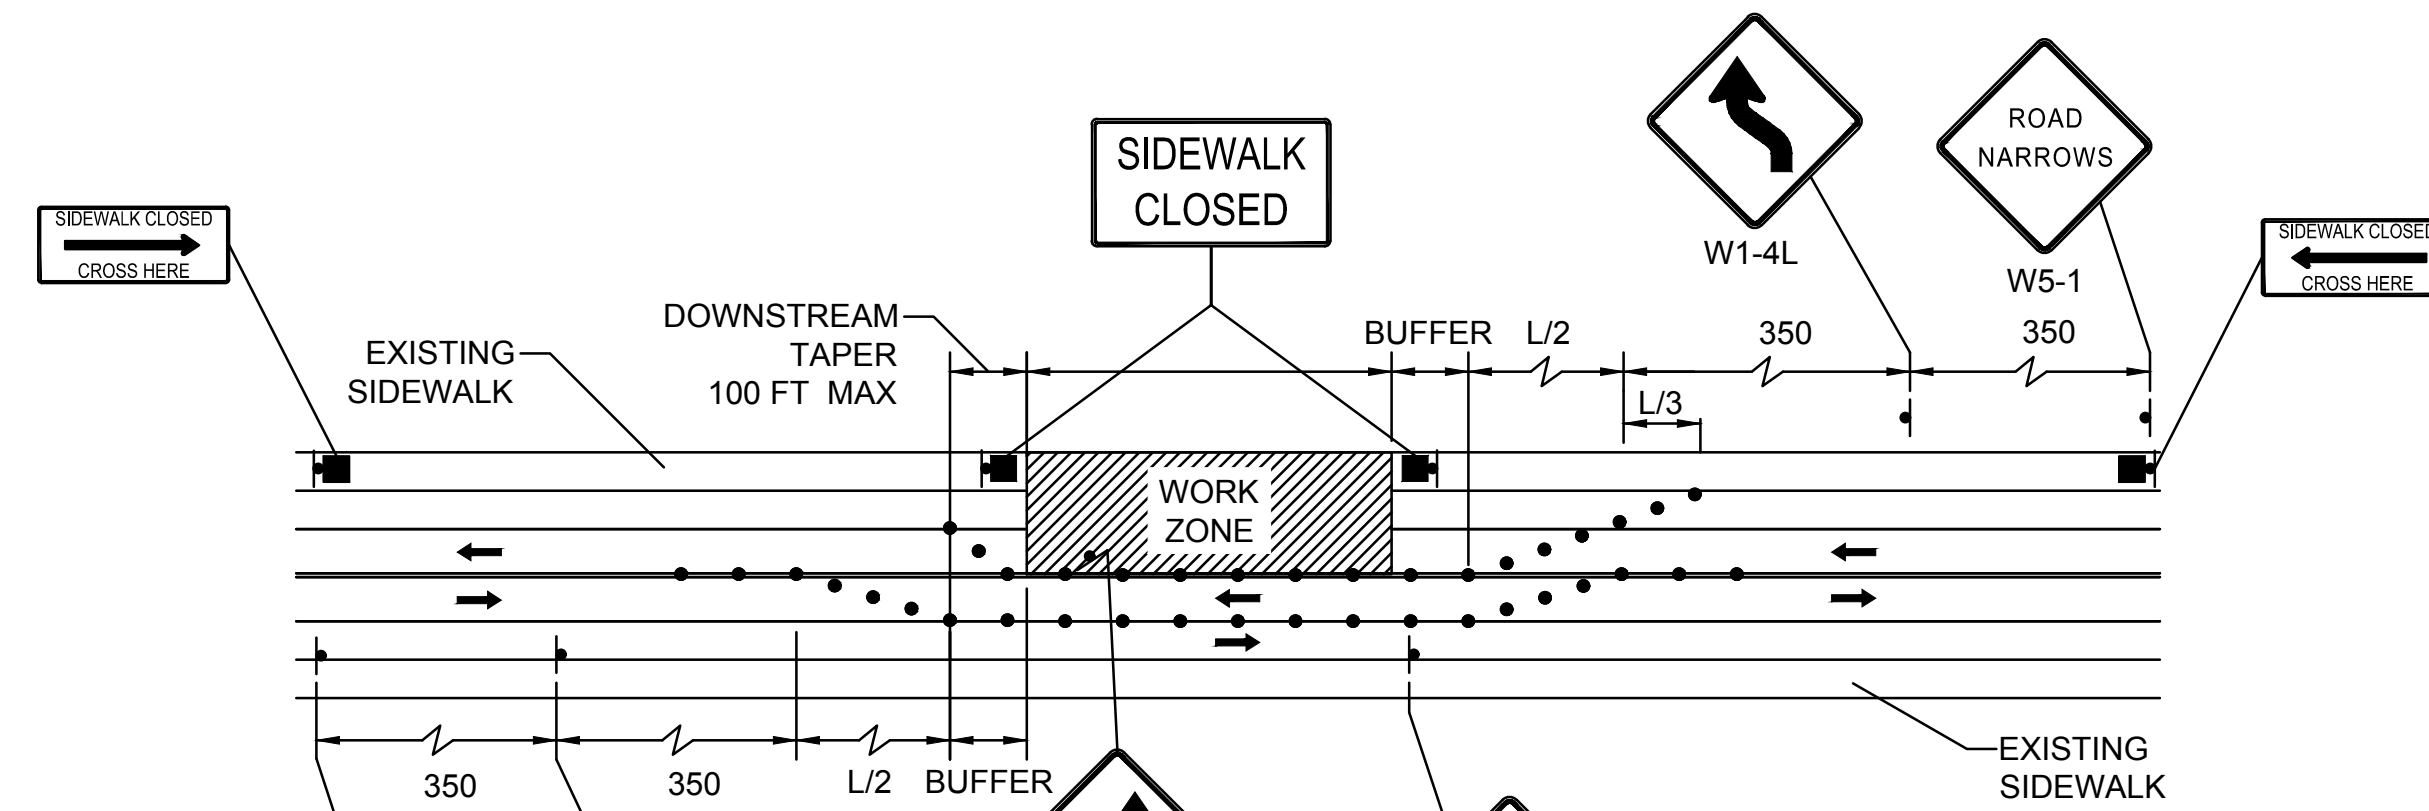

**TWO LANE ROAD SHOULDER AND TRAVEL LANE CLOSED WITH PEDESTRIAN BYPASS**

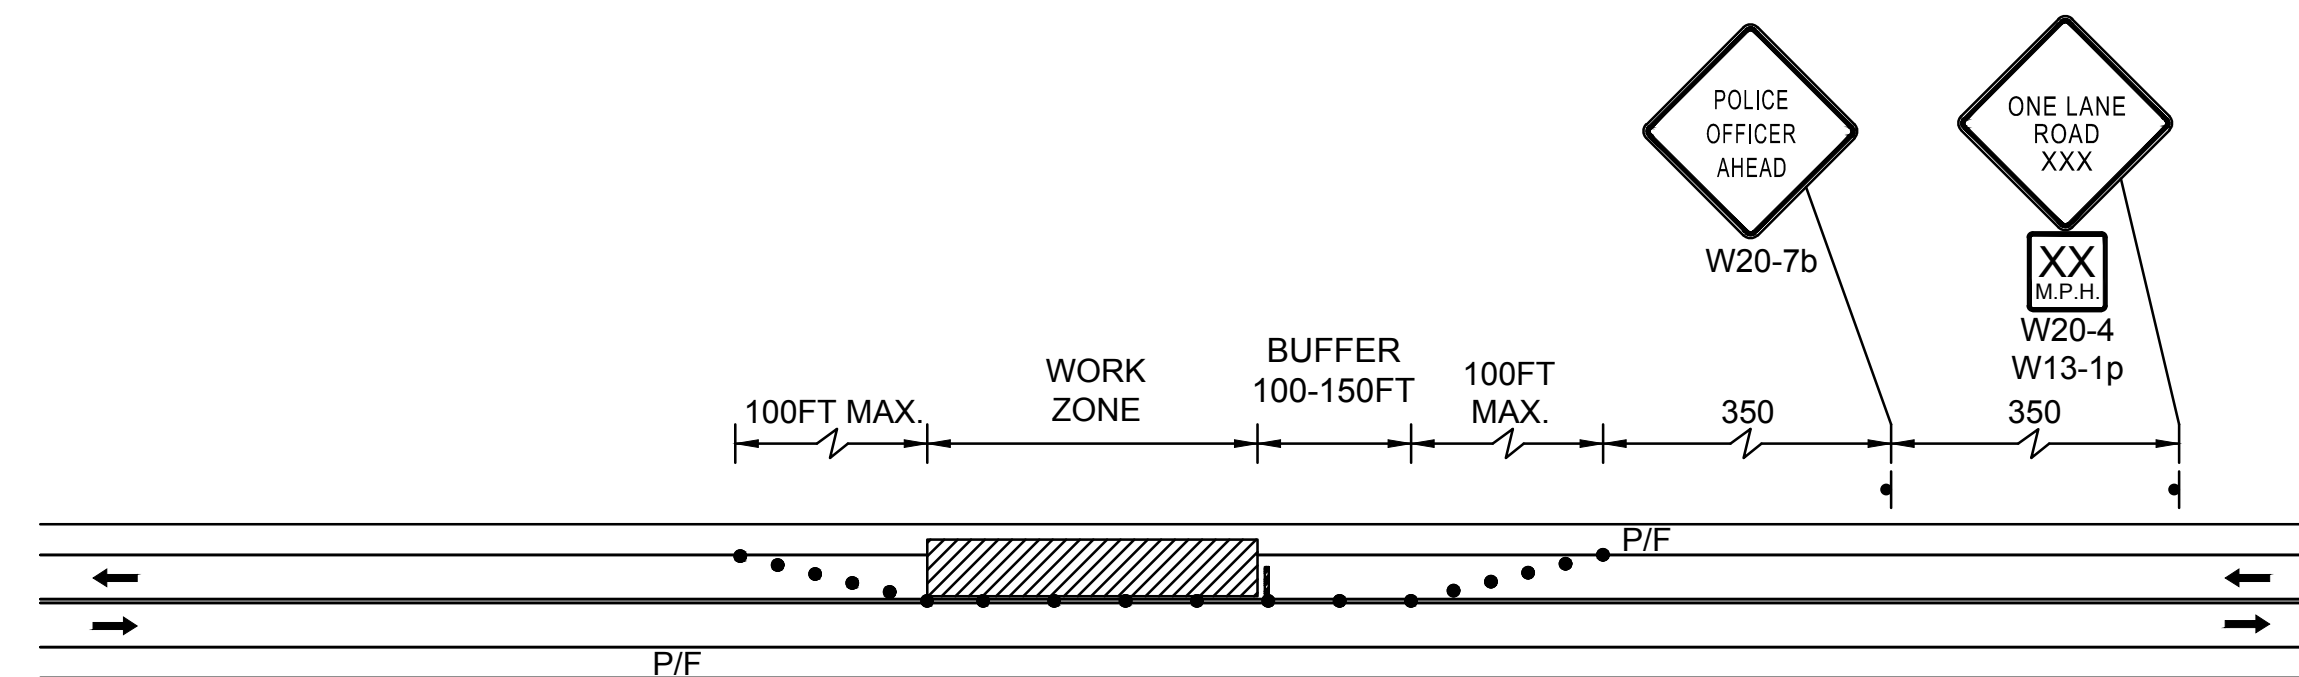

**TWO LANE ROAD ONE LANE ALTERNATING TRAFFIC**

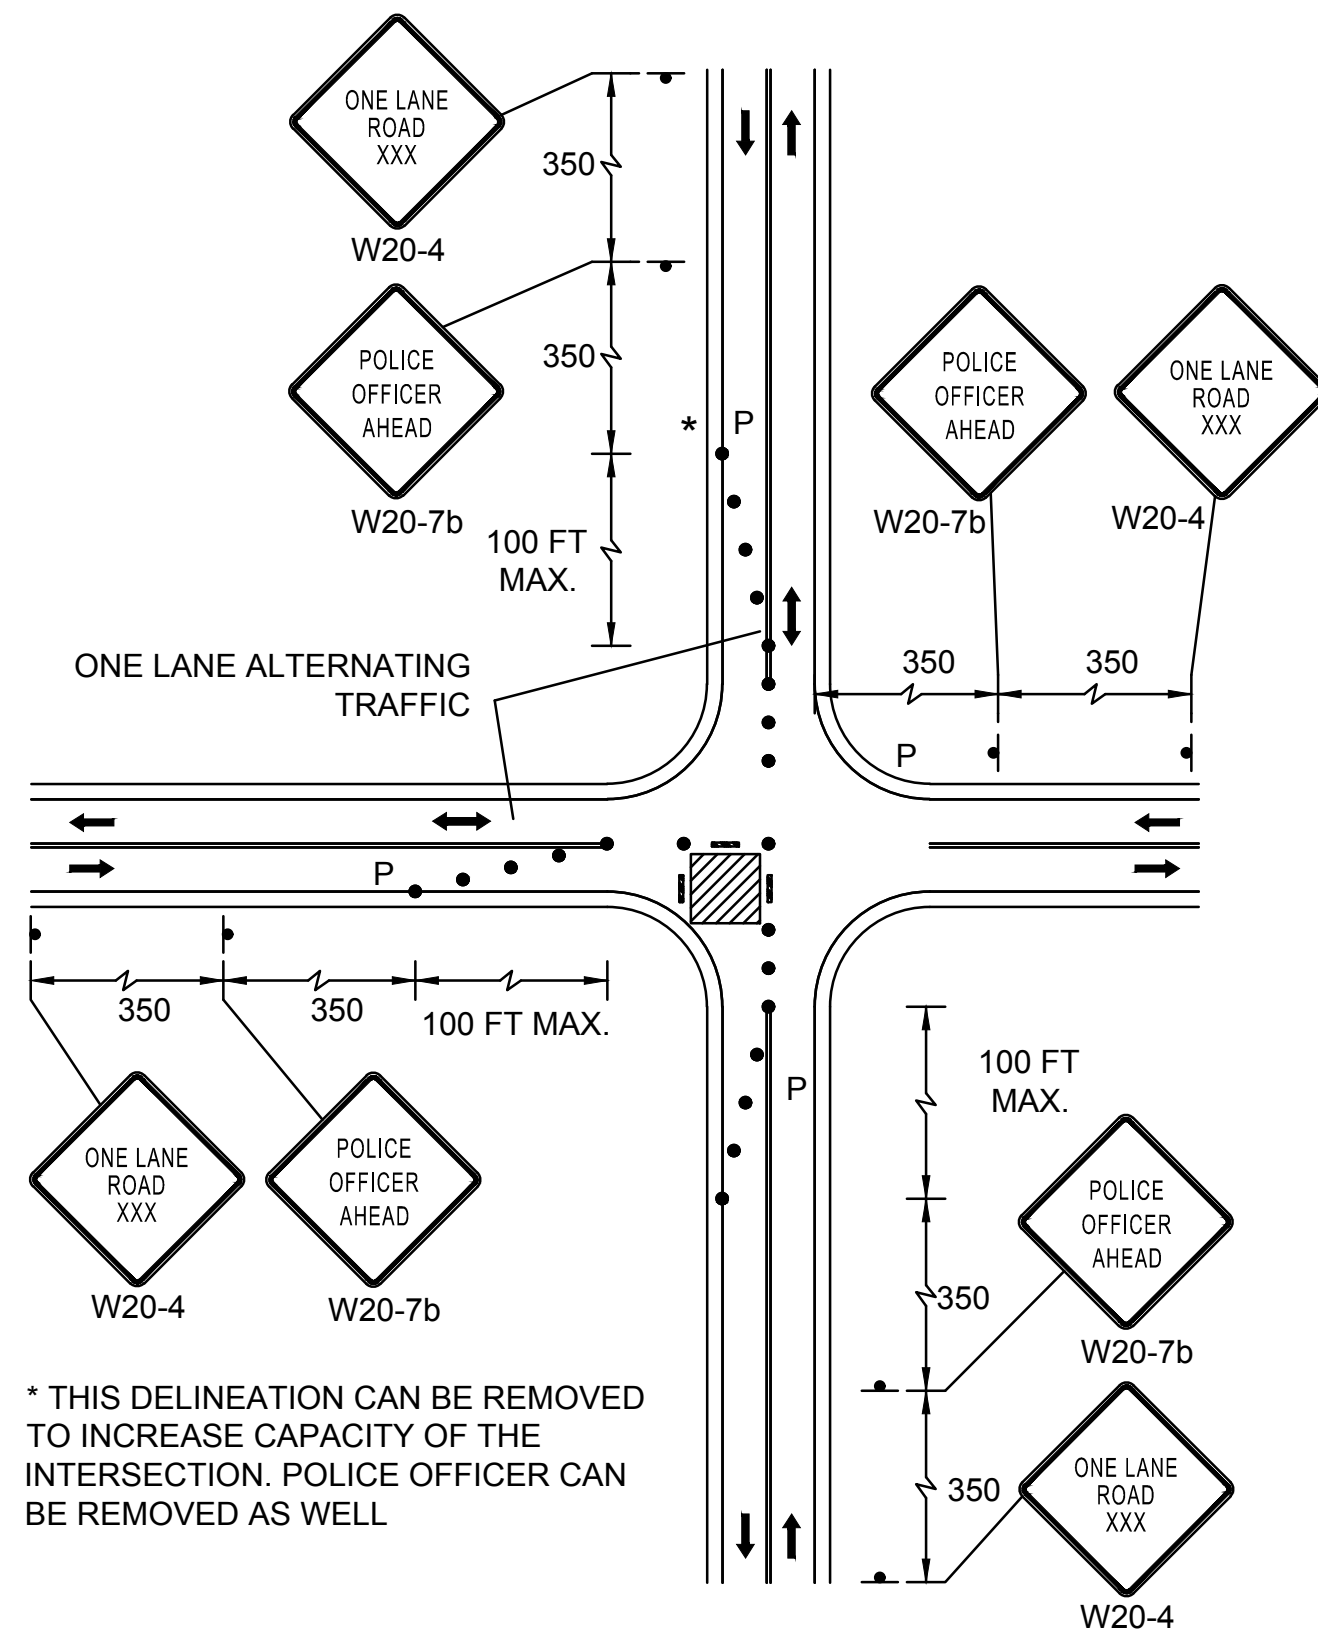

\* THIS DELINEATION CAN BE REMOVED TO INCREASE CAPACITY OF THE INTERSECTION. POLICE OFFICER CAN BE REMOVED AS WELL

**SINGLE LANE APPROACH ONE QUADRANT CLOSURE**



**Stevens Mill Sewer and Sidewalk Replacement Project**

Town of Dudley

Dudley, MA

MARK	DATE	DESCRIPTION
0	04/10/2024	ISSUED FOR BIDDING
	04/2024	
		Details.dwg
		ND/ABS
		MPW
		JPV

**TRAFFIC MANAGEMENT PLAN**

SCALE: NO SCALE