	09 - FOR INFORMATION ONLY - AS BUILTS							
	INDEX OF	DRAWINGS						
SHEET NUMBER	DRAWING TITLE/DESCRIPTION	SHEET NUMBER	DRAWING TITLE/DESCRIPTION					
09.01	FOR INFORMATION ONLY - AS BUILTS INDEX OF DRAWINGS	09.17	0053-0063 - BEAM BRIDGE OVER LINE "S" ON LINE "M" GENERAL PLAN - (BRIDGE NO. 00388)					
09.02	0042-0083 - EAST HARTFORD-GLASTONBURY EXPRESSWAY - TITLE SHEET	09.18	0053-0063 - BEAM BRIDGE OVER LINE "S" ON LINE "M" WEST ABUTMENT & WINGS - (BRIDGE NO. 00388)					
09.03	0042-0083 - EAST HARTFORD-GLASTONBURY EXPRESSWAY - INDEX PLAN	09.19	0053-0063 - BEAM BRIDGE OVER LINE "S" ON LINE "M" EAST ABUTMENT & WINGS - (BRIDGE NO. 00388)					
09.04	0042-0083 - EAST HARTFORD-GLASTONBURY EXPRESSWAY - TYPICAL CROSS SECTIONS	09.20	0053-0063 - BEAM BRIDGE OVER LINE "S" ON LINE "M" STEEL DETAILS - (BRIDGE NO. 00388)					
09.05	0042-0083 - EAST HARTFORD-GLASTONBURY EXPRESSWAY - PLAN	09.21	0053-0063 - BEAM BRIDGE OVER LINE "S" ON LINE "M" SLAB - (BRIDGE NO. 00388)					
09.06	0042-0083 - EAST HARTFORD-GLASTONBURY EXPRESSWAY - PLAN	09.22	0053-0063 - BEAM BRIDGE OVER NEW LONDON TURNPIKE CONNECTION TO ROUTE 17 GENERAL PLAN - (BRIDGE NO. 00870)					
09.07	0042-0083 - EAST HARTFORD-GLASTONBURY EXPRESSWAY - PLAN	09.23	0053-0063 - BEAM BRIDGE OVER NEW LONDON TURNPIKE CONNECTION TO ROUTE 17 NORTH ABUTMENT - (BRIDGE NO. 00870)					
09.08	0042-0083 - EAST HARTFORD-GLASTONBURY EXPRESSWAY - PLAN	09.24	0053-0063 - BEAM BRIDGE OVER NEW LONDON TURNPIKE CONNECTION TO ROUTE 17 SOUTH ABUTMENT - (BRIDGE NO. 00870)					
09.09	0042-0083 - 10 X 8 REINF CONC CULVERT HUBBARD BROOK STA. 202+82	09.25	0053-0063 - BEAM BRIDGE OVER NEW LONDON TURNPIKE CONNECTION TO ROUTE 17 WINGS - (BRIDGE NO. 00870)					
09.10	0053-0063 - EAST HARTFORD-GLASTONBURY EXPRESSWAY - TITLE SHEET	09.26	0053-0063 - BEAM BRIDGE OVER NEW LONDON TURNPIKE CONNECTION TO ROUTE 17 SLAB-STEEL & RAILING DETAILS - (BRIDGE NO. 00870)					
09.11	0053-0063 - EAST HARTFORD-GLASTONBURY EXPRESSWAY - PLAN SHEET	09.27	0053-0160 - NEW LONDON TURNPIKE ISLAND MODIFICATION - TITLE SHEET					
09.12	0053-0063 - BEAM BRIDGE OVER NEW LONDON TURNPIKE CONN. TO ROUTE 2 LINE "S" GENERAL PLAN - (BRIDGE NO. 00389)	09.28	0053-0160 - NEW LONDON TURNPIKE ISLAND MODIFICATION - TYPICAL ROADWAY DETAILS					
09.13	0053-0063 - BEAM BRIDGE OVER NEW LONDON TURNPIKE CONN. TO ROUTE 2 LINE "S" NORTH ABUT & WINGS - (BRIDGE NO. 00389)	09.29	0053-0160 - NEW LONDON TURNPIKE ISLAND MODIFICATION - PLAN & PROFILE					
09.14	0053-0063 - BEAM BRIDGE OVER NEW LONDON TURNPIKE CONN. TO ROUTE 2 LINE "S" SOUTH ABUT & WINGS - (BRIDGE NO. 00389)							
09.15	0053-0063 - BEAM BRIDGE OVER NEW LONDON TURNPIKE CONN. TO ROUTE 2 LINE "S" STEEL DETAILS - (BRIDGE NO. 00389)							
09.16	0053-0063 - BEAM BRIDGE OVER NEW LONDON TURNPIKE CONN. TO ROUTE 2 LINE "S" SLAB SHEET - (BRIDGE NO. 00389)							

WSP USA INC 500 WINDING BROOK DR GLASTONBURY, CT 06033

CONNECTICUT DEPARTMENT OF TRANSPORTATION


REMOVAL OF BR. NOS. 00388 & 00389, DECK
REPLACEMENT ON BR. NO. 00870, AND MODIFICATIONS
TO ROUTE 17 & NEW LONDON TURNPIKE

GLASTONBURY

FOR INFORMATION ONLY AS BUILTS INDEX OF
DRAWINGS

PROJECT NO.:

DRAWING NO.:
INX-01 0053-0189 SHEET NO.:
09.01

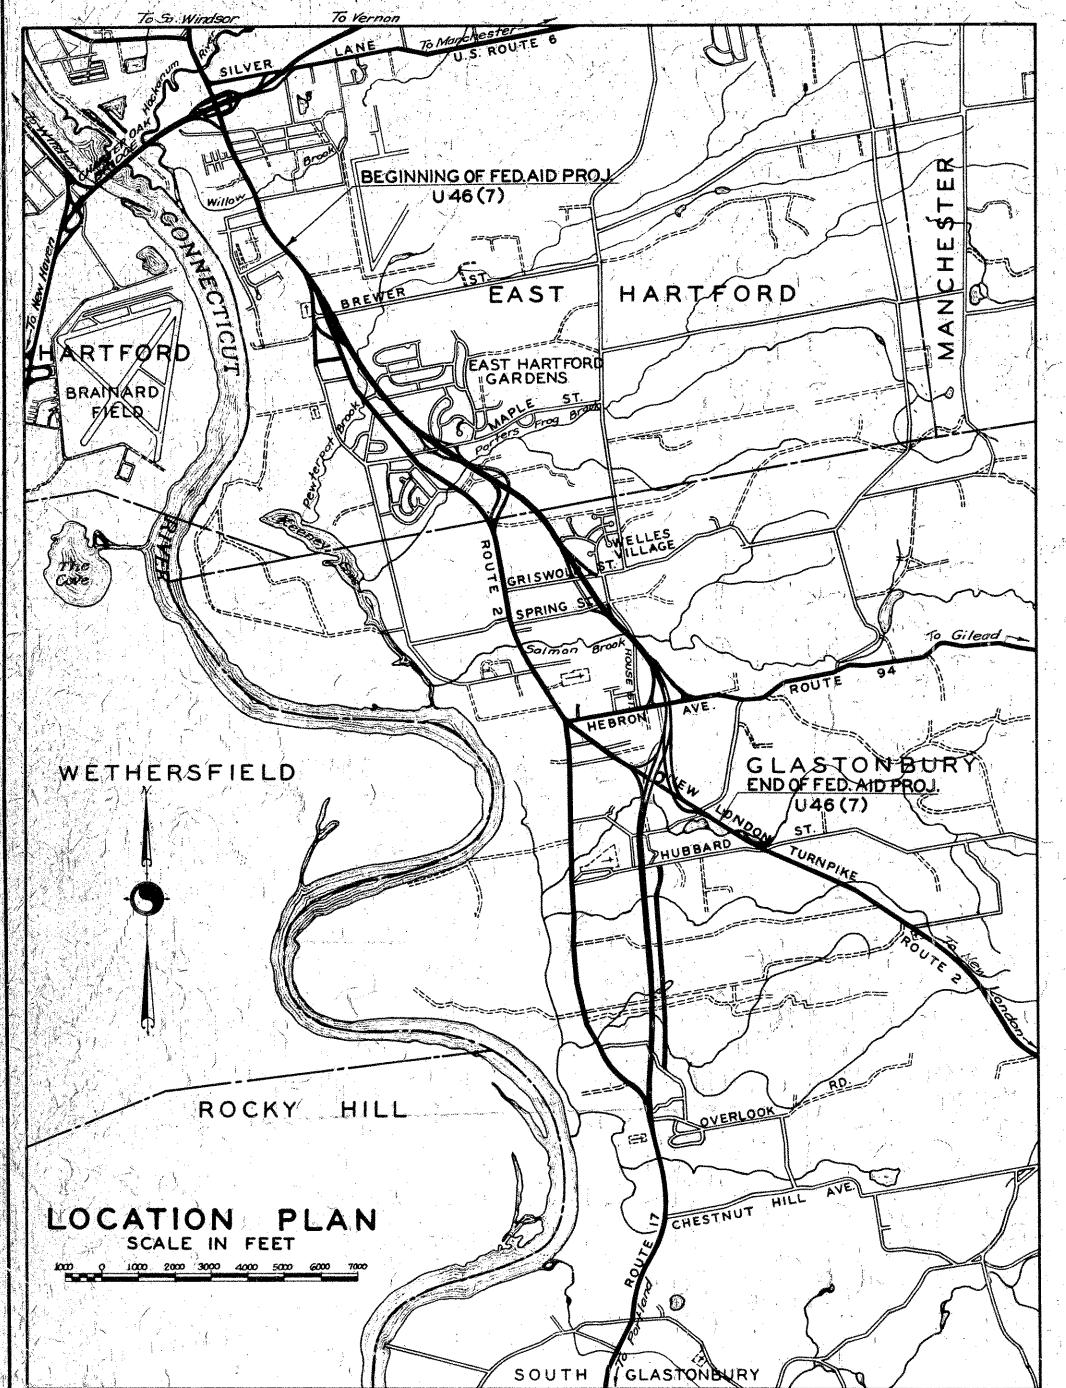

STAND		ENTIONS
Hedge	Picket Fence	Present Culvert
Guide Hoil	Board Fence	Proposed Culvert
Stored whether	Retaining Wall	Movo.
Stone Woll	Open Ditch	Born
Concrete Walk	Open Citch	Buildings
WOIR Tor Grove!	Telegroph, Tele- phone or Elec-	Swomp
COMM. Co.	fric Light Poles	Gos Rendern Pump Stone
Present Trocks		Highway Mon.
Toking Line	Ledge or Moch	CH.D. Marker
Property Line	Pole M.H	0
Town Line		Proposed C.B.

Present

FED. AID FRINTING SYSTEM ASSUMED DESMIN SPEED - SUN ANTICION A. D.T. 1970 - 6430-17800

CONNECTICUT STATE HIGHWAY DEPARTMENT

PLAN FOR CONSTRUCTION

A SECTION OF THE EAST HARTFORD-GLASTONBURY EXPRESSWAY IN THE TOWNS OF

EAST HARTFORD & GLASTONBURY

FROM STA. 10-00 TO STA, 216+13.59 LINE "S" LENGTH 19.696.77 FT.


(PLAN 1 IN = 40 FT. SCALES PROFILE HOR, 1 IN. - 40 FT. VERT. 1 IN. - 4 FT. CROSS SECTIONS 1 IN. - 10 FT.


NOTE: All Elevations For This Project Based Upon U.S.C. & G. DATUM

FEDERAL AID PROJECT NO. U 46 (7)

EXPRESSWAY AND RAMPS TO BE MAINTAINED BY THE STATE INTERSECTING TOWN ROADS TO BE MAINTAINED BY THE TOWN

	· LIST OF DRAWINGS ·
SHEET Nº	
/	Title Sheet
2-6	Index Plans and Profiles
7-9	Detailed Estimate Sheets
10-13	Typical Cross Sections
14-60	Plans and Profiles
6/	Box Culvert Sta. 45 40 North Bound Center Line
62	Box Culvert Sta 30 2 02
63-92	Cross Sections - Mane Line Sta 10+0 to 77+0 , Including Lines "V" & "Y"
93-98	" Line B-B"
99-100	" Line Hart"
101-103	No was care "Q"
104-107	"Line IR"
108-163	" " Stall 8+0 to 216+13 59, Including Lines"U"M"L"T" "F"W"
r	STANDARDS
~ 217C	Wire Rope Railing -3 Cable
221E	Endwalls , Repundendrain, Outlets and Perforated Pipe
22/F	Standard Endwalls
222A	Curbs, Concrete Steps, Concrete Sidewalks, Paved Ditch
223	Manhole
22.6	ACCM Drop Intel, and Elbows
2208	Type "C" Cafeh Bas
2288	Type CG " and Drog Inlet
SSEC	
2200	Type "C.L." " Frames and Graies (to-eaith Basins and Drop Inlets
···	
241G	Paring Derakt
242C	Lood Transfer Unit for Transverse Toint (Type "O")
2420	CType "E"
2425	CType 'A')
249	Fabric Reinforcential (13'Sheet Length)
2498	
7/2/	Barringles, Service Bridges, Tree Well & Rook Prot., Concrete Ramps
714	Togerania Commission (See Monthle Parks)
7 6	Temporo Novelo Since

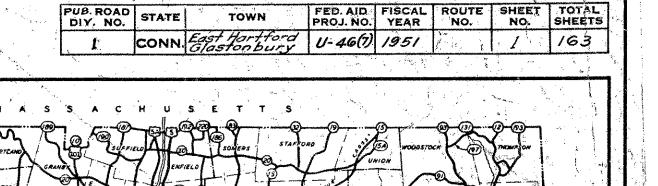


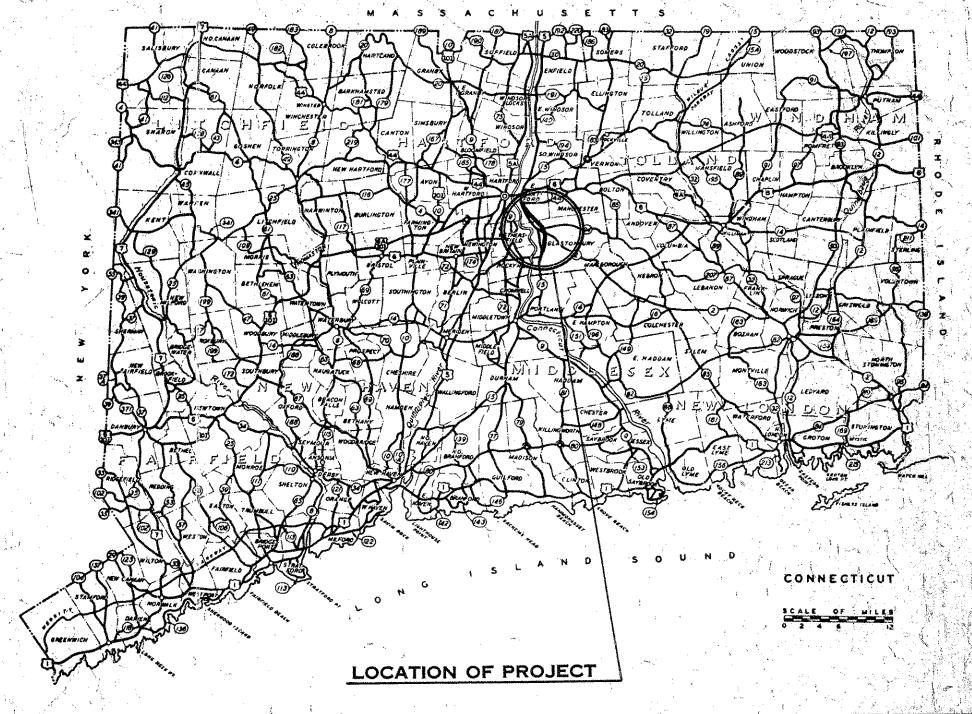


TOWN NO. PROJECT NO. 83

Construction Storted Sept. 4,1951 Construction Completed Dec. 31,1952 Plans Revised by D.L. Ayrton Feb. 1,1955 Plans Checked by J.M. Mc Carthy Mar. 15, 1955 Property Check by W. Tolletson Mar. 11, 1959

14.00			ULATIO			NGT	
SECTION	LINE	57A. 7	to 57A	LENGTH OF LINE	LENGTH	WIOTH	TYPE OF PAVEMENT
·	No: Bound	10 + 00	- 50 + 03.99	4005:15	1	24'	Reinf. Concrete
	So. Bound	10 + 00	- 49+55.21	30/5.93	3510.54	24'	
	Main Line	49 + 56.03	- 77+00 ·	268263	,2682.83	2@24	
	B-B	29 + 15.01	- 43+96.10	1461.09		24"	
1 1	H-H	10 + 25	- 17+73	748.00		24	
	୍ଦ	8 + 39	- /3 + 20	48100		14	
	R	11 + 05	- 17+05	600.00	·	14	ii ii
	, V ,	12+05	<u> </u>	512.00		14	The state of the s
1	Y	11+85	- V9+57	772.00		14	n n
I	So. Bound A	30 + 40	- 30+00	760.00	.380.00	24	Reinf. Concrete
3							
1	Main Line	77+00	- 178+00	9835.30	9835.30	20 24'	Reinf. Concrete
-	H	0+16	- 9-23	1907.00		14.	
	I	0 +12	-, 5+64	552.00		14	" 3 5 7
	6	125+30	- (32+35	705.00		14':	n n
	9	124+15	- /34+06	991.00	į	14'	
1	G	050	- 4+77	527.00		. 14"	
	/ /= ,	0 + 00	- 7+75	775.00		14'	" " " " " " " " " " " " " " " " " " "
	K	7+40	- 18+60	1120.00		14!	" "
1	7	9 + 60	- 20+60	1100.00		14'	" "
	N	178 ±00	- 206+45	2845.12	3288.10	24'	Reinf Concrete
	S	178+00	- 2/6+/3.59	3731.09		24'	11 162
ACCUPATION OF THE PARTY OF THE	X	5+76.60	- 10+70	493.40		14'	" /" /"
IX.	M	188+99.87	<i>− 205+90 🕏</i>	1682.02		24'	, ,
	U	187+50	- 205+00 B	1816.39		24'	11 /1
7	7.7	2+00	- 11+35	935.00		14'	M / 10 %
	W	7+35	- 15+00	765.00		14'	" "
	4	10+90	- 19+10	820.00		14'	* * * * * * * * * * * * * * * * * * * *
***		1 June					
 (A	6 + 00	- 16+42	1042.00	1390.07	20'	Reinfi Concrete
Y	B	11+00	- 29+7/	1738.14	1,330.07	20'	" " " " " " " " " " " " " " " " " " " "
		<i>y</i>					
The second secon				Total	19,696.77		

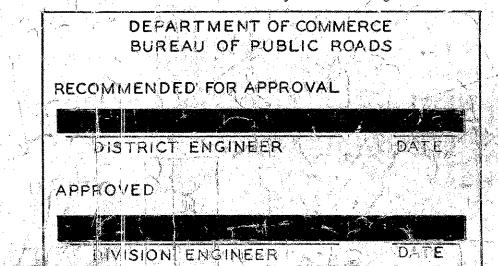



ENGINEER OF SURVEY & PLANS APPROVED JUNE 7 1 DIRECTOR OF TRAFFIC-PLANNING- DESIG

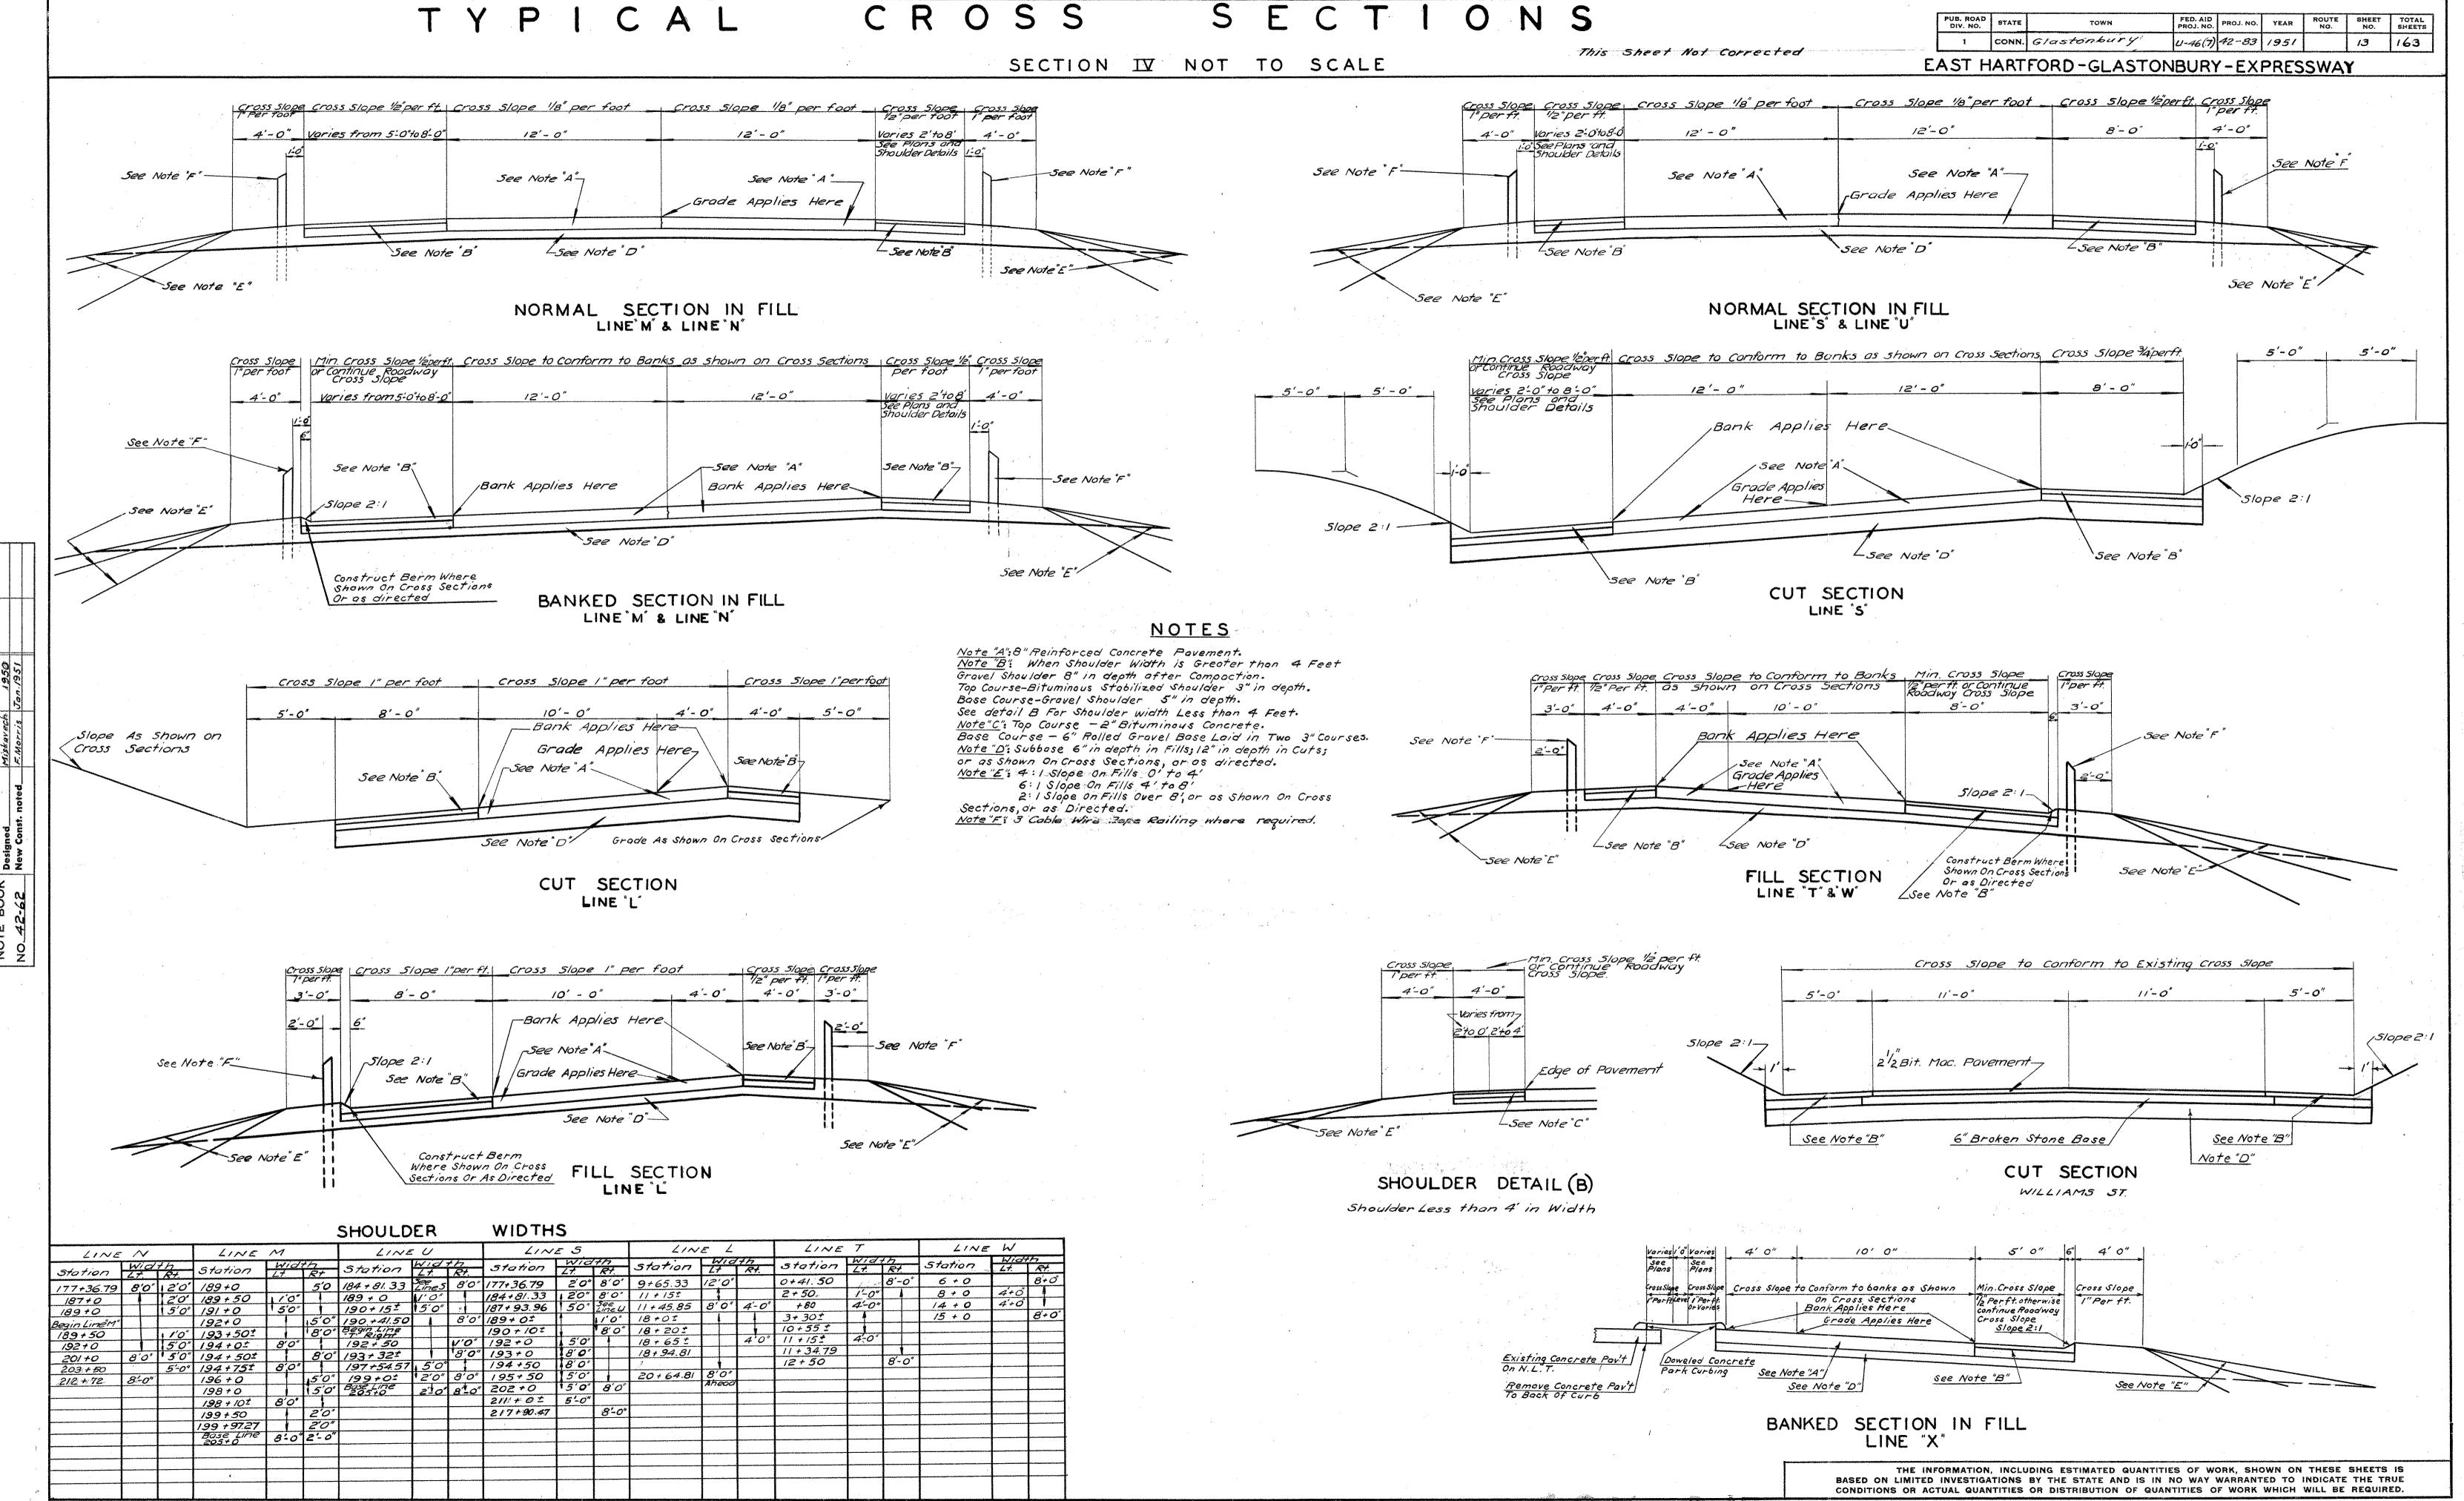



83


FORM NO. ENG. 11 ED. 7-46

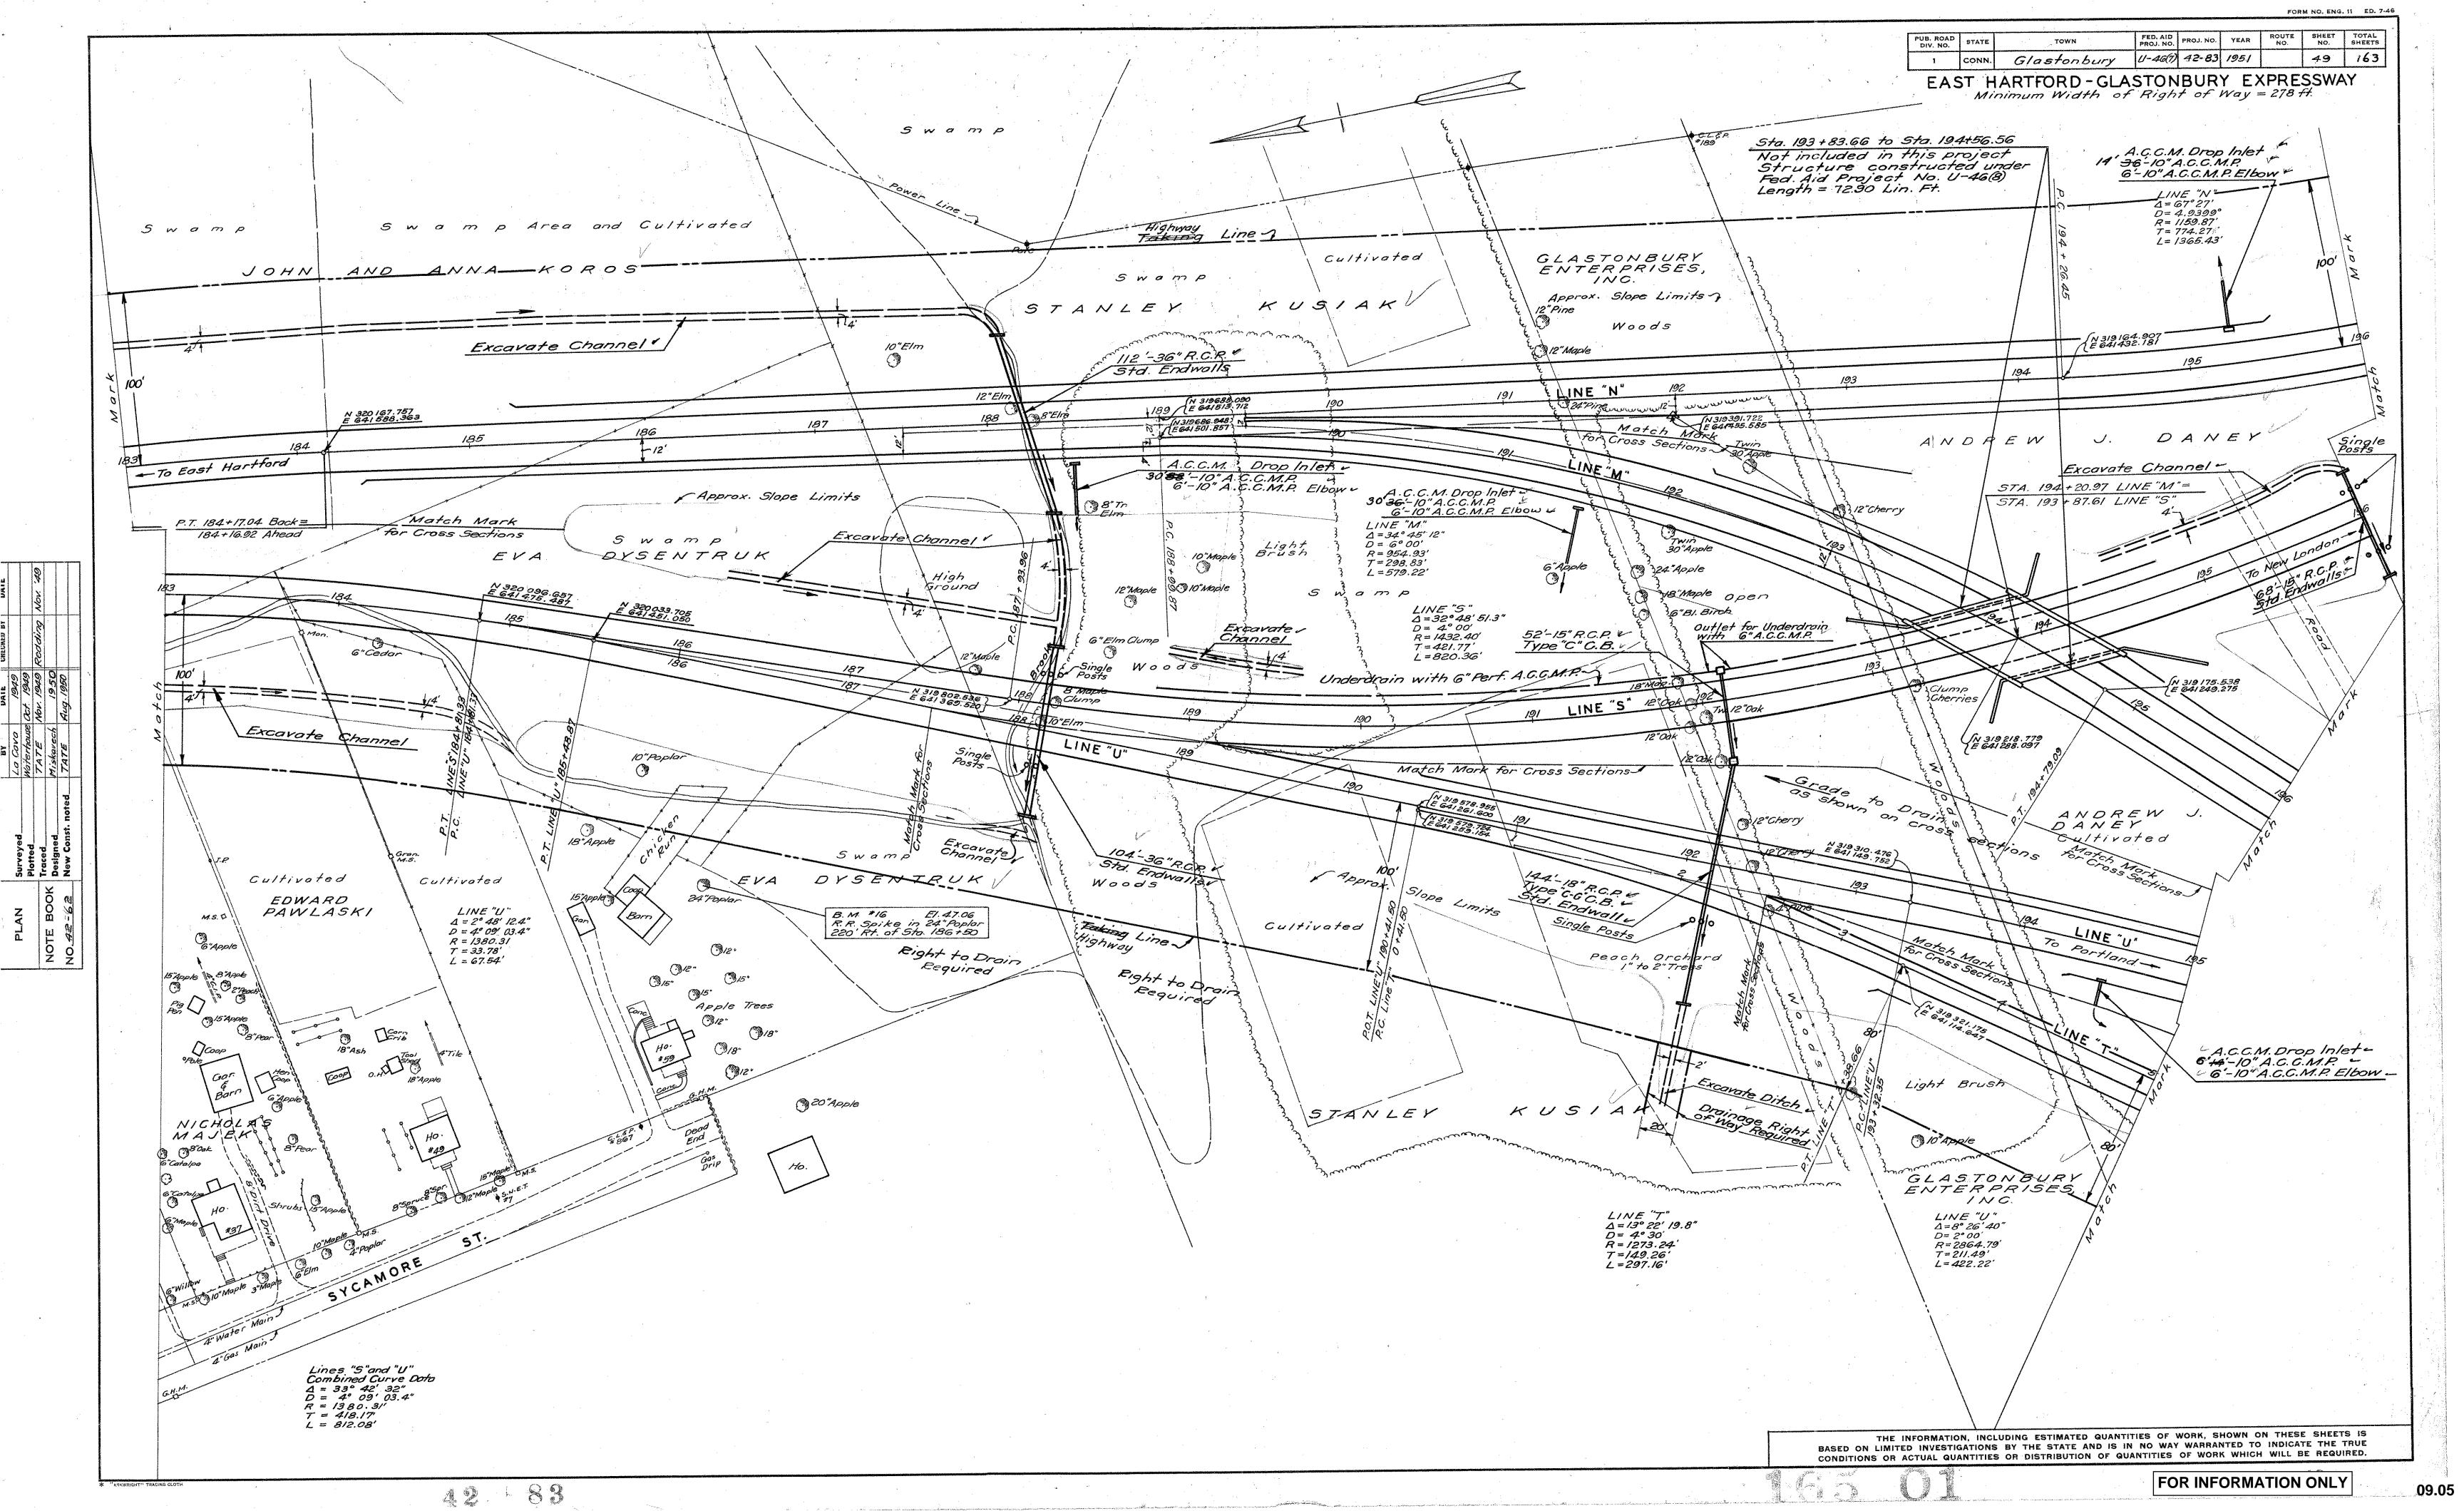


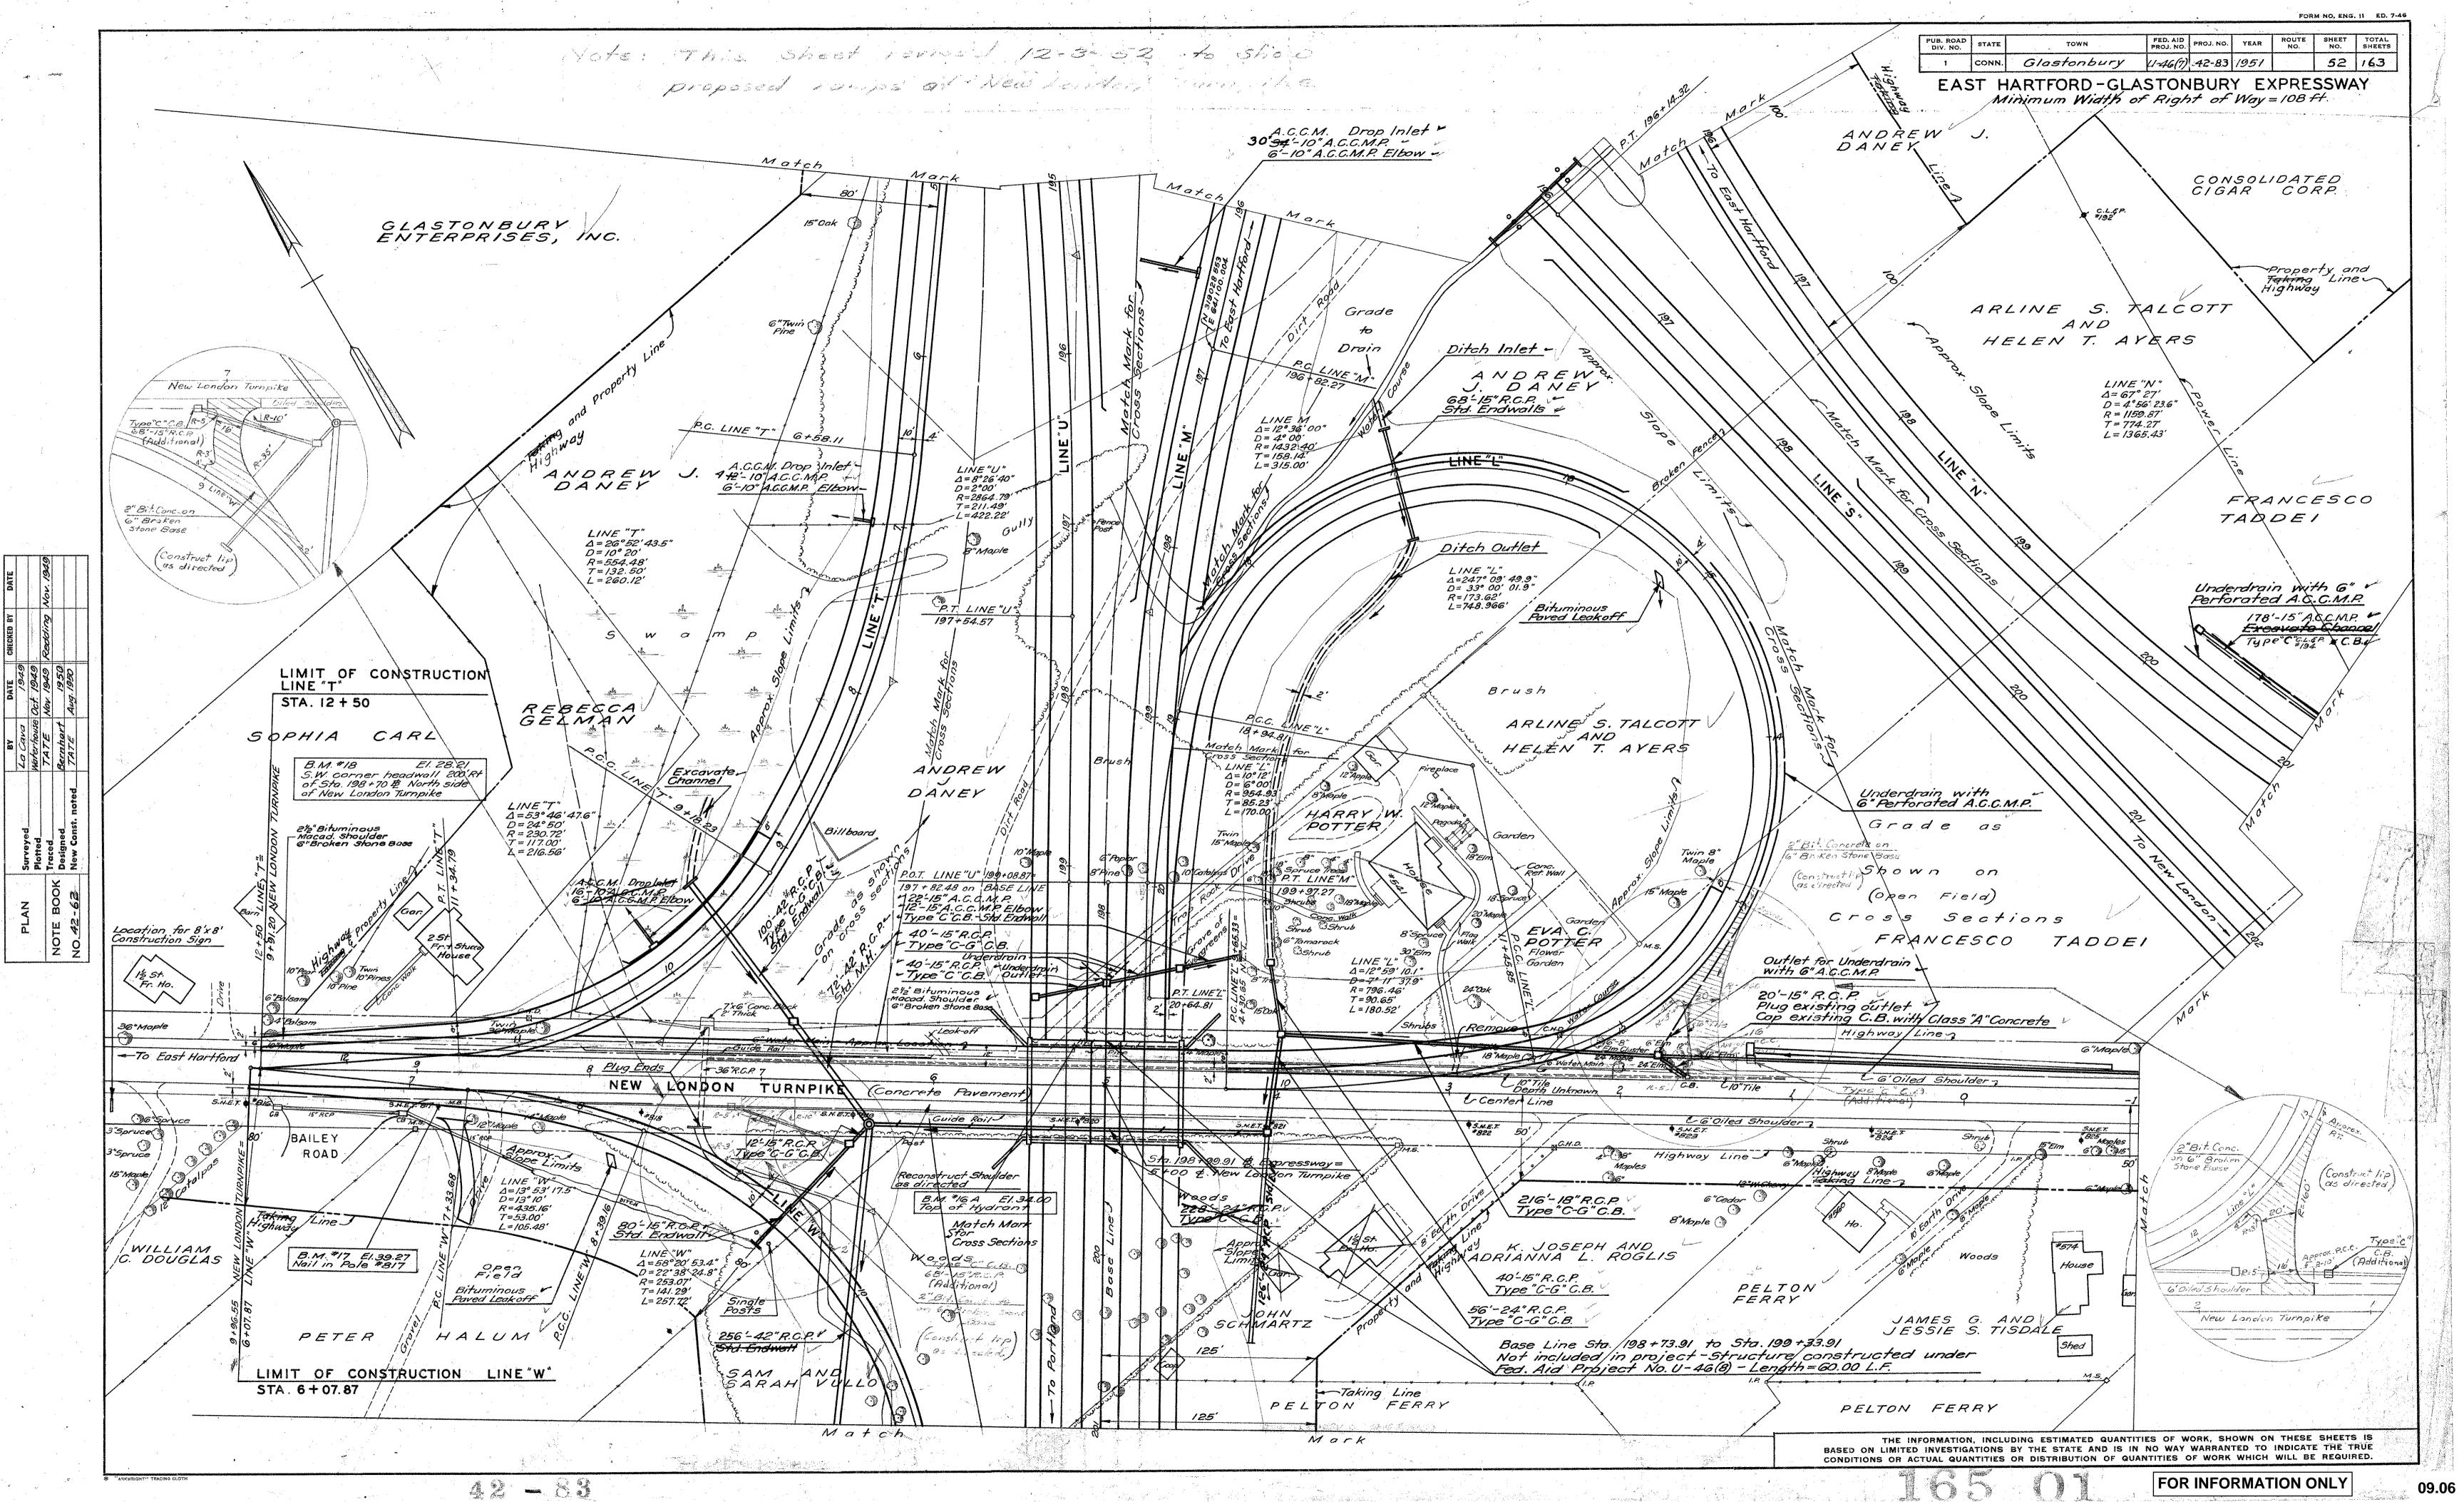

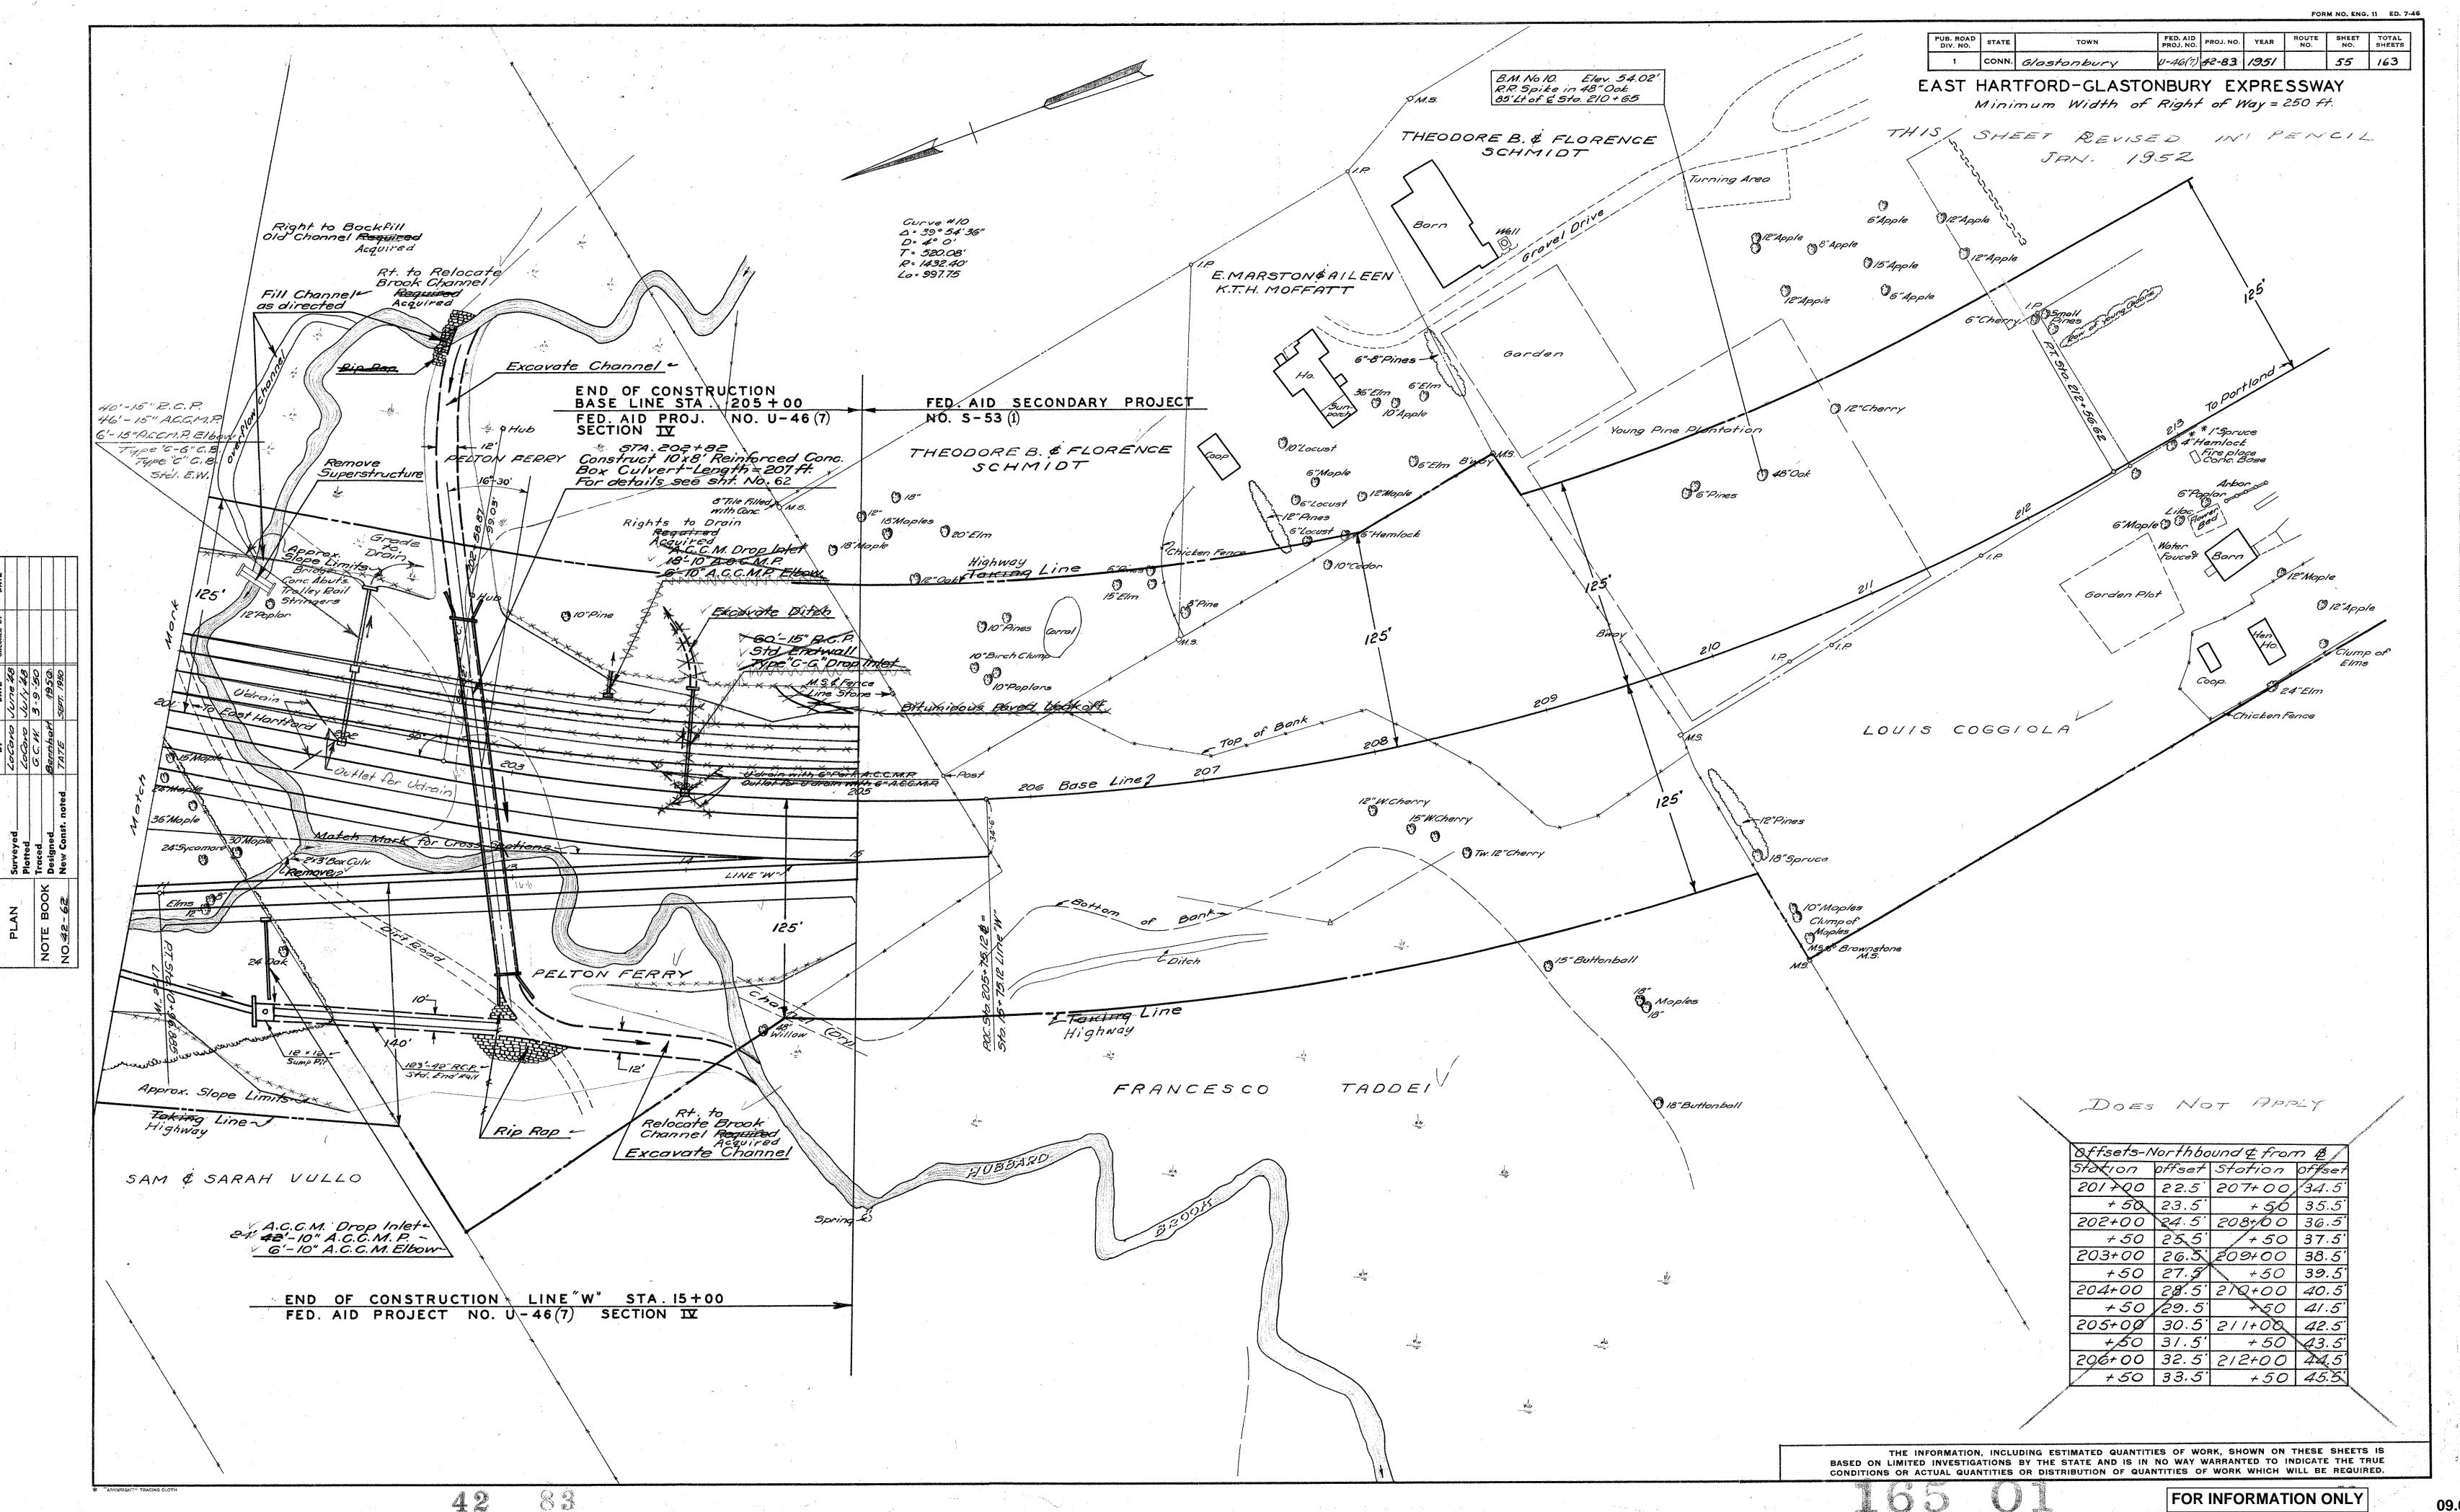

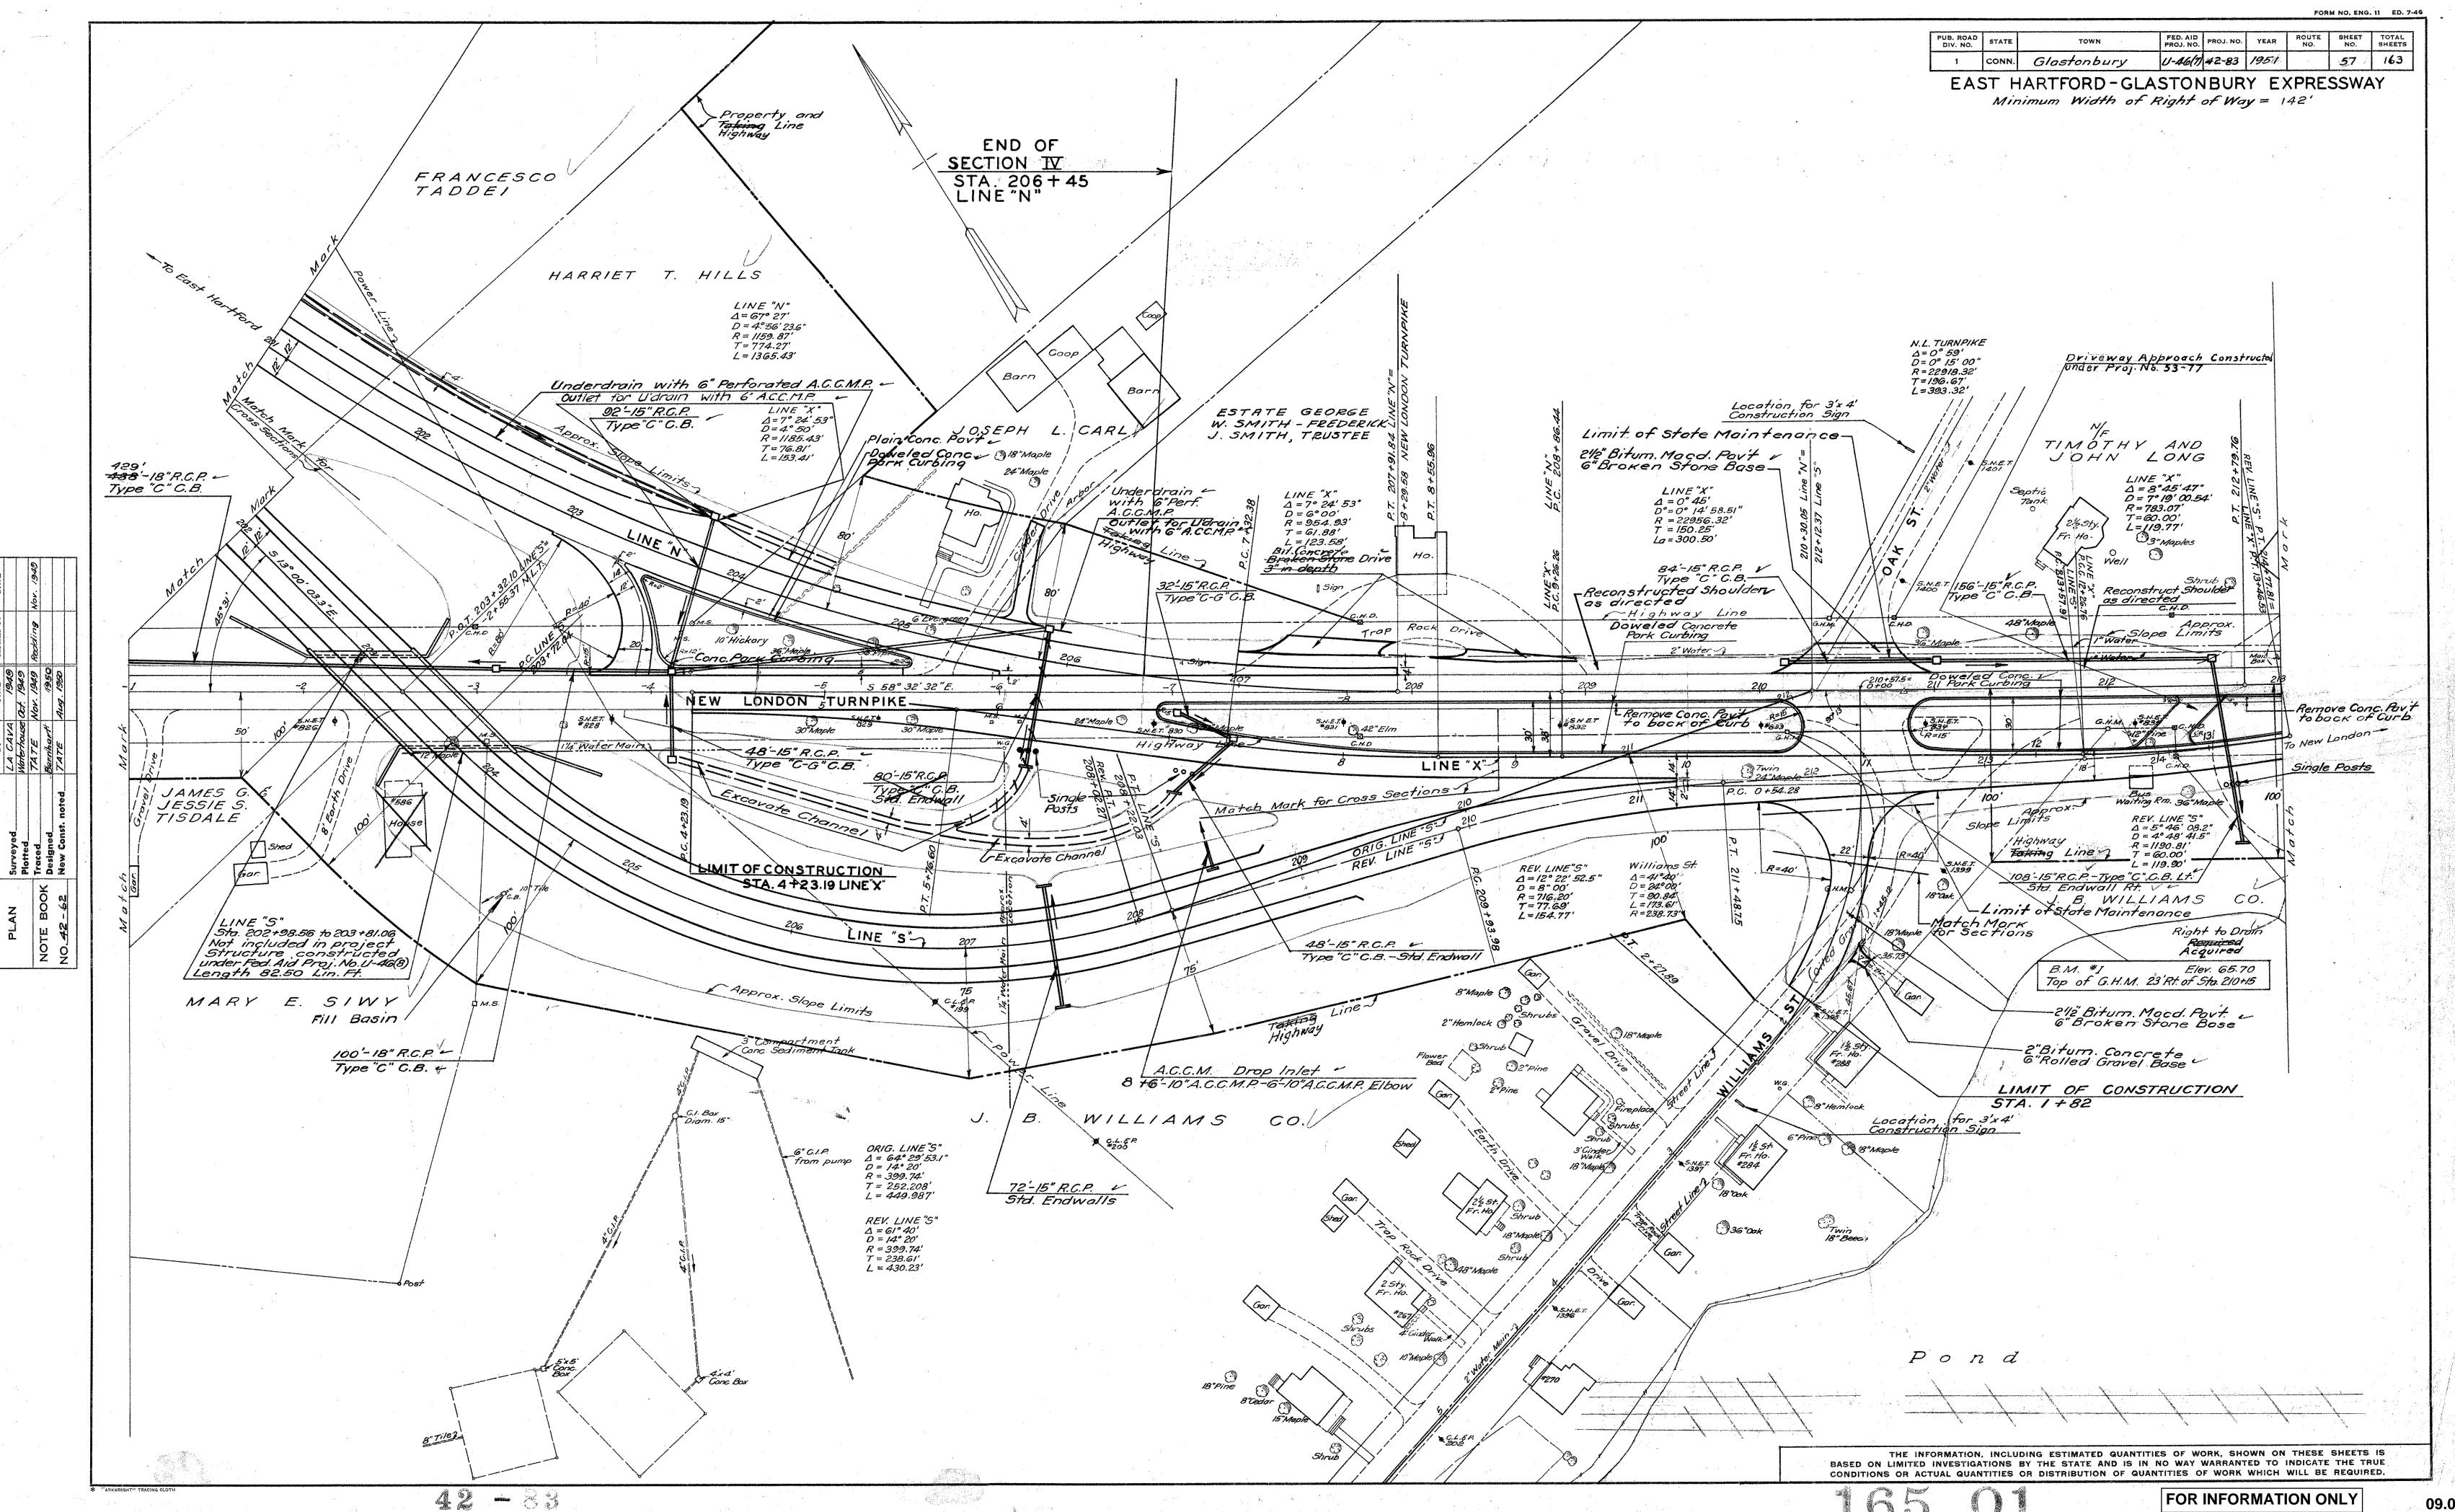

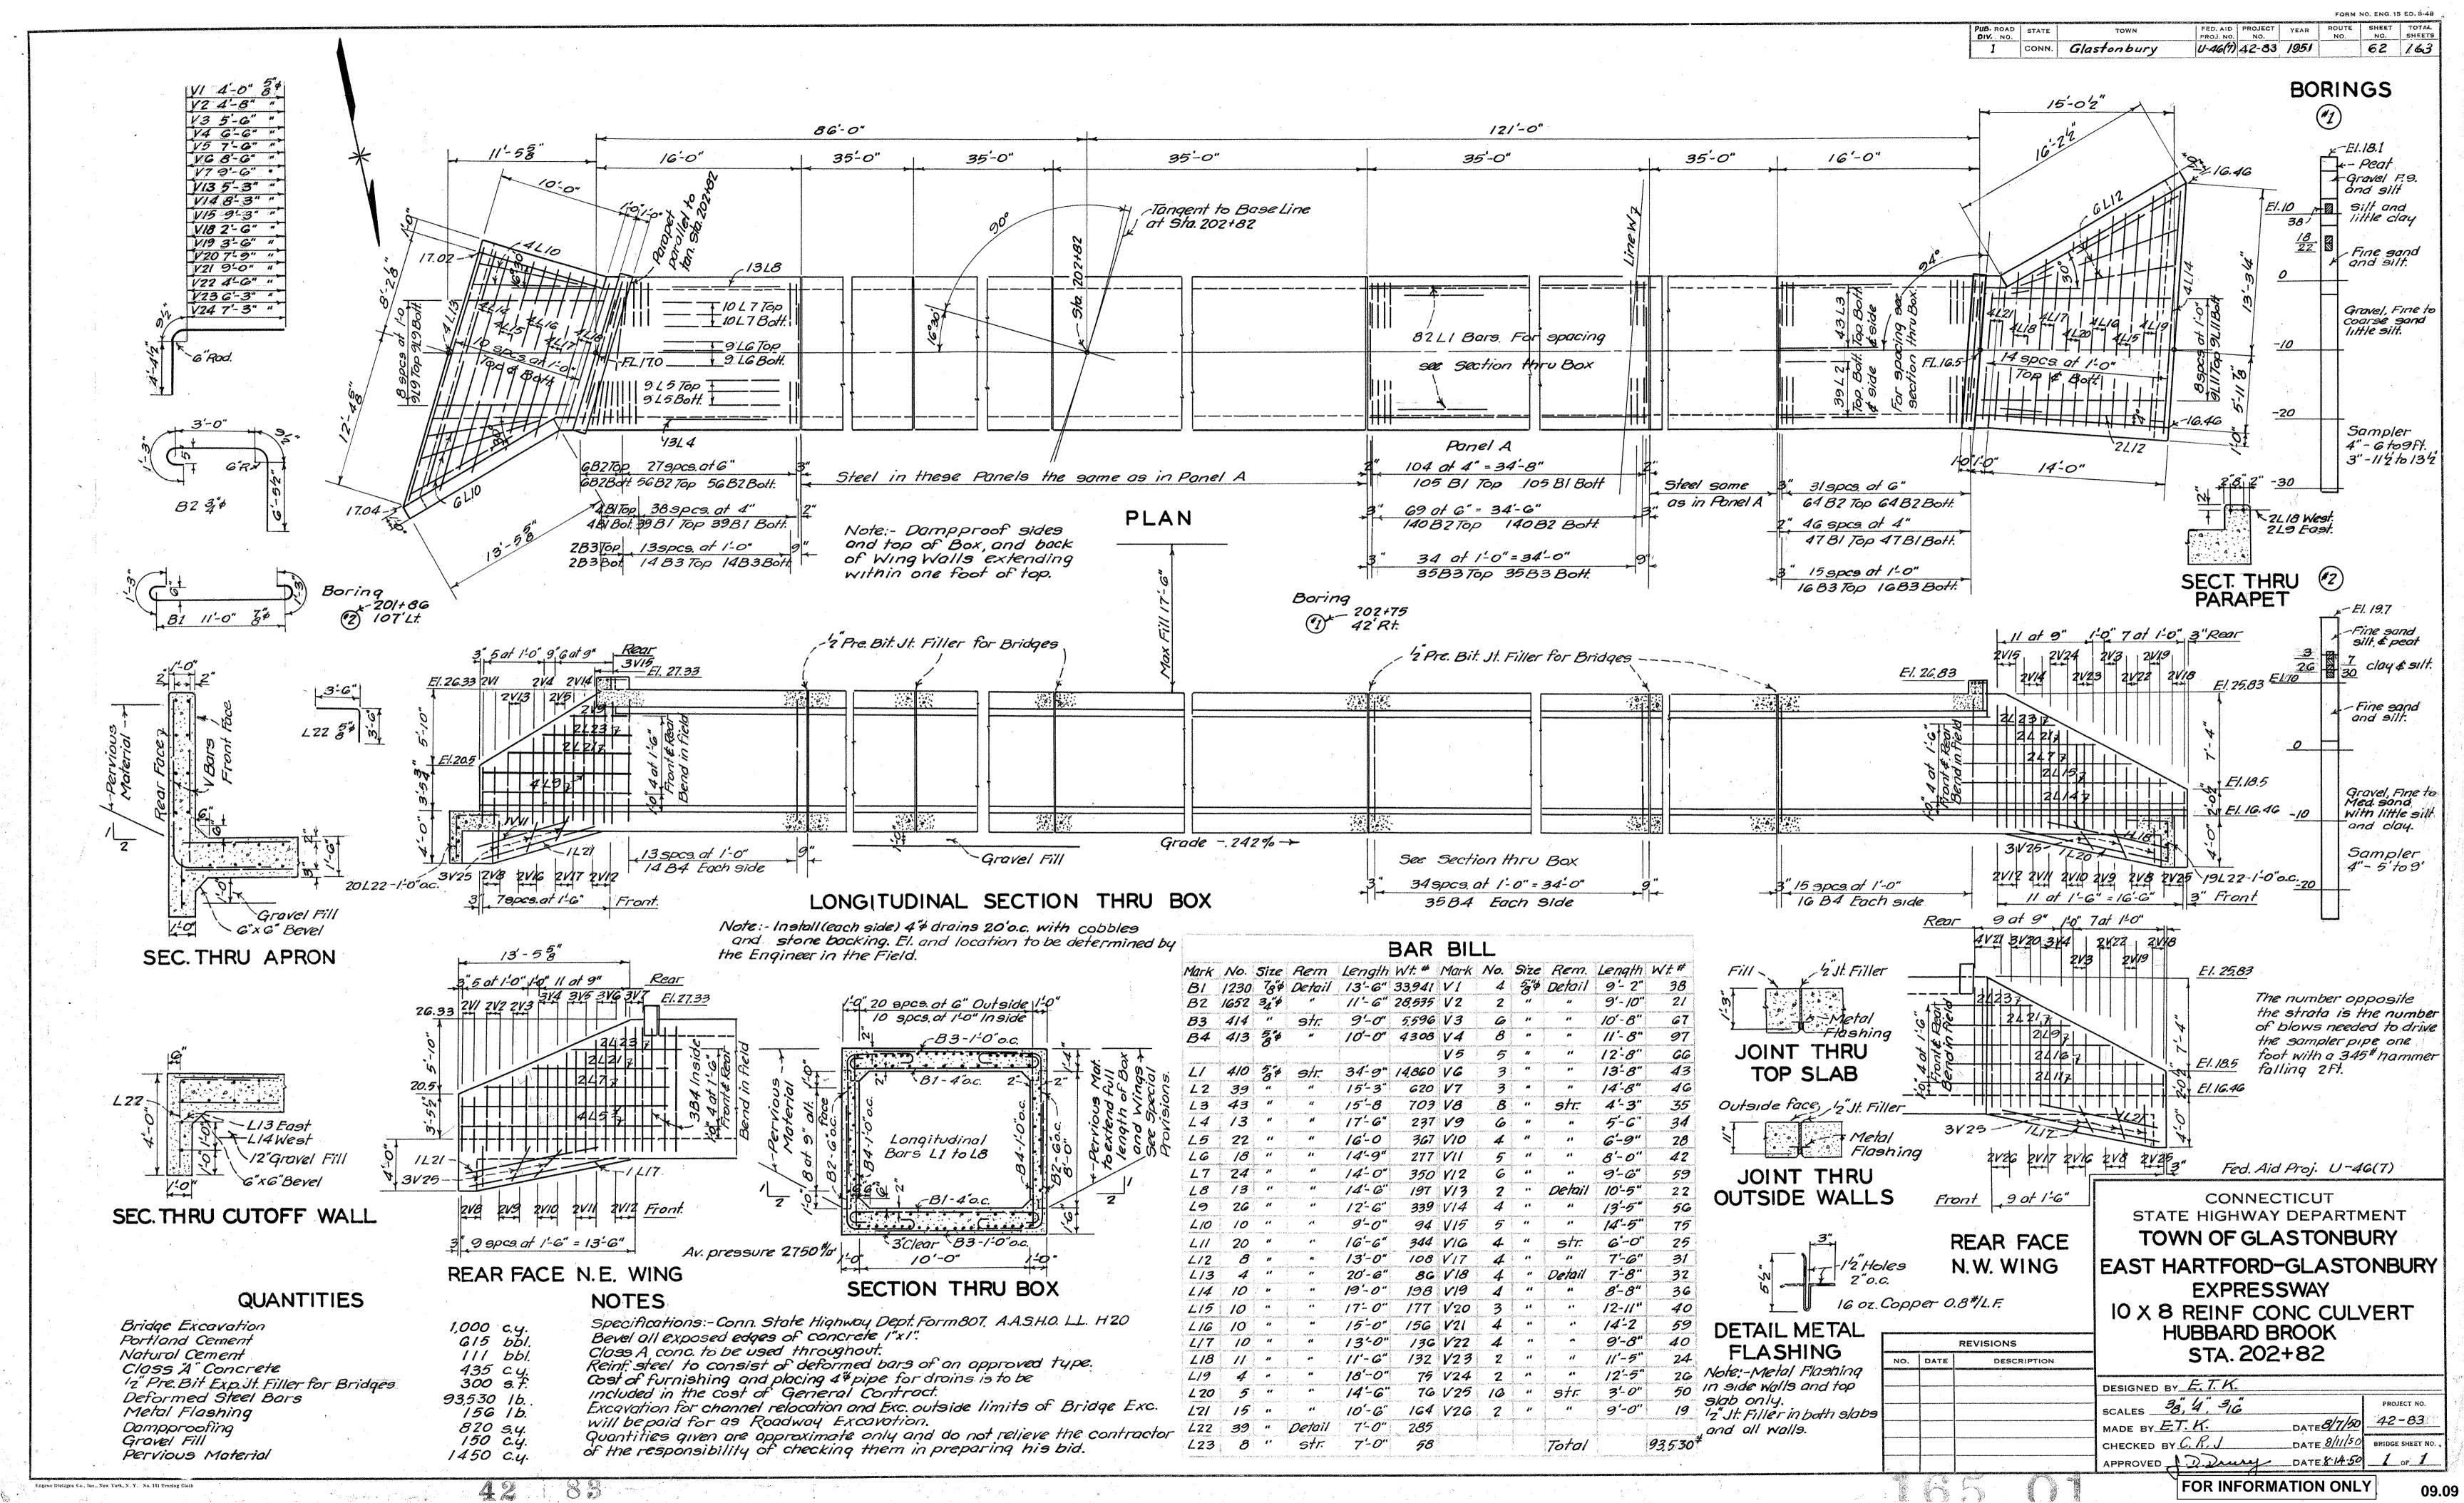

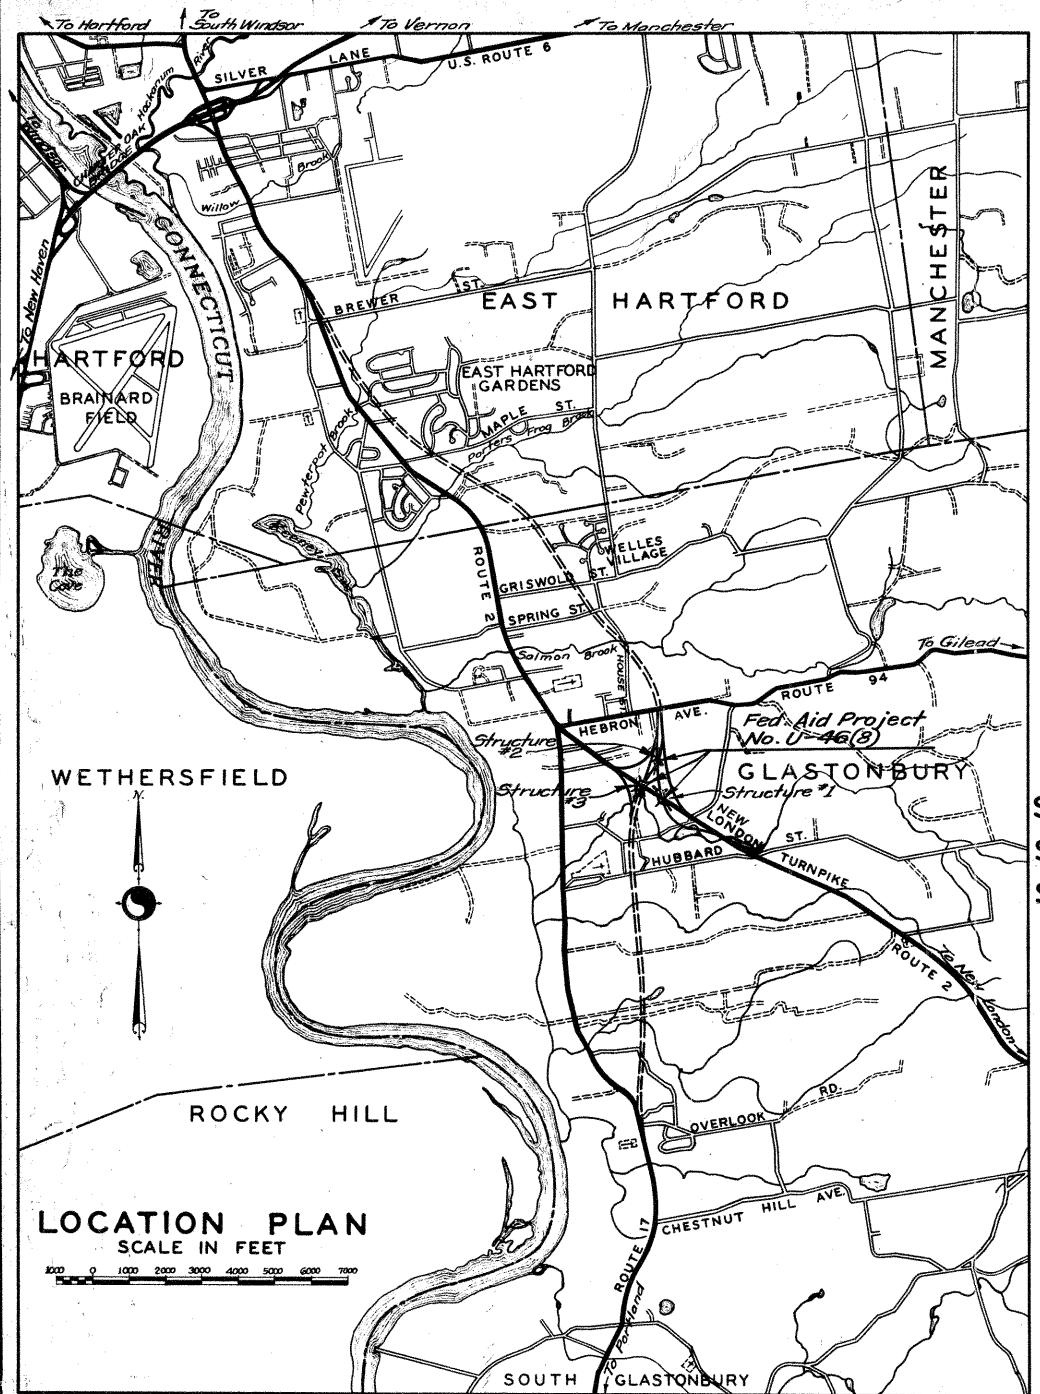

STANDARD CONVENTIONS

Picket Fence

Board Fence

Retaining Wall Open Ditch

Telegraph, Tele-phone of Elec-fric Light Poles

Trolley Poles

Ledge or Moch

Pole M.H

North Point

Tree Hydrant

Tivers,Lokes etc.

Open Ditch

Present Culvert

Proposed Culveri

Swamp

tighway Mon.

CHO Marker

Present C. B.

Proposed C.B.

____/ (____

Present

Hedge

Guide Roil

Gurb Stated whether Stone, wood or Conc

Stone Wall

Concrete Walk

enterante, automorie amuniciri amuniciri remuniciri remetino escribito escribito.

COMM. Co.

Present Trocks ----

Proposed Trocks

Taking Line

Property Line

Town Line

Grope Arbor

Wire Fence

WOLK - Tar, Gravel

CONNECTICUT

STATE HIGHWAY DEPARTMENT

PLAN FOR CONSTRUCTION

OF THREE STRUCTURES ON THE EAST HARTFORD-GLASTONBURY EXPRESSWAY & APPROACHES AT INTERCHANGE AT ROUTE 2

IN THE TOWN OF GLASTONBURY

FROM STA. 202+98.56 TO STA. 203+81.06 LENGTH 82.50 FT.

(PLAN 1 IN. = 100 FT. SCALES PROFILE HOR. 1 IN. - 100 FT. VERT. 1 IN. - 10 FT. CROSS SECTIONS 1 IN. ____FT.

NOTE: All Elevations For This Project Based Upon U.S.C.&G. DATUM FEDERAL AID PROJECT U-46 (8)

TO BE MAINTAINED BY THE STATE

|SECT'N. I-STRUCTURE 1-LINE "S'-STA.202+98.56-STA.203+81.06-LENGTH-82.50" SECT'N. II-STRUCTURE"2-LINE M-STA. 193+83.66-STA. 194+56.56-LENGTH" 72.90" SECT'N. III-STRUCTURE"3-BASE LINE-STA. 198+73.91-STA. 199+33.91-LENGTH 60.00

SHEET	TITLE	SHEET	STANDARDS
1	Title Sheet with Est. Quantities	7//	Figures for dotes on Bridge Rail
2-3	Typical Sections		
4	Plan Sheet		
5-6	Profile Sheets		
7-11	Bridge Sheets - Structure 1	1/2 / 2000	
12-16	Bridge Sheets - Structure 2	,	
17-21	Bridge Sheets - Structure 3	,	
	`		
	`		

*NOT INCLUDED IN LENGTH OF PROJECT

QUANTITIES OF LIMITED INVES- WARRANTED TO QUANTITIES OR	STRU LIN TOTAL S STRU LIN TOTALS
HICH WILL BE	STRUCT BASE L. TOTALSI FEO.AID

THE INFORMATION, INCLUDING ESTIMATED

work, shown on thes**e sheets is** based on


TIGATIONS BY THE STATE AND IS IN NO WAY

INDICATE THE TRUE CONDITIONS OR ACTUAL


DISTRIBUTION OF QUANTITIES OF WORK WI

CONSTRUCTION STARTED SEPT. 19, 1950					Ė	STIM	ATED	Ql	JANTI	TIES				
CONSTRUCTION COMPLETED MAY 15, 1952 PLANS REVISED BY EH.B. DATE 10/30/63 PLANS CHECKED BY A.J.B. DATE 11/6/83		BRIDGE	PORTLAND	NATURAL	CLASS A CONCRETE	1/2" PREM. BIT. EXP. JOINT FILL: ER FOR BRIDGES	DEFORMED STEEL BARS	STRUCTURAL	METAL FLASHING	DAMP PROOFING	METAL BRIDGE RAIL	GRAVEL FILL	PERVIOUS MATERIAL	
		C.Y.	BBL.	BBL.	C.Y.	S,F.	LB.	LB.	LB.	S.Y.	L.F.	C.Y.	C.Y.	
			FEDE	RAL			AID		<u>, PA</u>	RTICIPA	<u>ATING</u>		-:	
					BRIDG	med sin	SEC	CTION	, I				<i>*</i>	
	STRUCTURE !	1185	1825	330	1291	475	83844	161000	256	586	171	1000	250	
MENDIATION INCLUDING ECTIVATED MIANTIFICO OF	TOTAL SECTION I	1185	1825	330	1291	475	83844	161000	256	586	171	100	250	
INFORMATION, INCLUDING ESTIMATED QUANTITIES OF		¥	*		BRIDG		SE	CTION	<u> </u>	<i>(</i>			4	
OWN ON THESE SHEETS IS BASED ON LIMITED INVES-	STRUCTURE Z	1600	1820	329	1288	180	83427	116000	275	560	152	100	320	
BY THE STATE AND IS IN NO WAY WARRANTED TO	TOTAL SECTION II	1600	1820	329	1288	180	83427	116 000	×275	560	152	100	320	
THE TRUE CONDITIONS OR ACTUAL QUANTITIES OR			i ·	✓	BRIDG		SE	CTION		a -	i i			
ITION OF QUANTITIES OF WORK WHICH WILL BE	STRUCTURE 3 BASE LINE	992	2010	363	1423	693	102 672	177500	418	660	122	208	100	
	TOTAL SECTION III	992		_363·	1423	693	102672	177500	418	660	122	208	1000	
	FEO.AID PARTICIPG. GRAND TOTALS		-3	1022	4002	1348	269943	454500	949	1806	445	408	610	


THESE QUANTITIES NOT CORRECTED

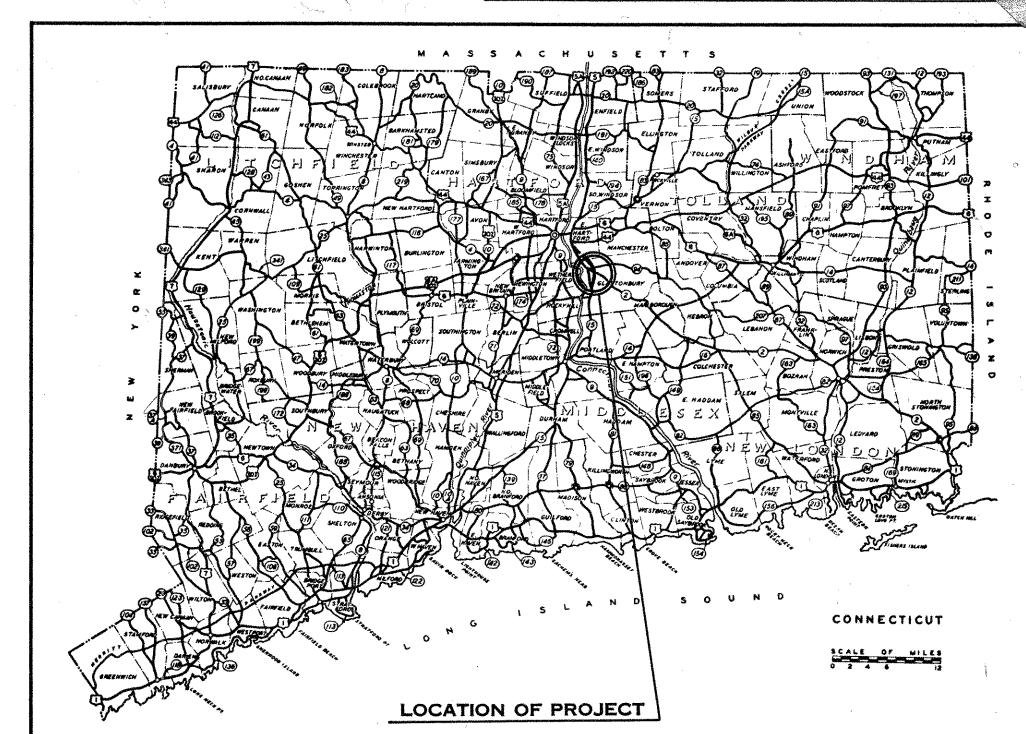

STATE TOWN FED. AID FISCAL ROUTE SHEE PROJ. NO. YEAR NO. NO.

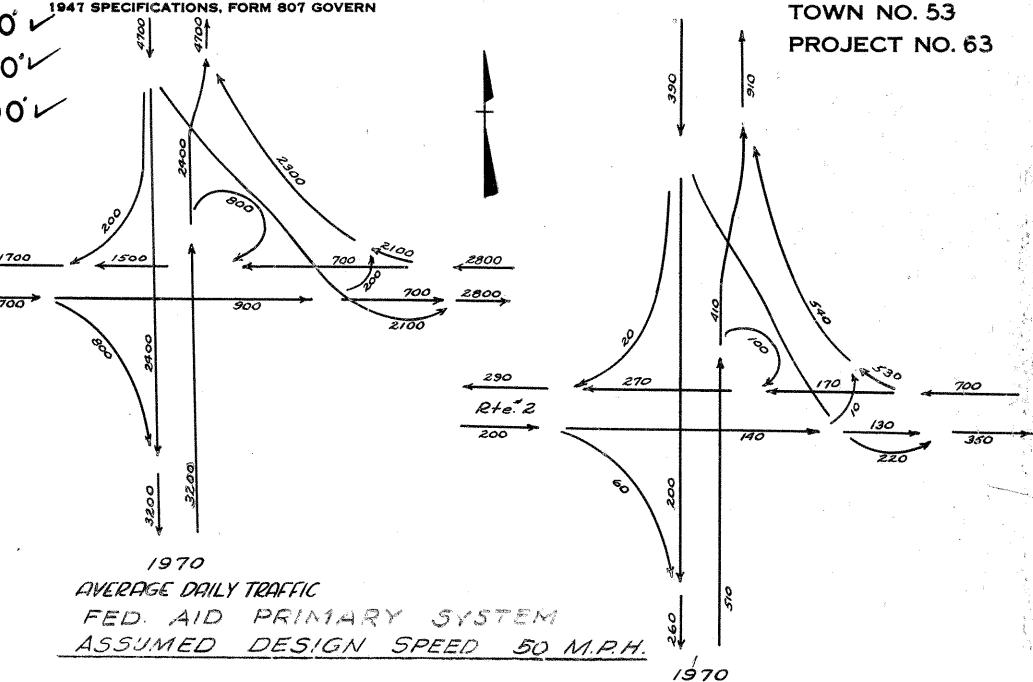


30th HIGHEST HOUR

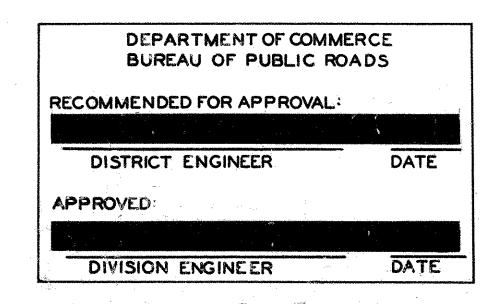



ENGINEER OF HIGHWAY DESIGN APPROVED July 27 M. alfiel Kachile ENGINEER OF LOCATION & DESIGN APPROVED July 27 DEPUTY HIPHWAY COMMISSIONER


FOR INFORMATION ONLY

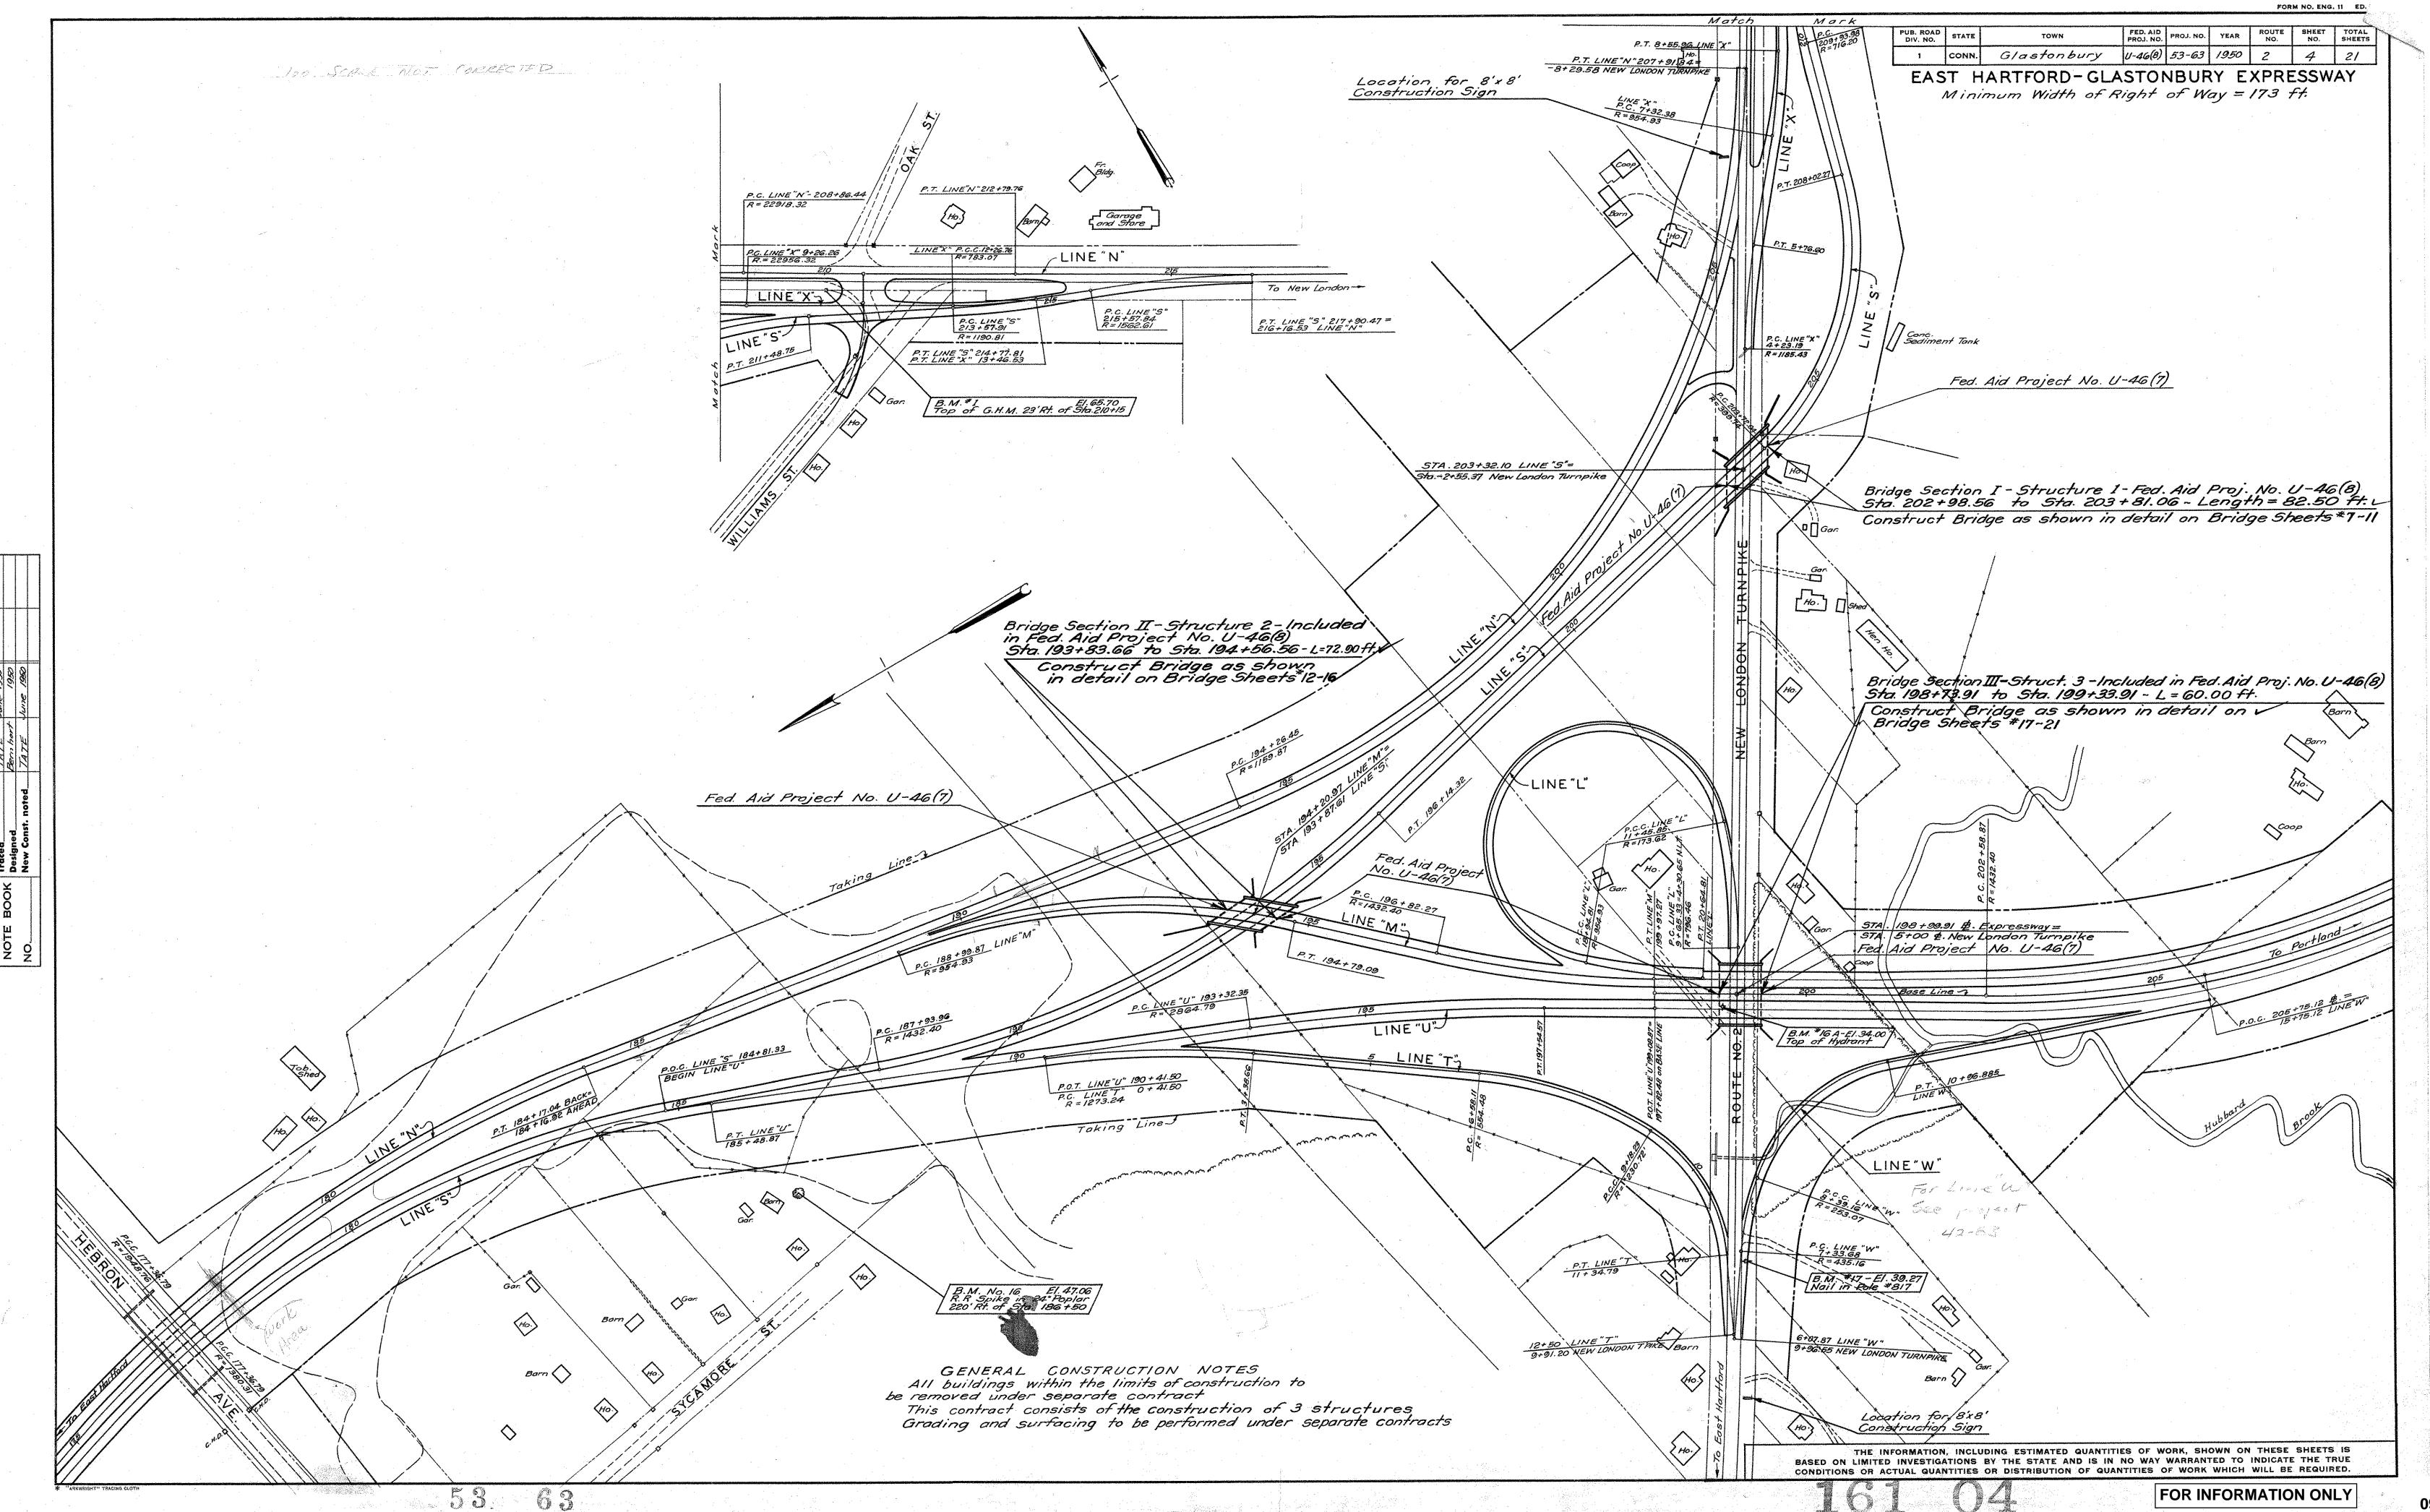



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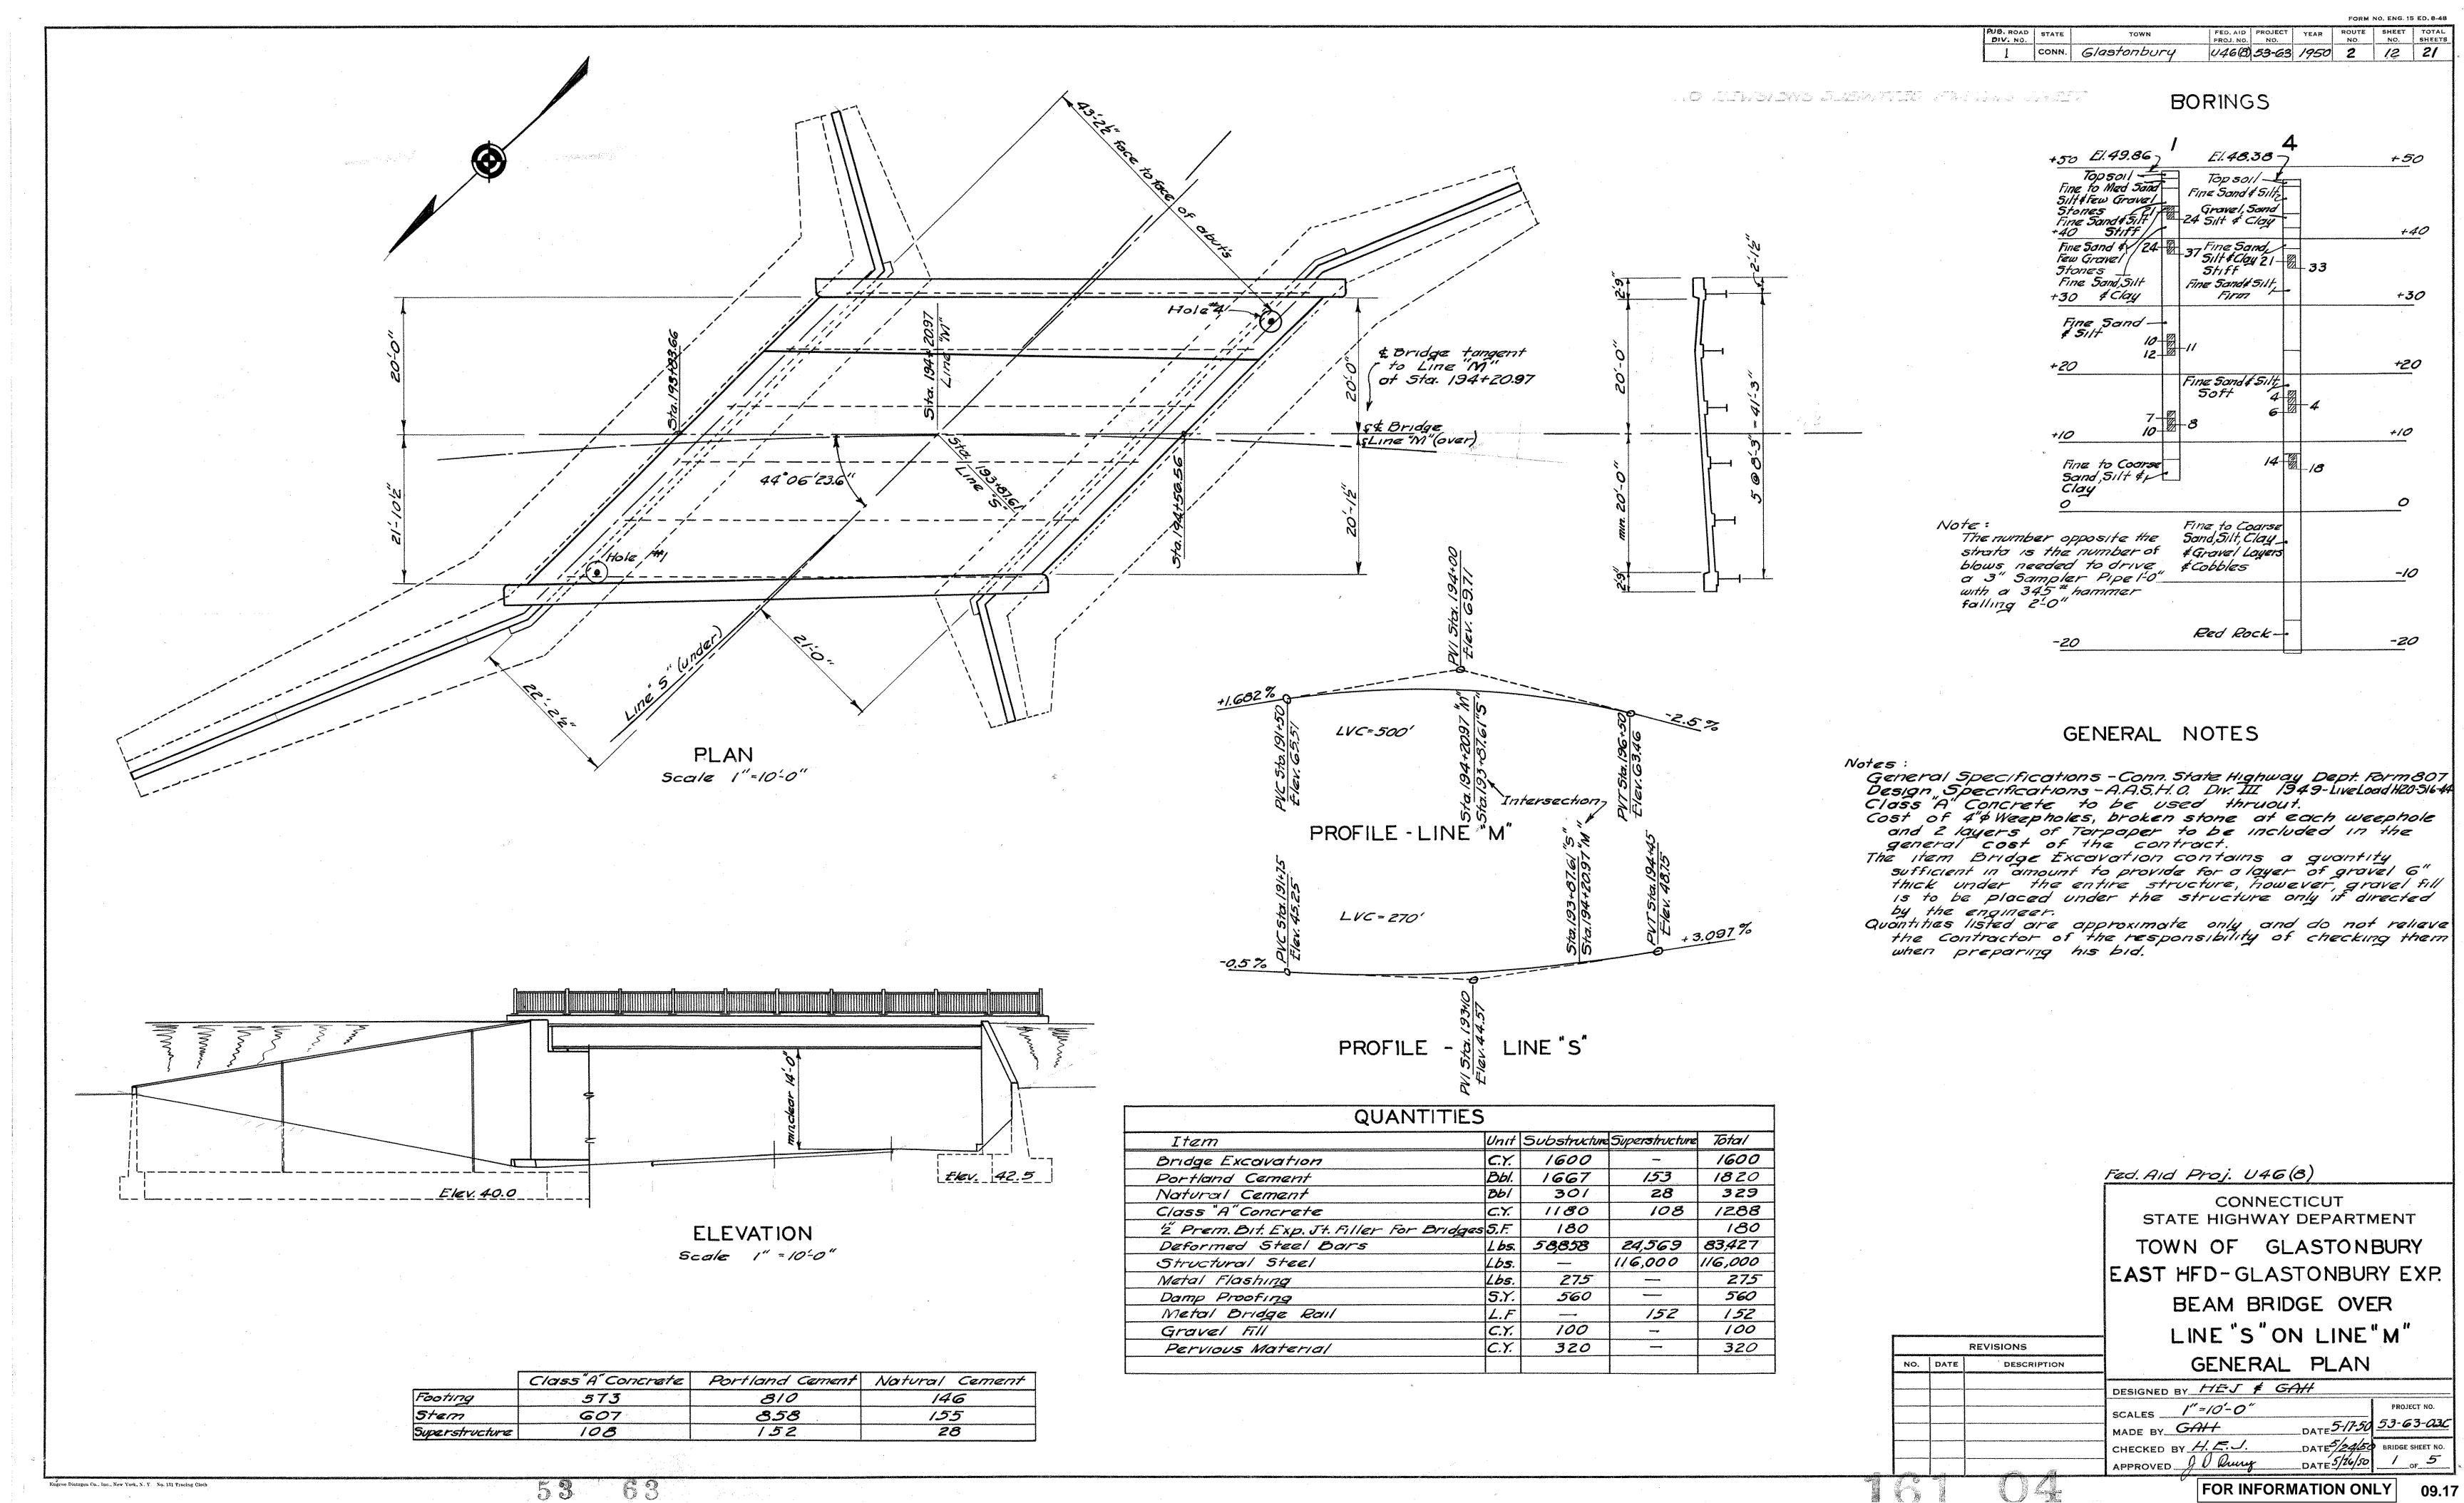


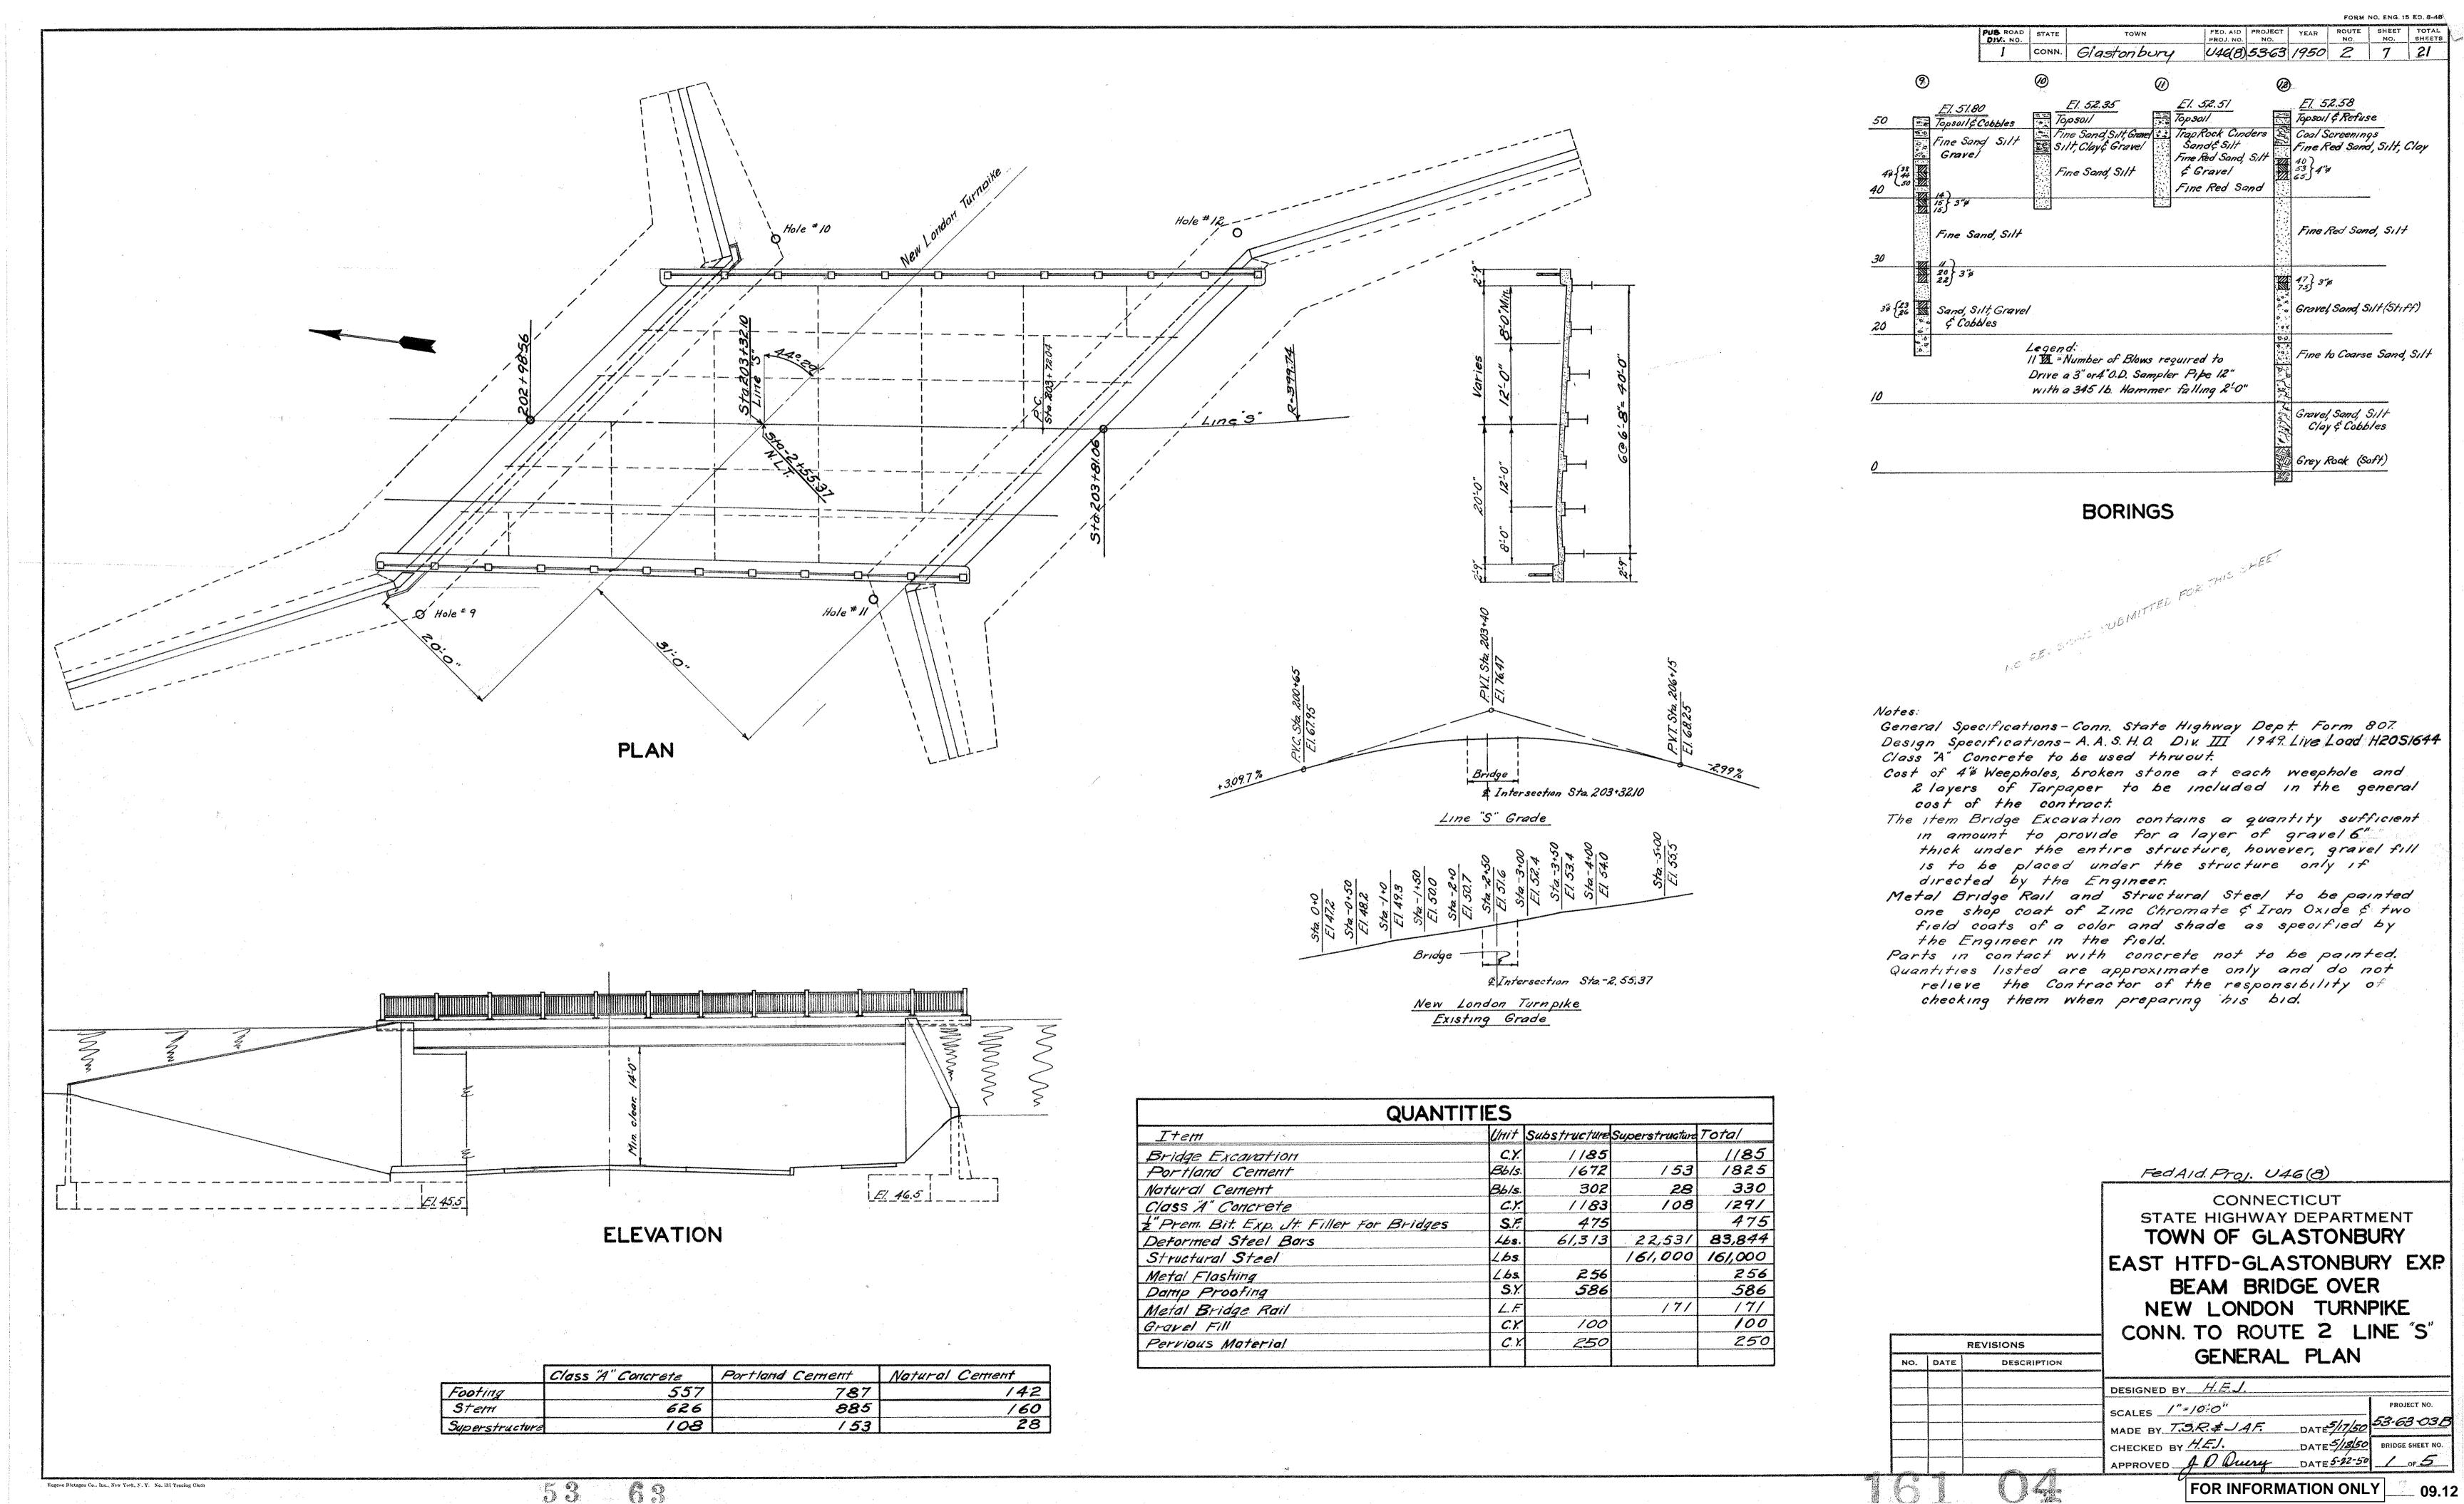


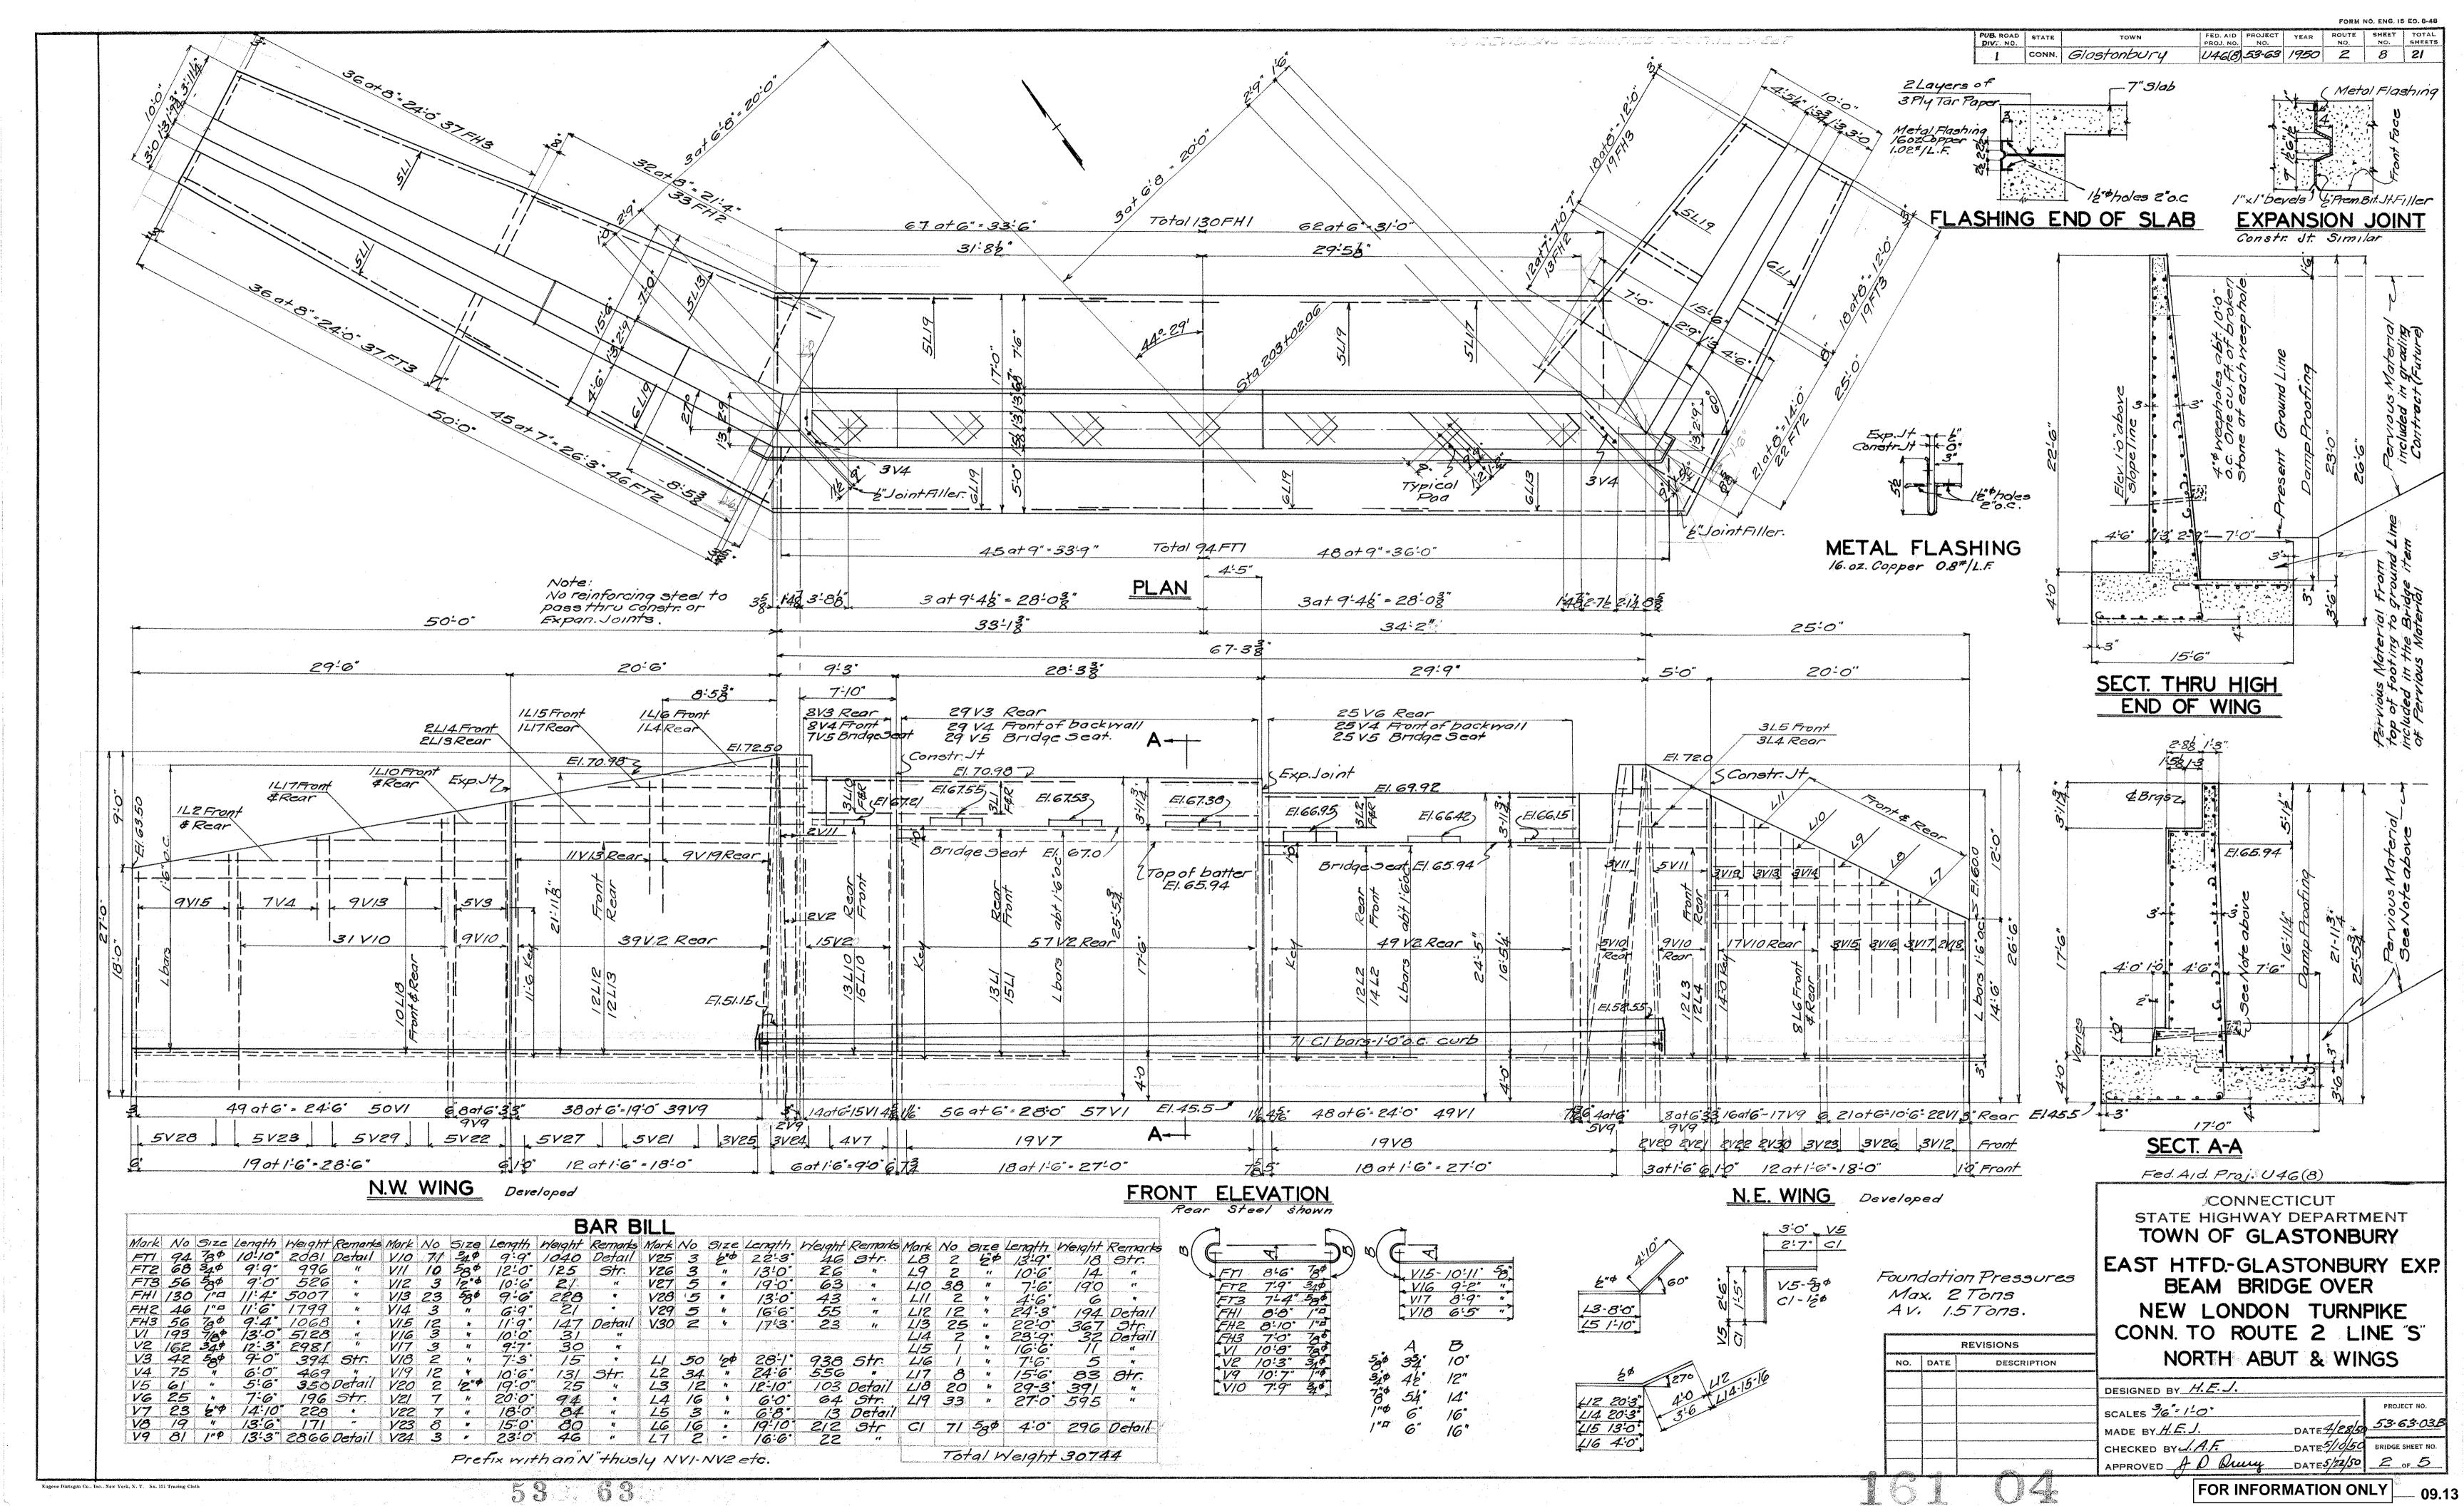


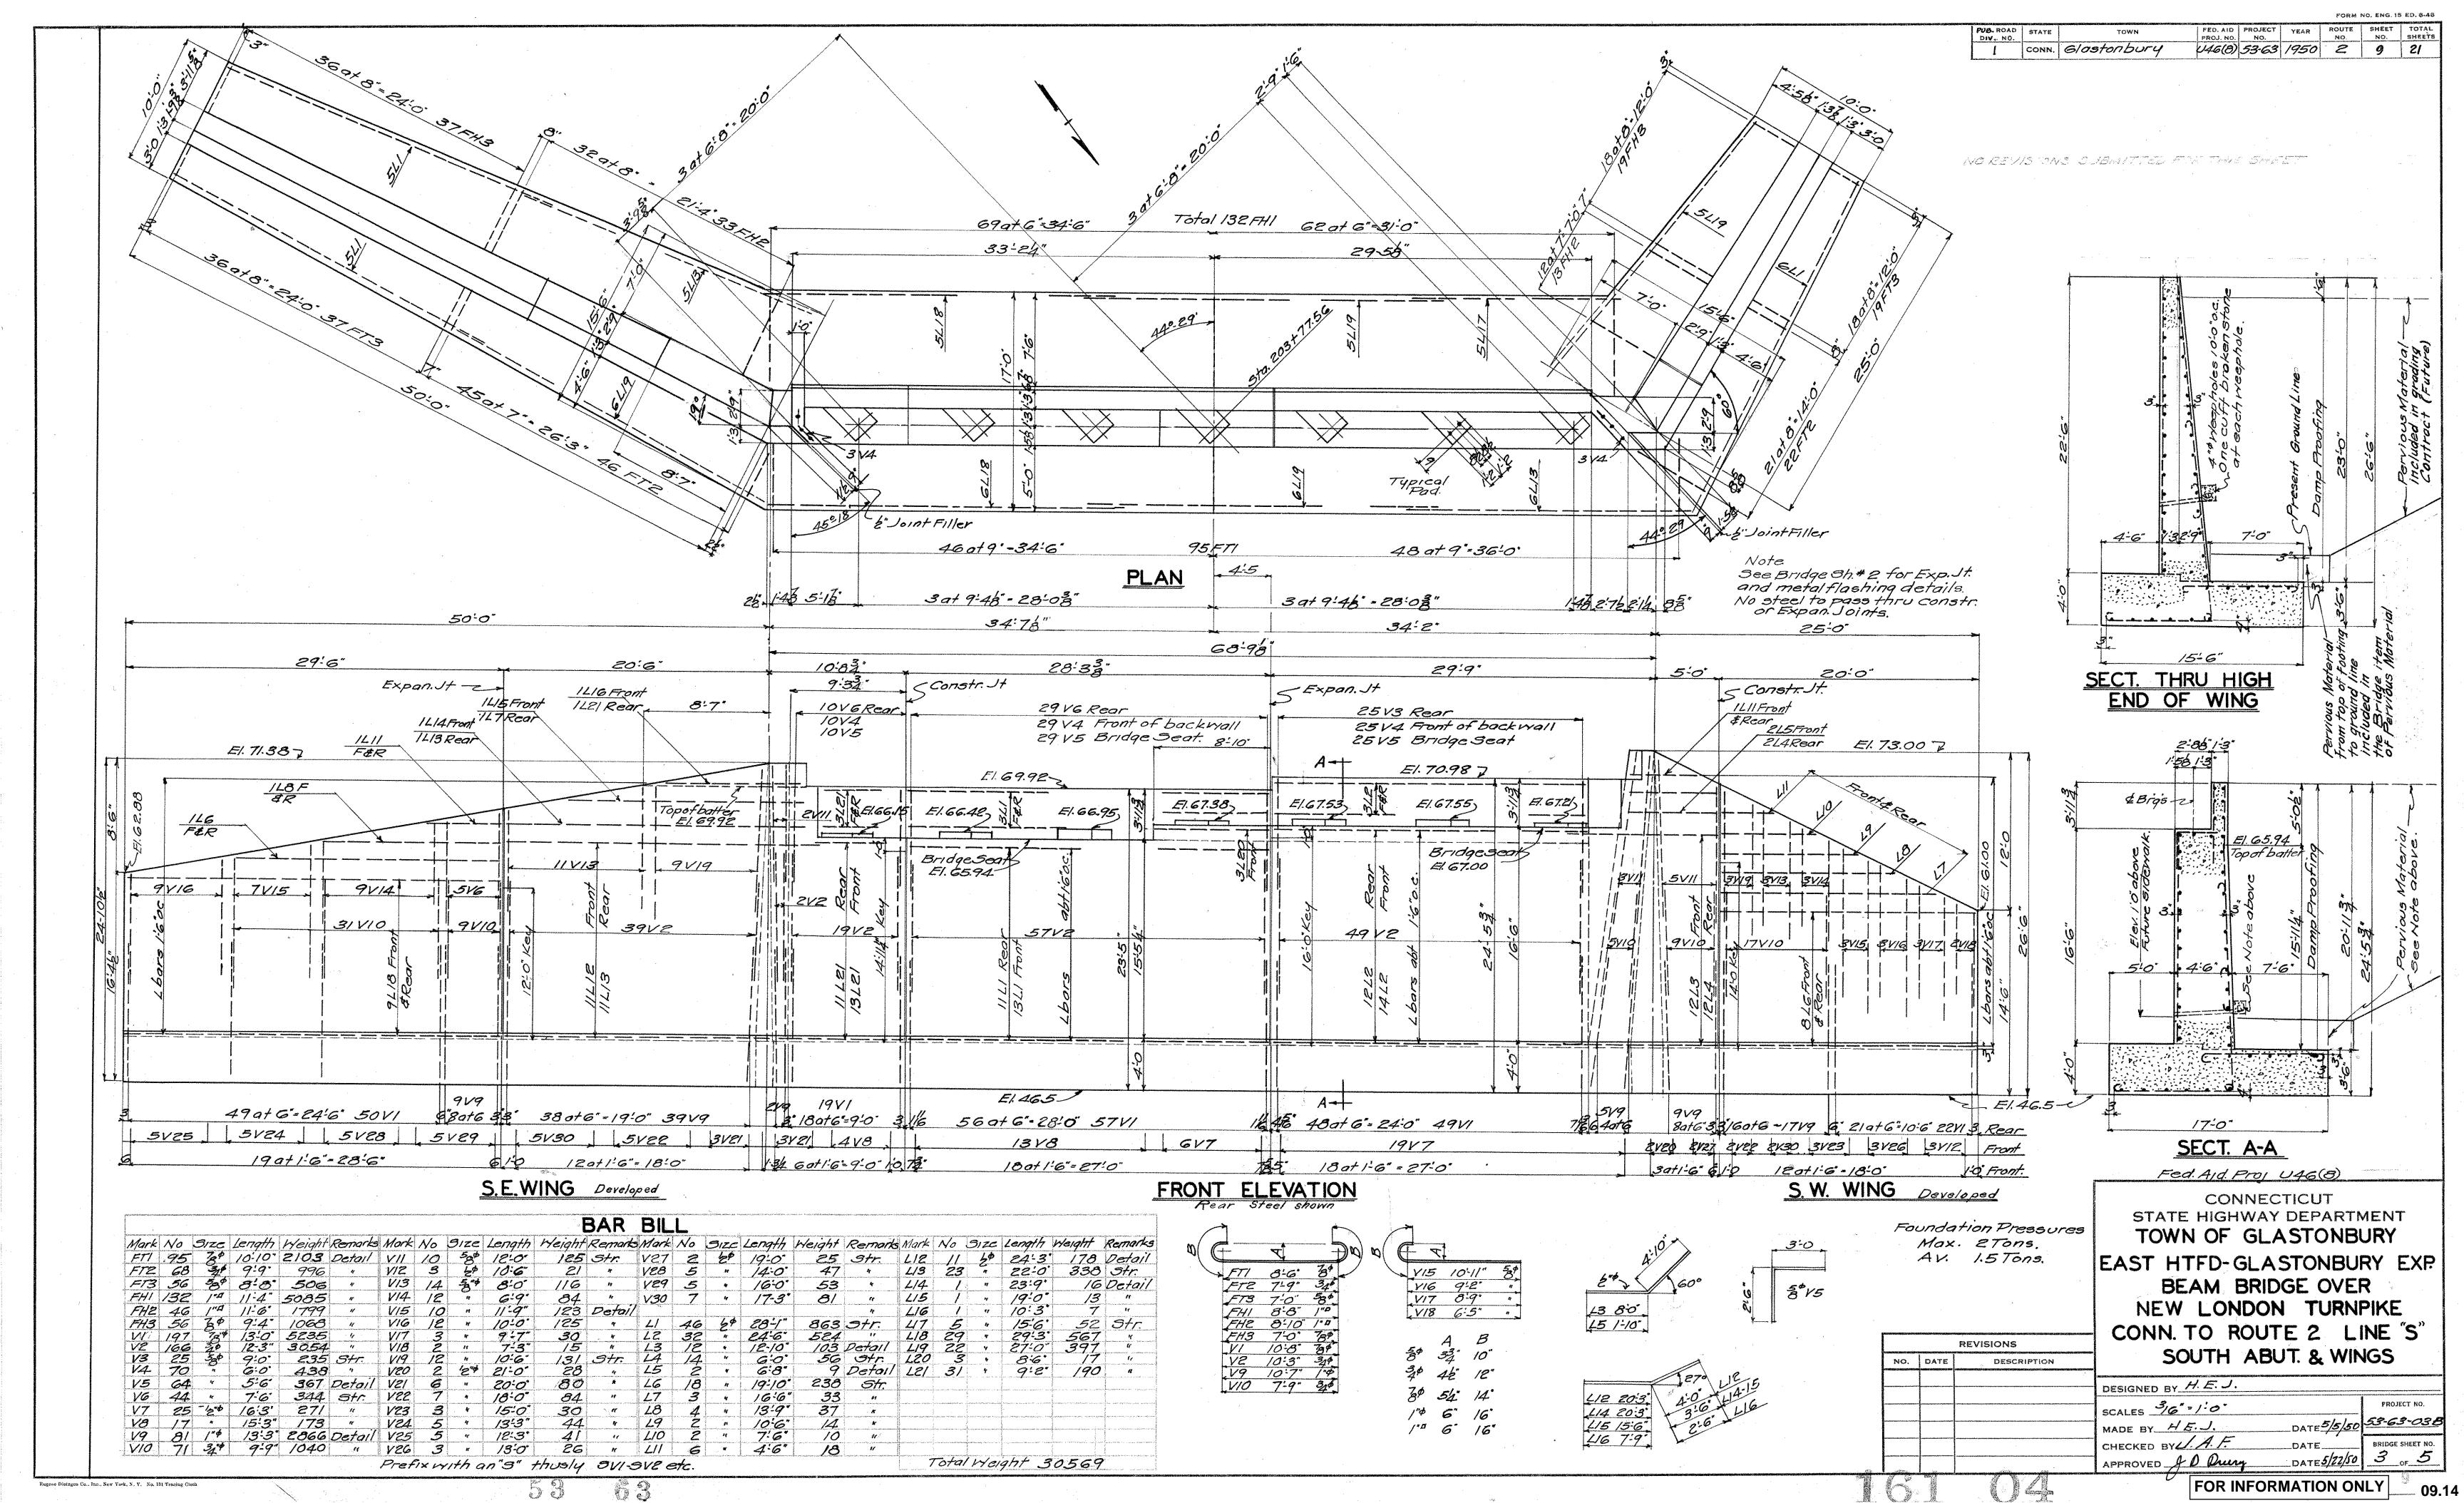


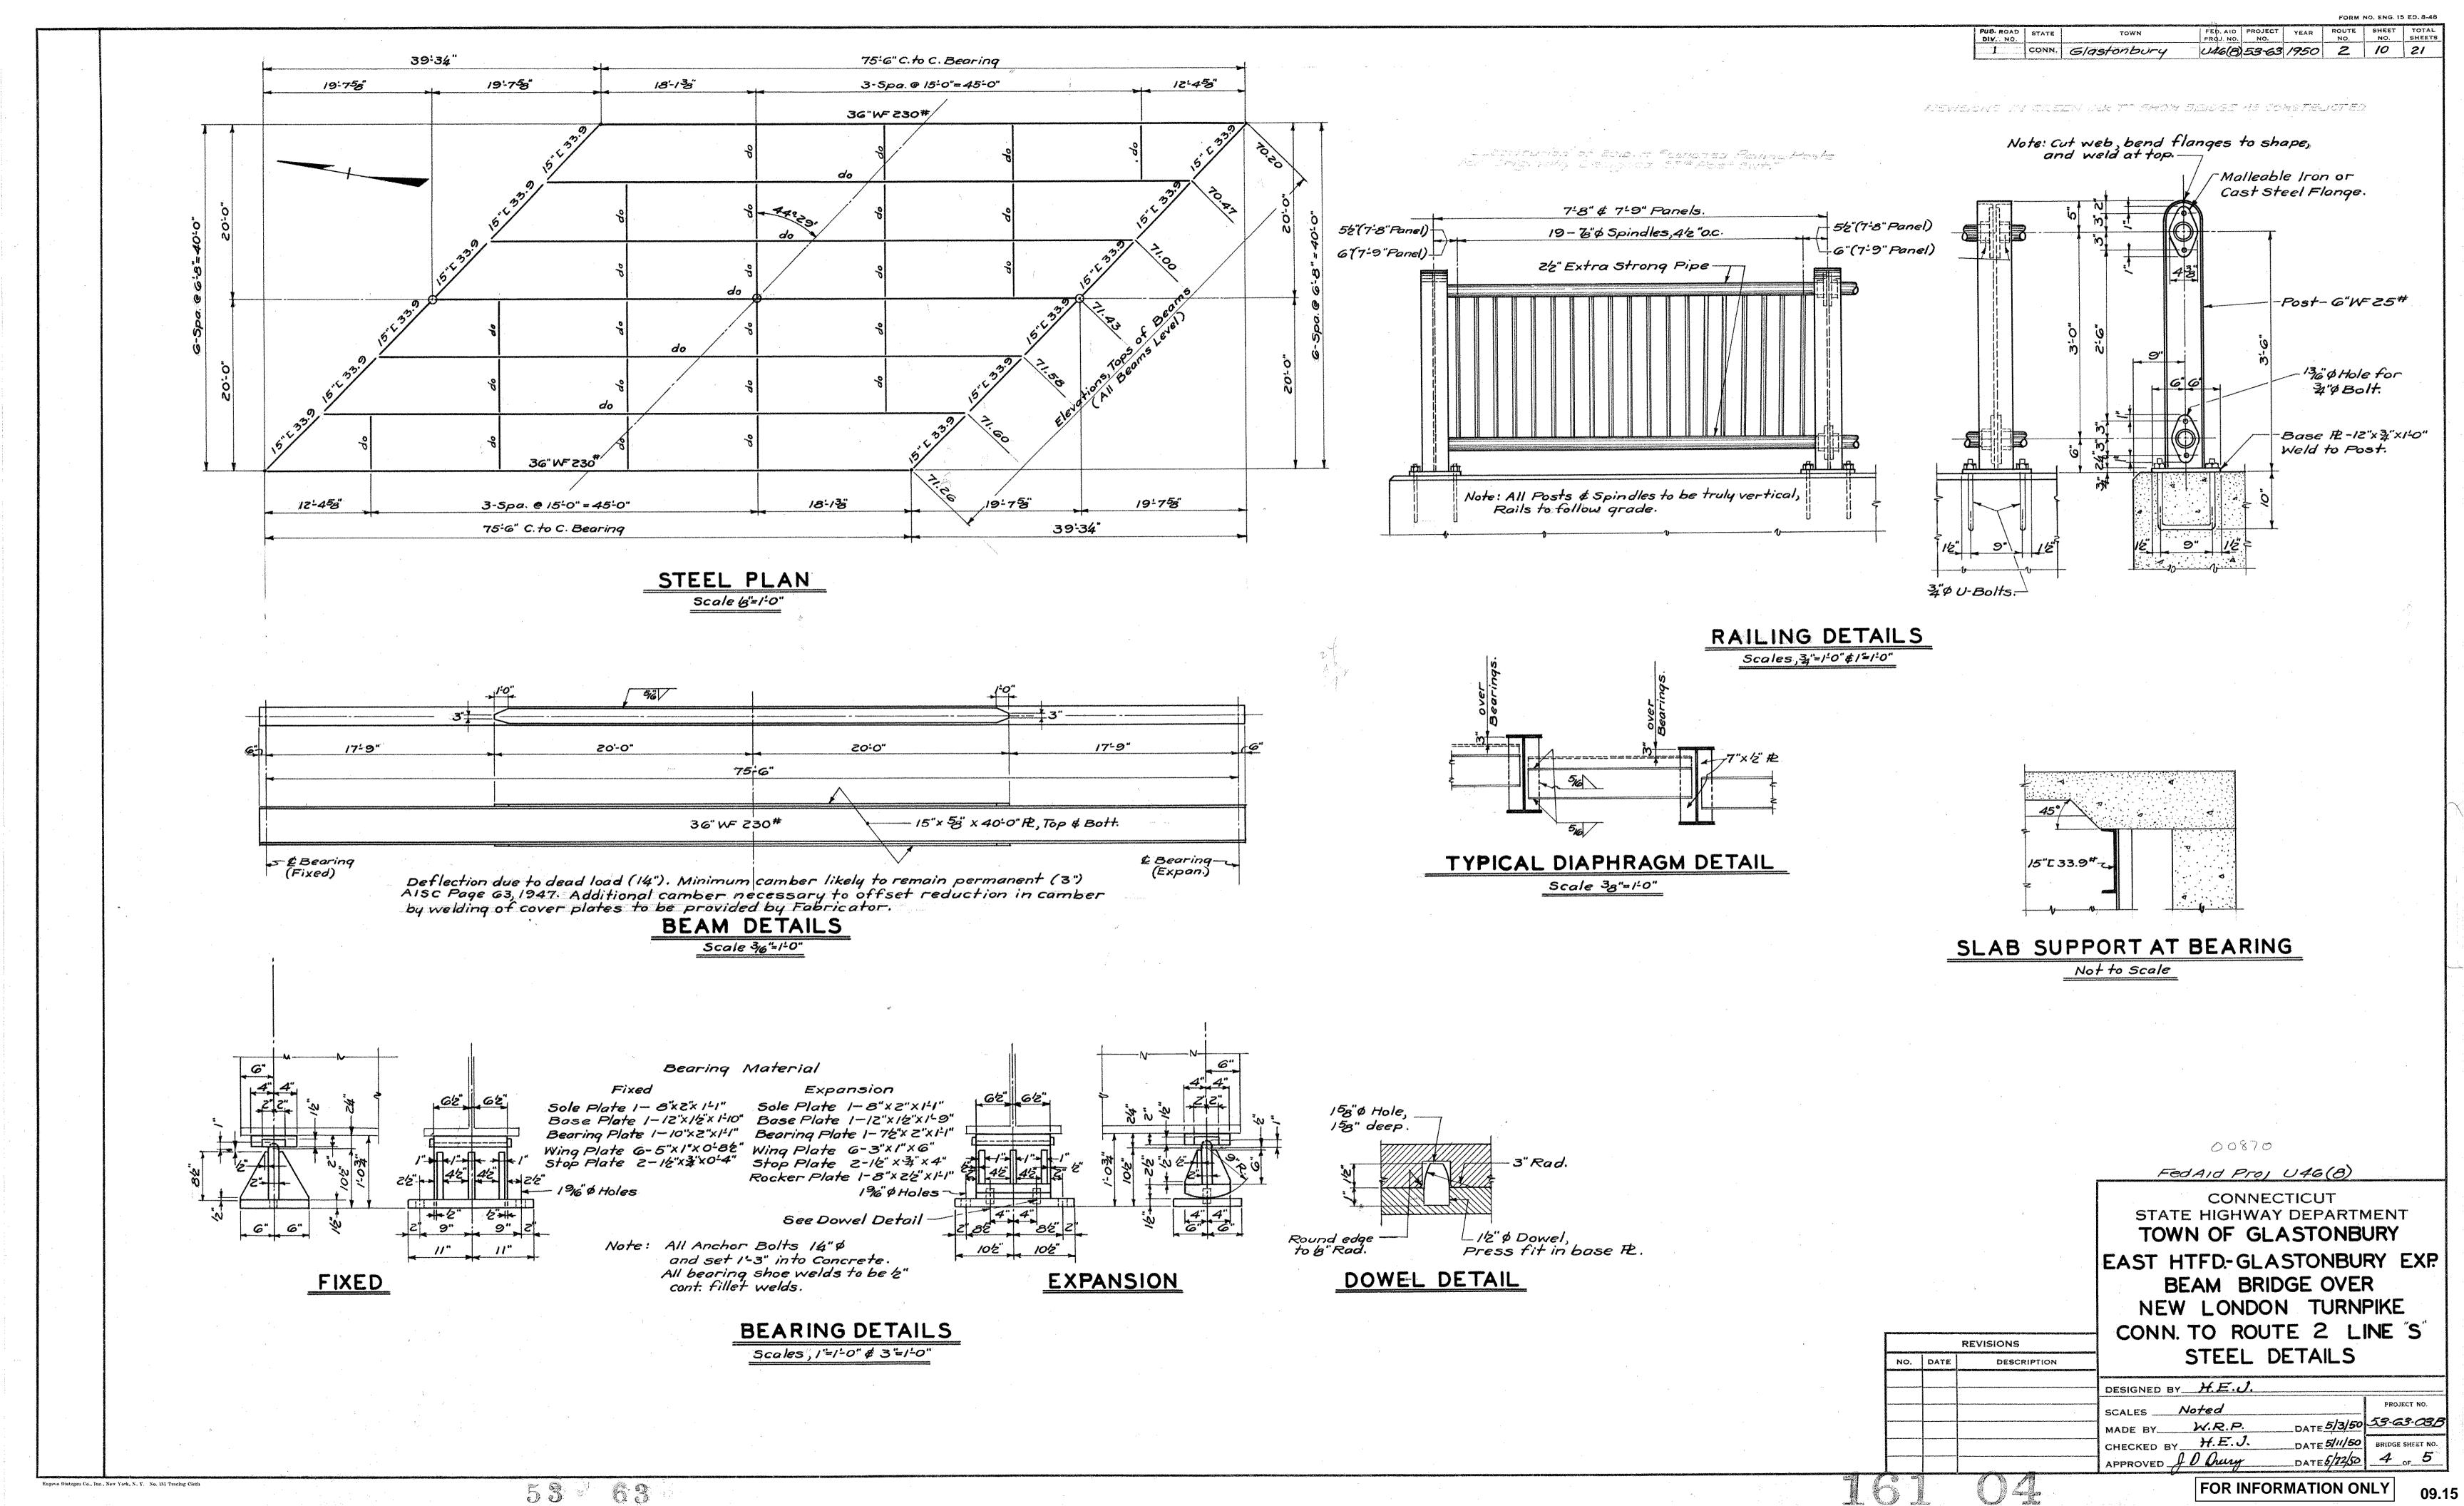


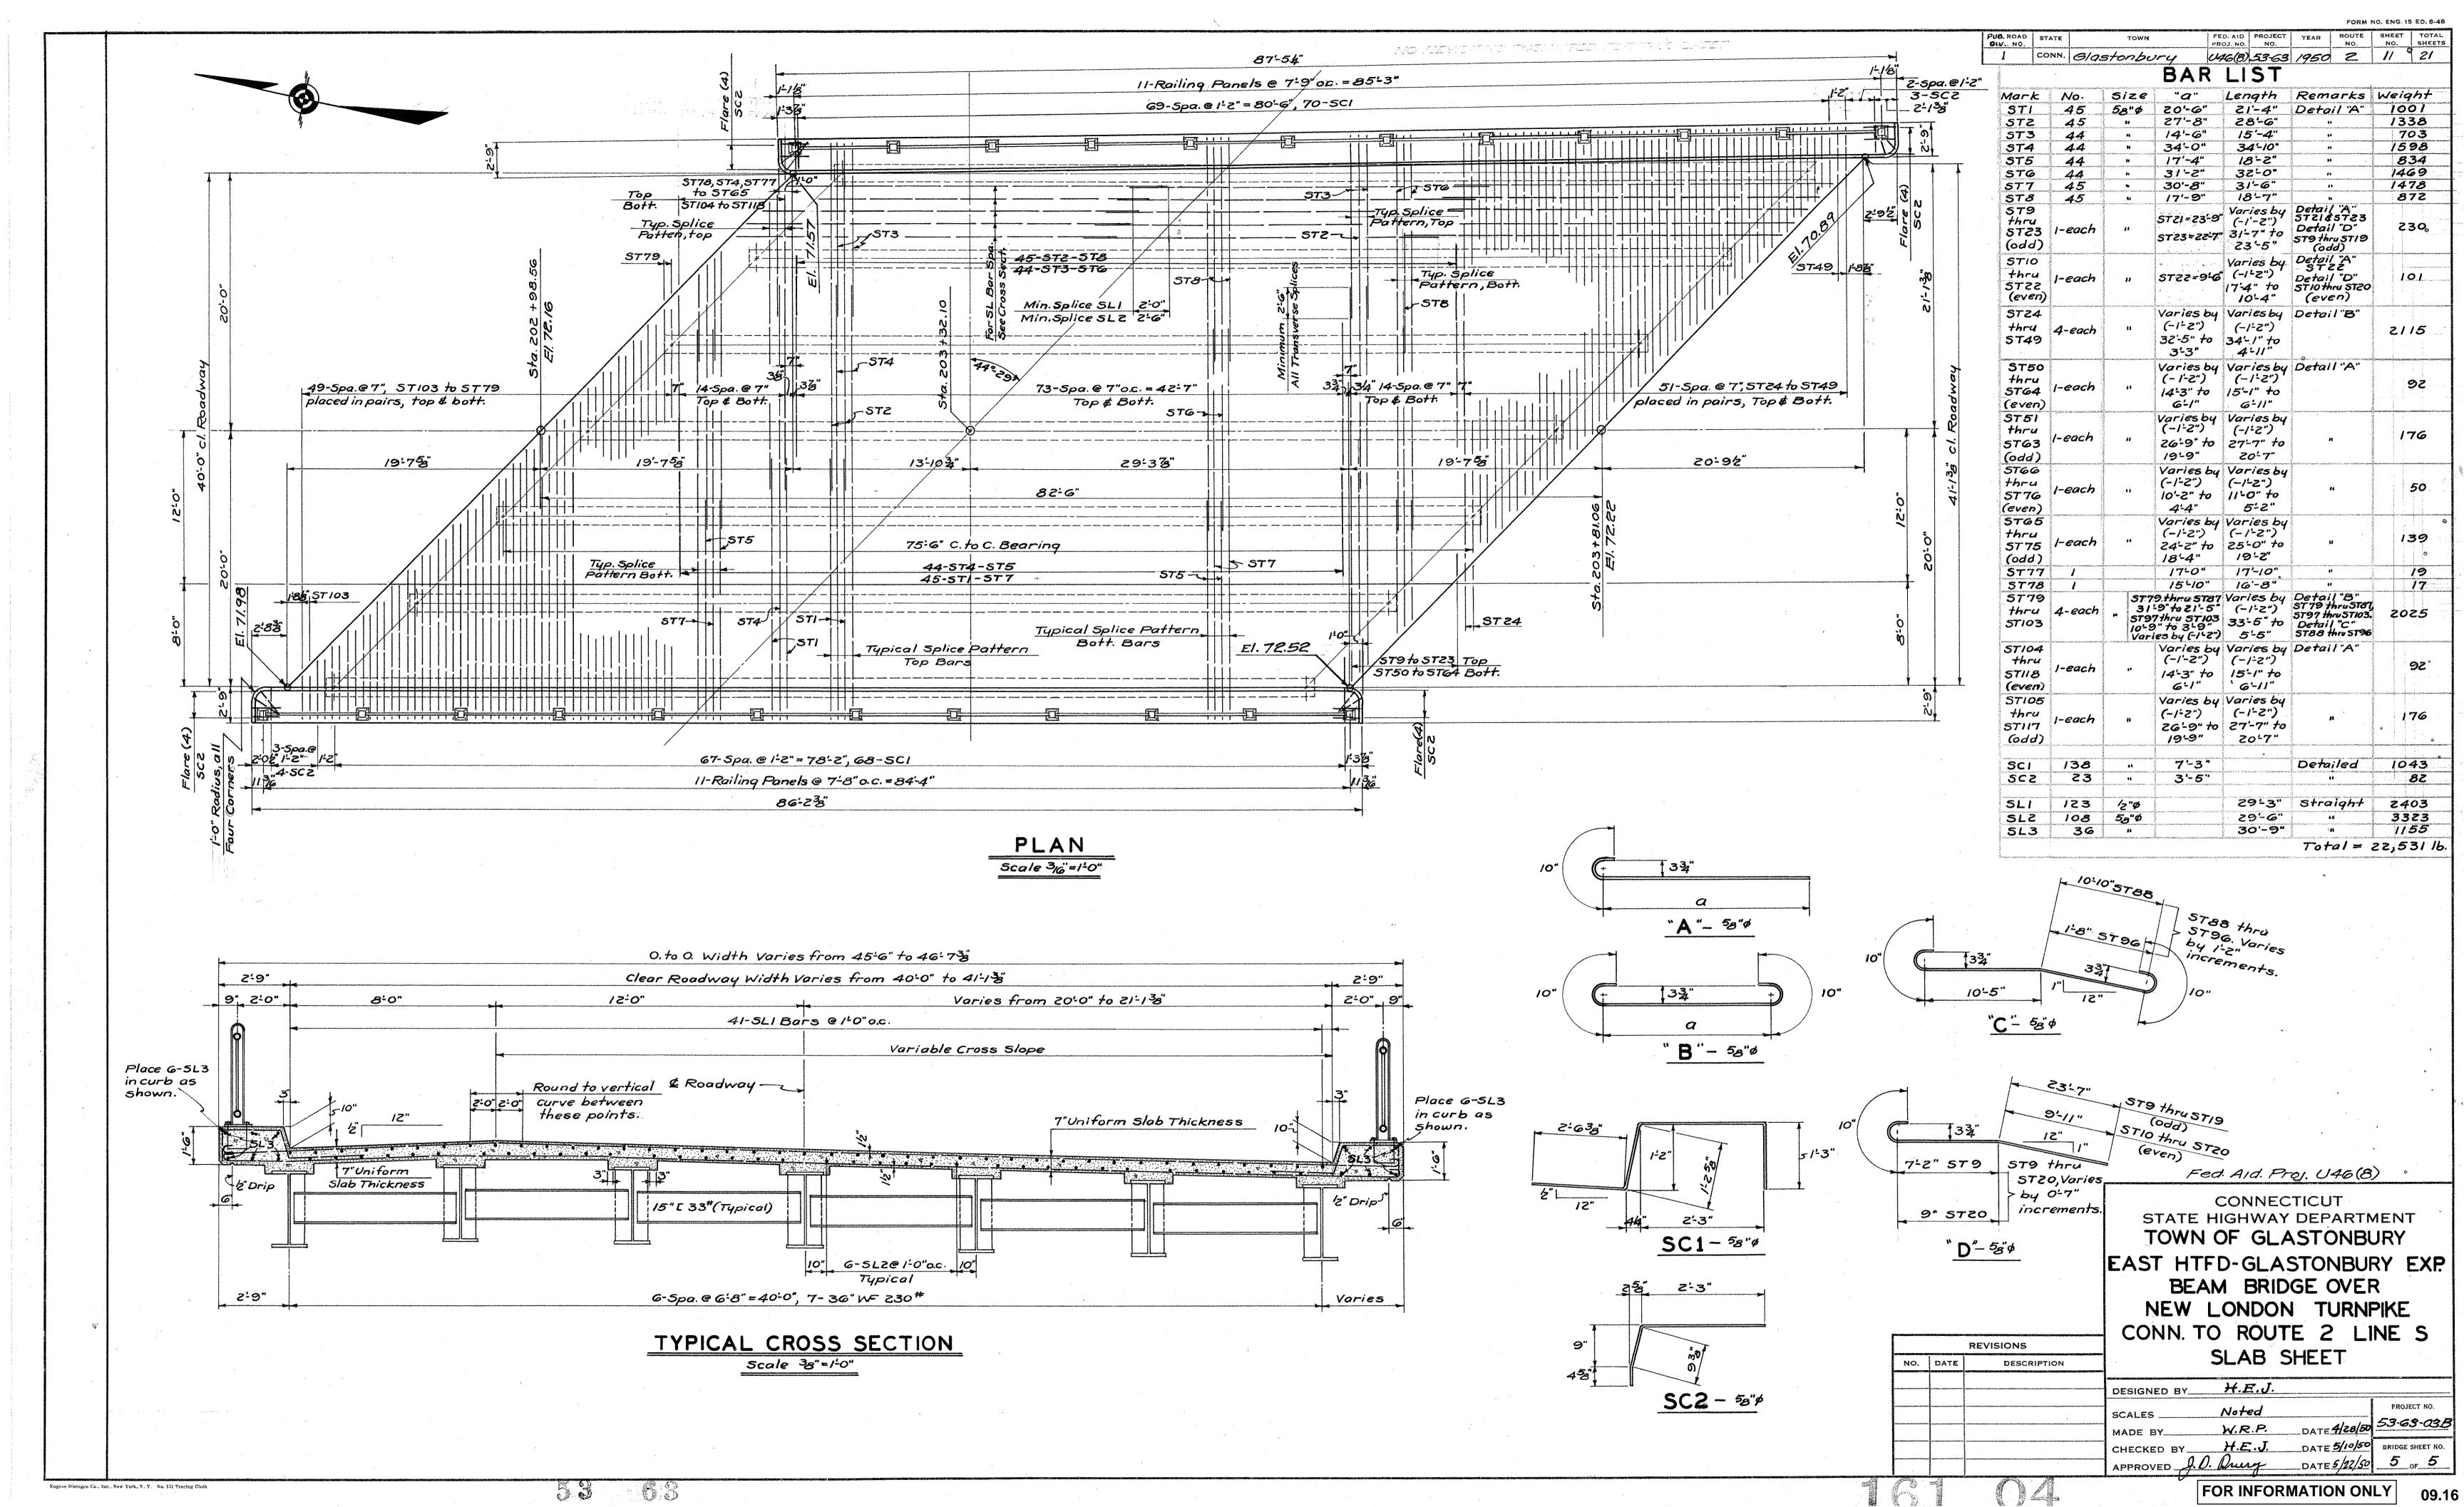


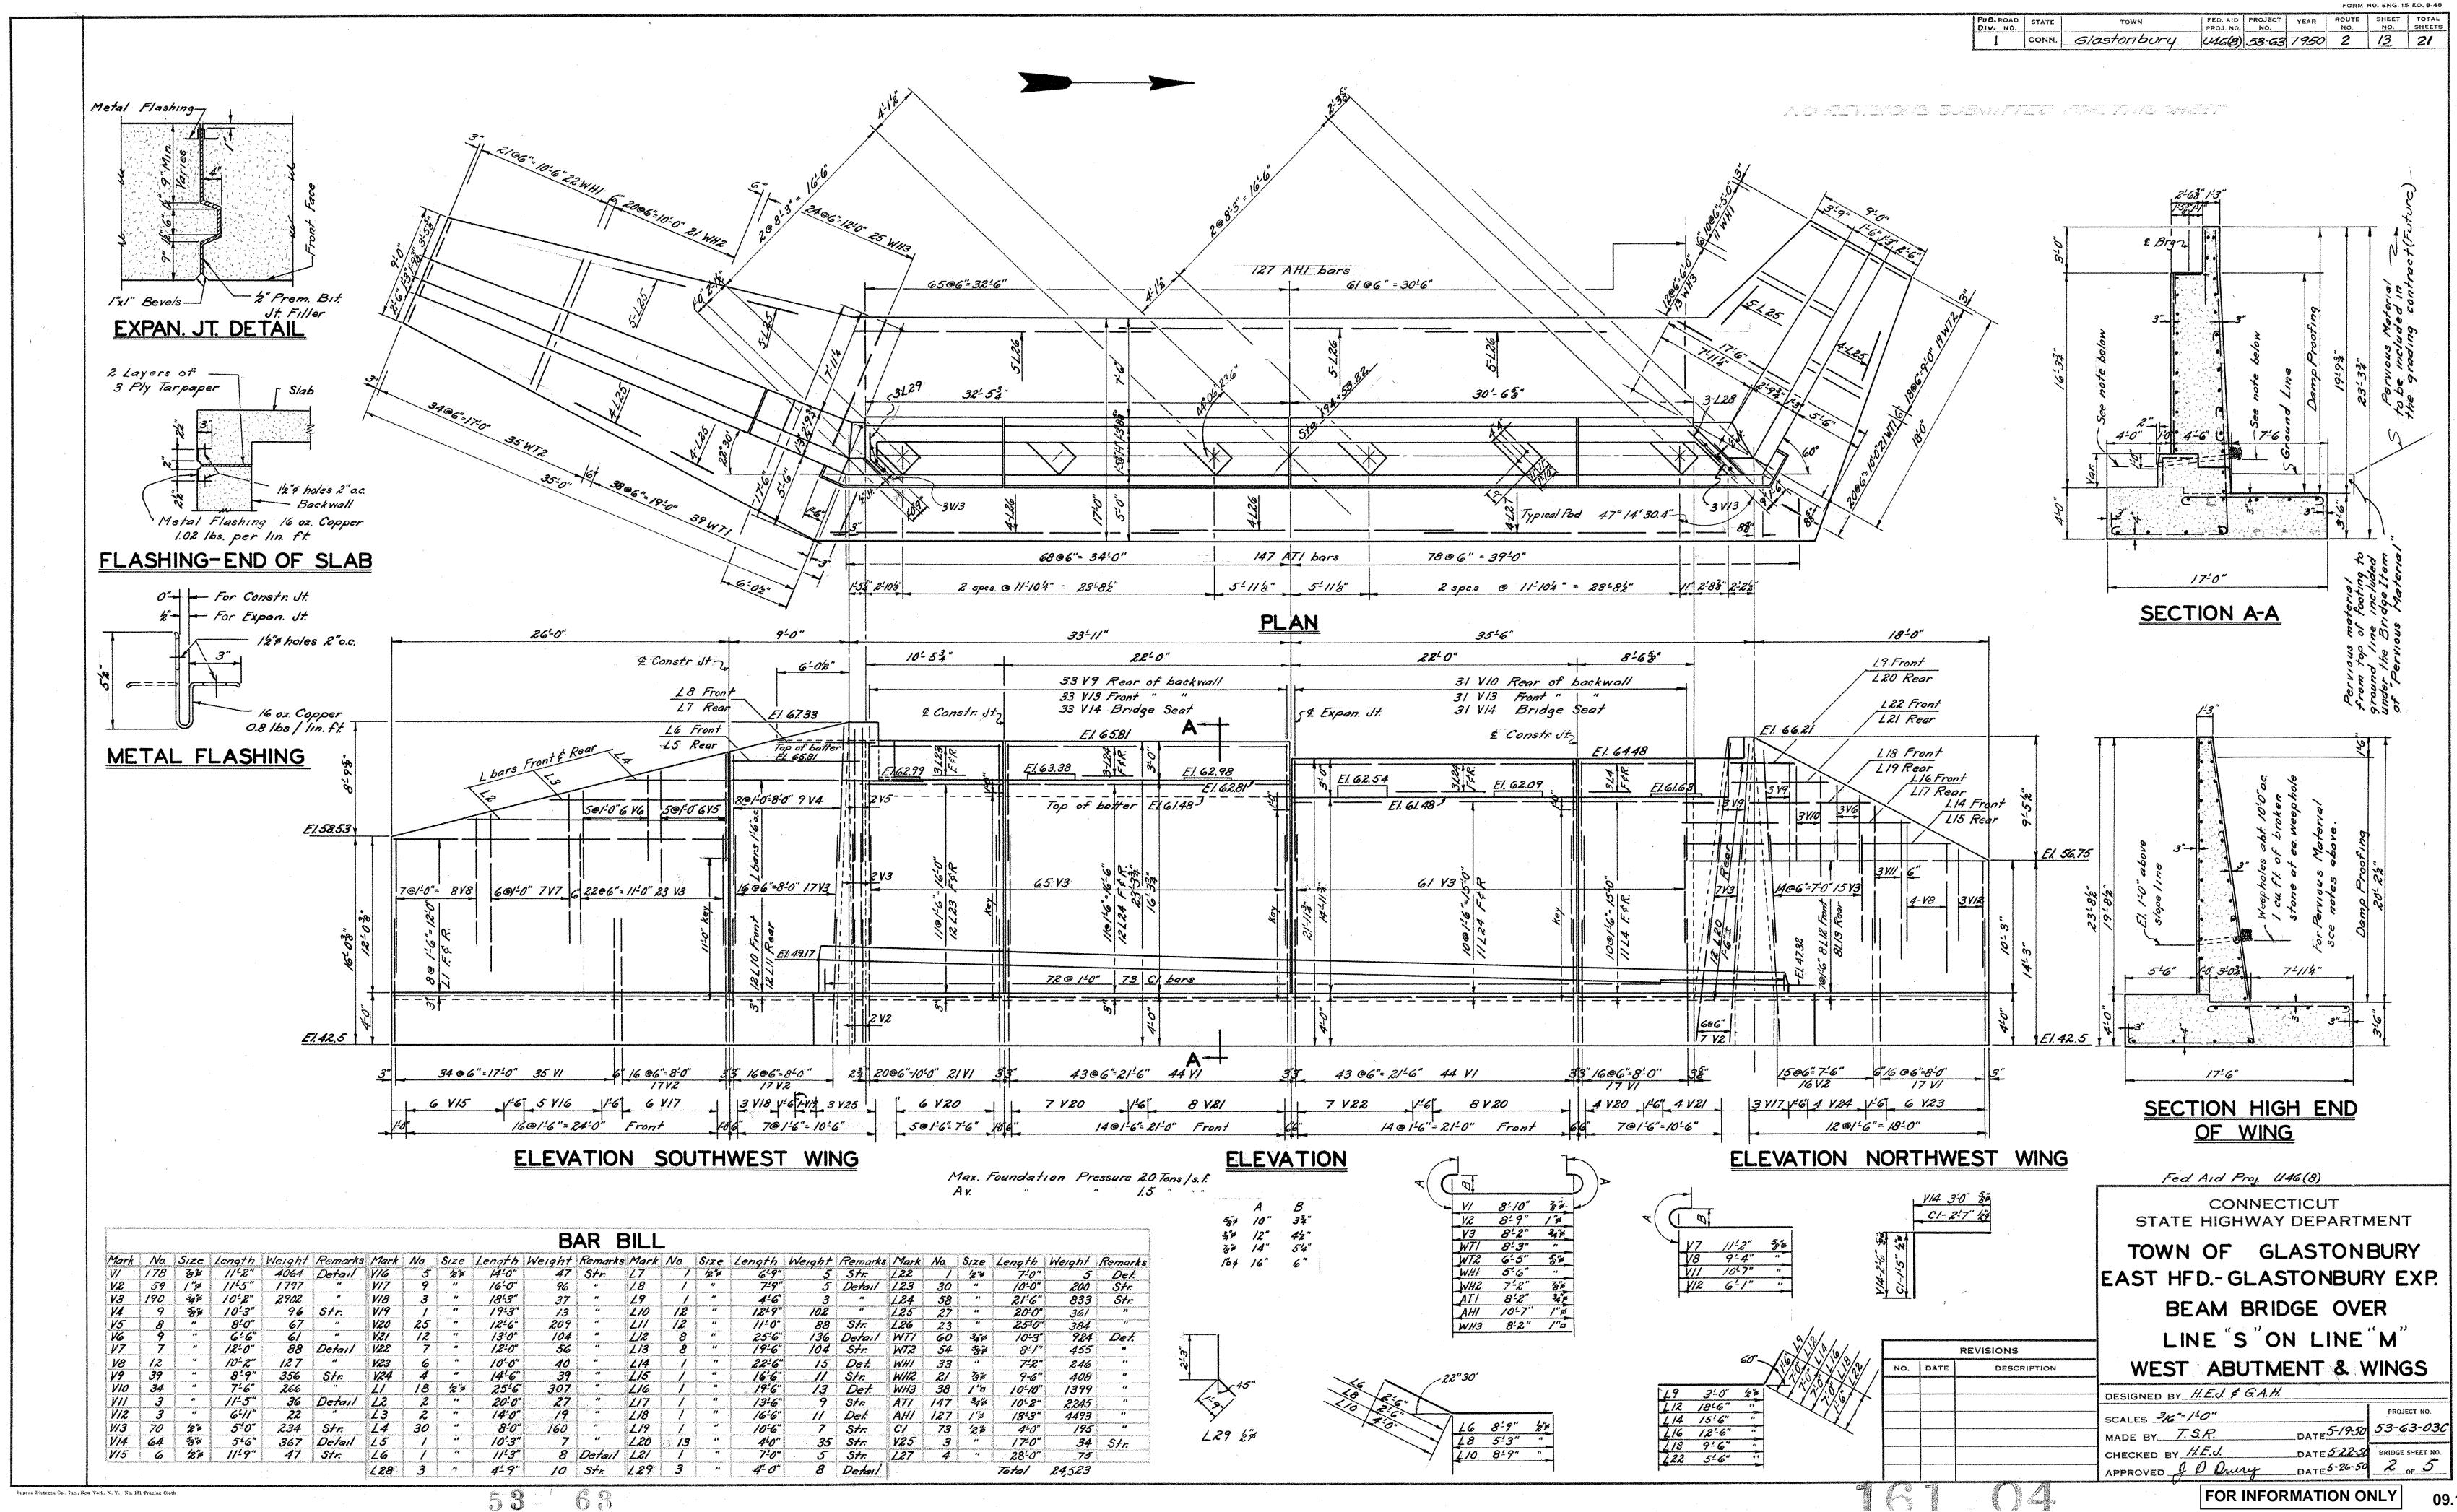


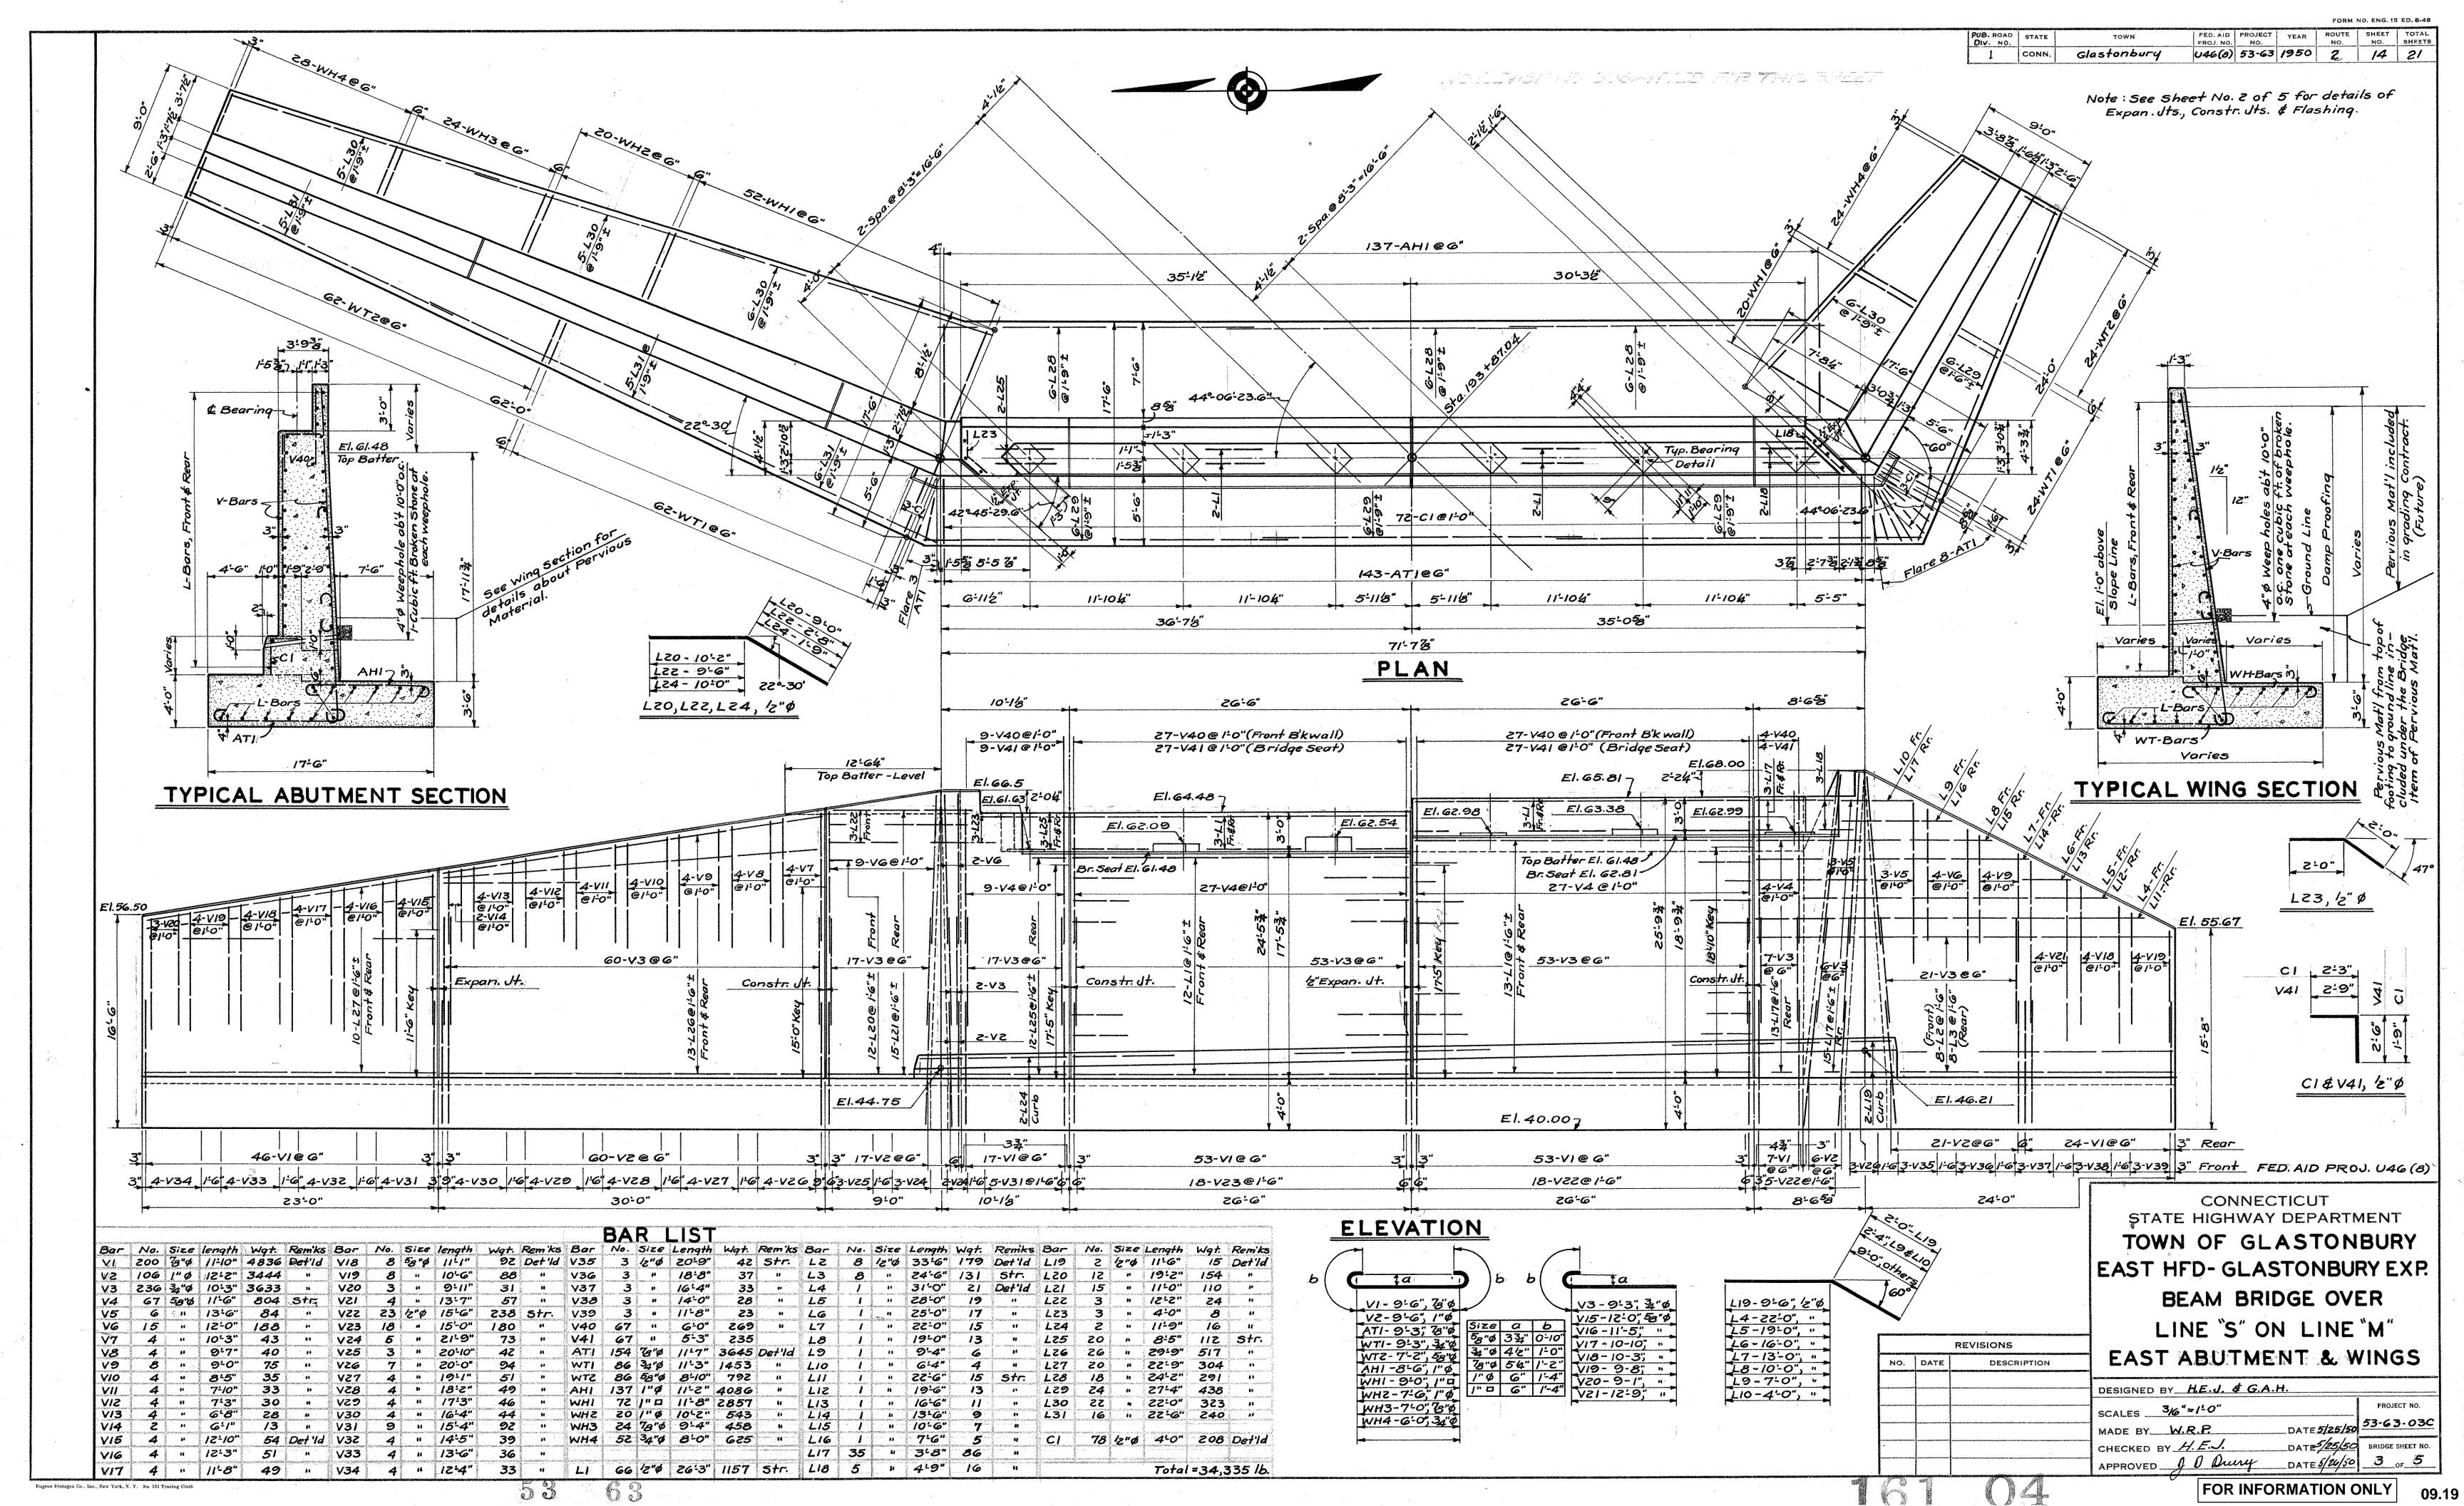


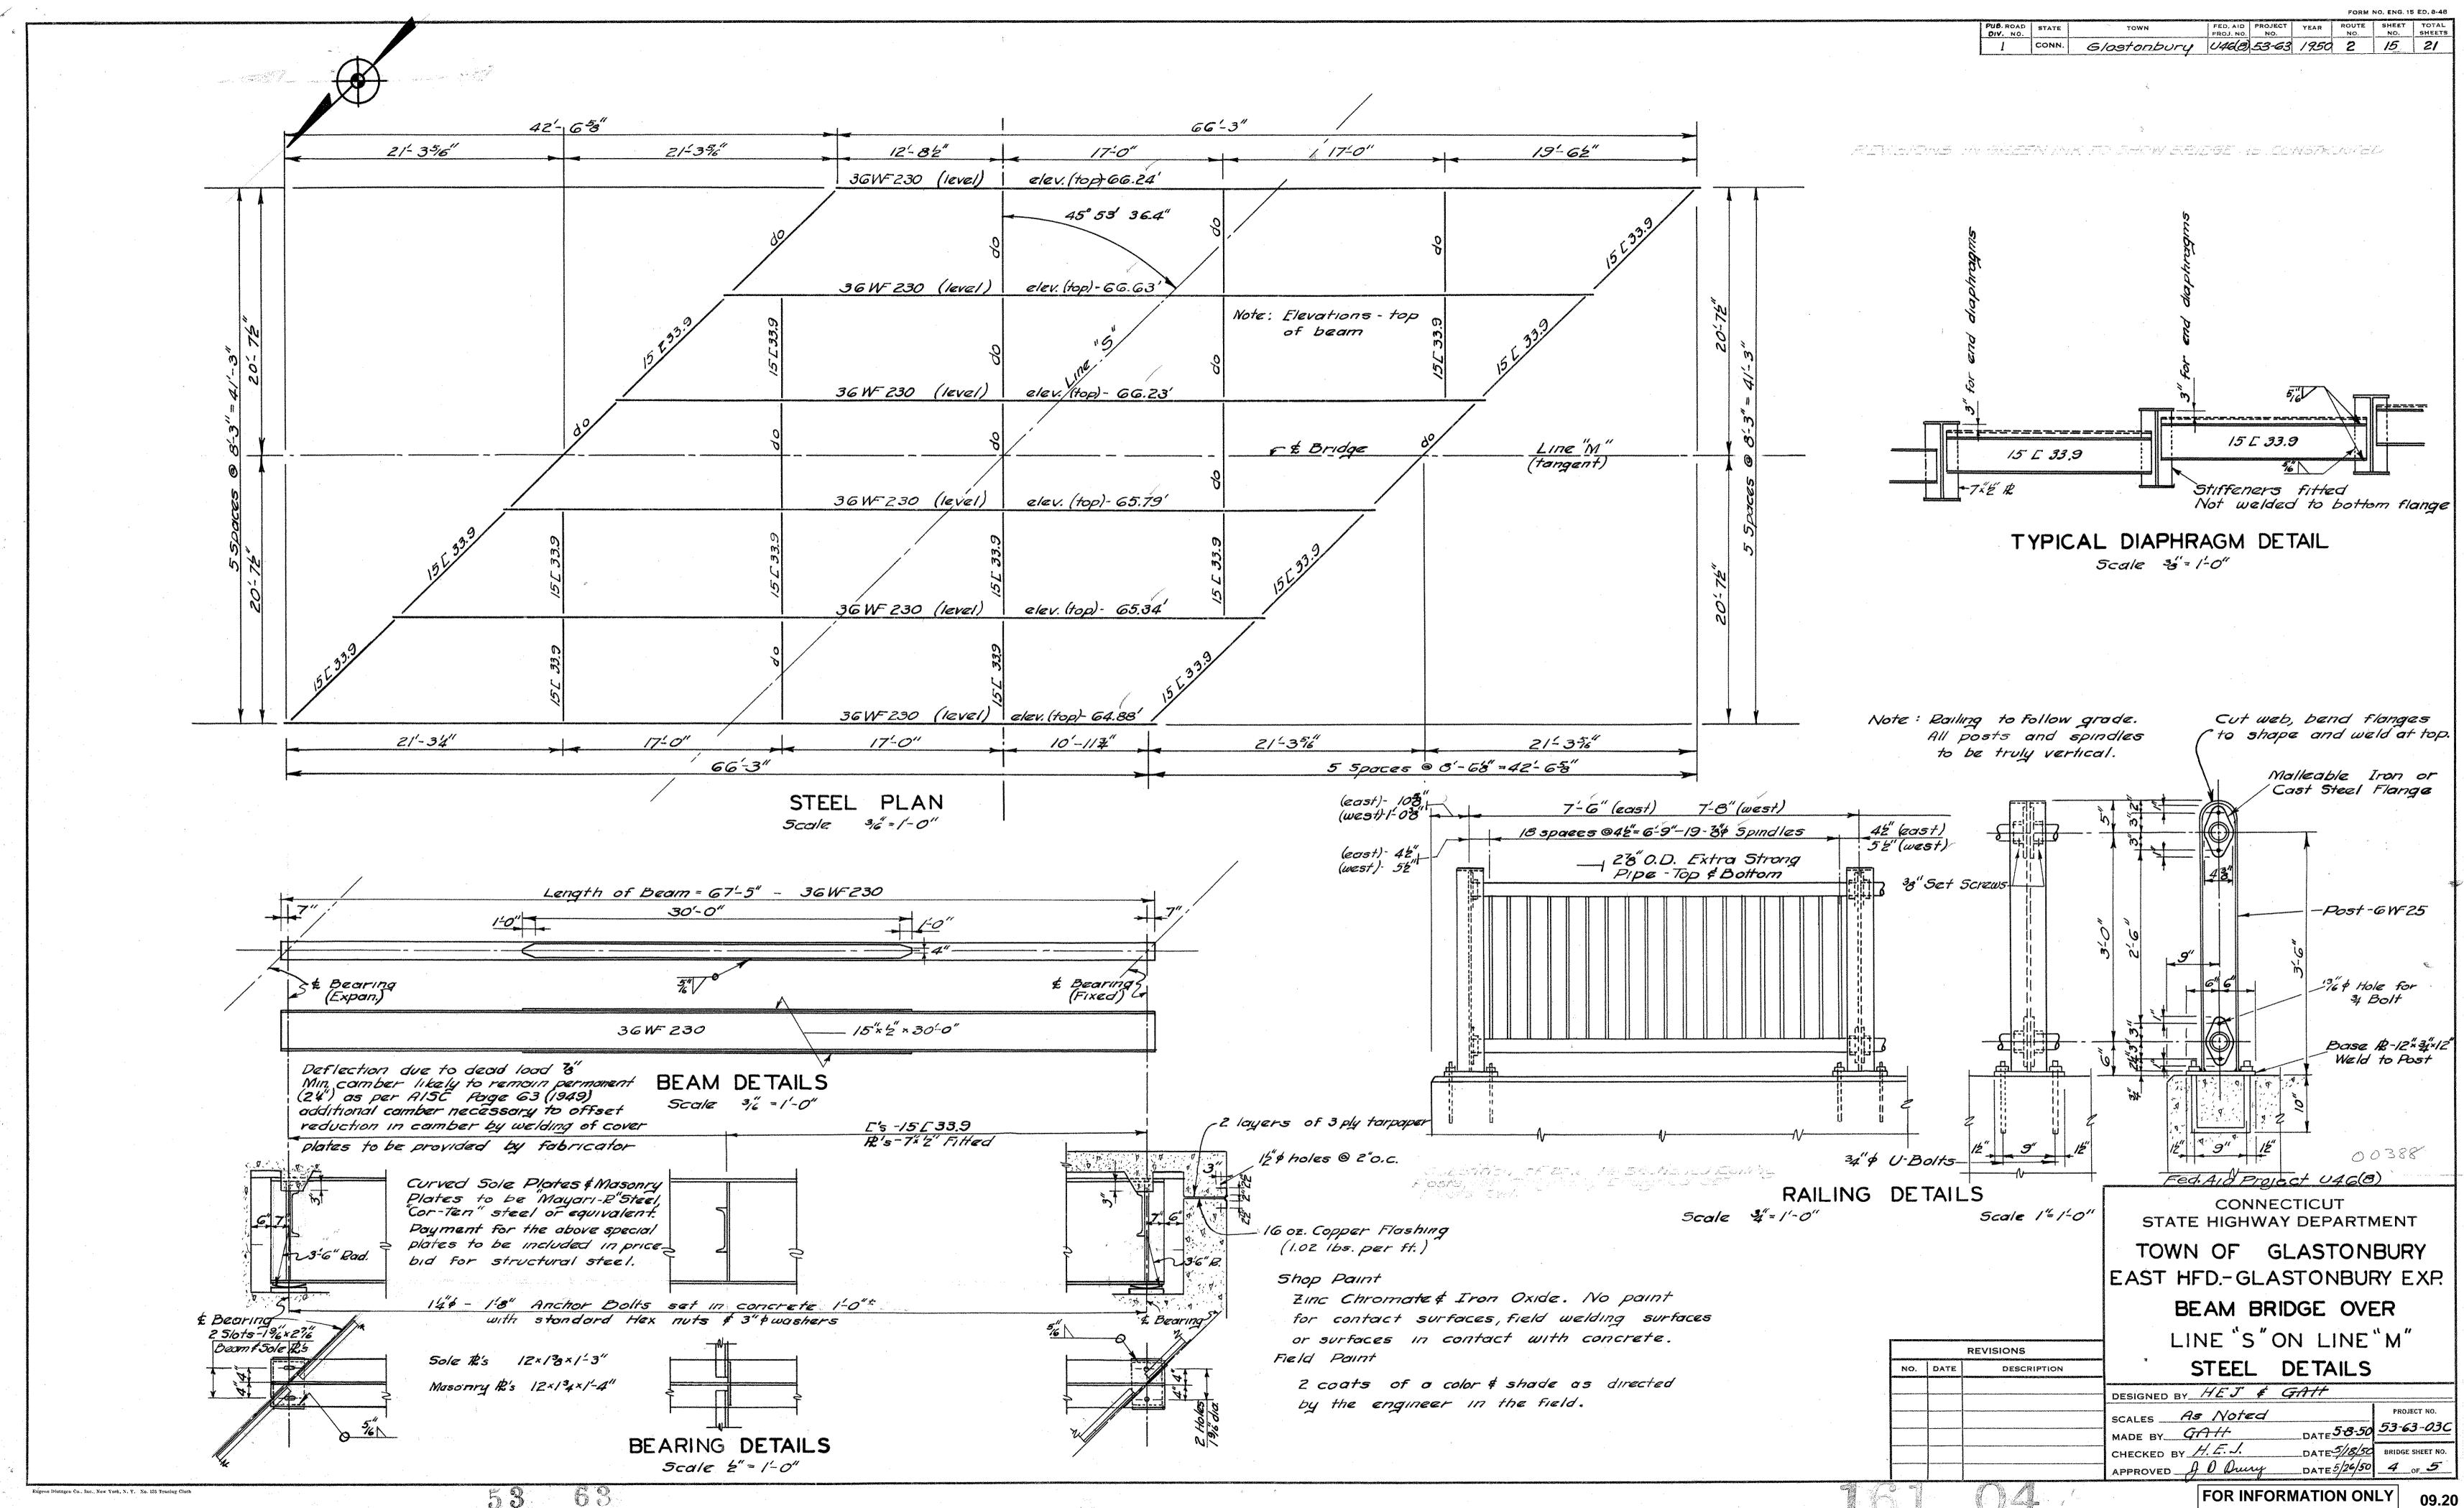


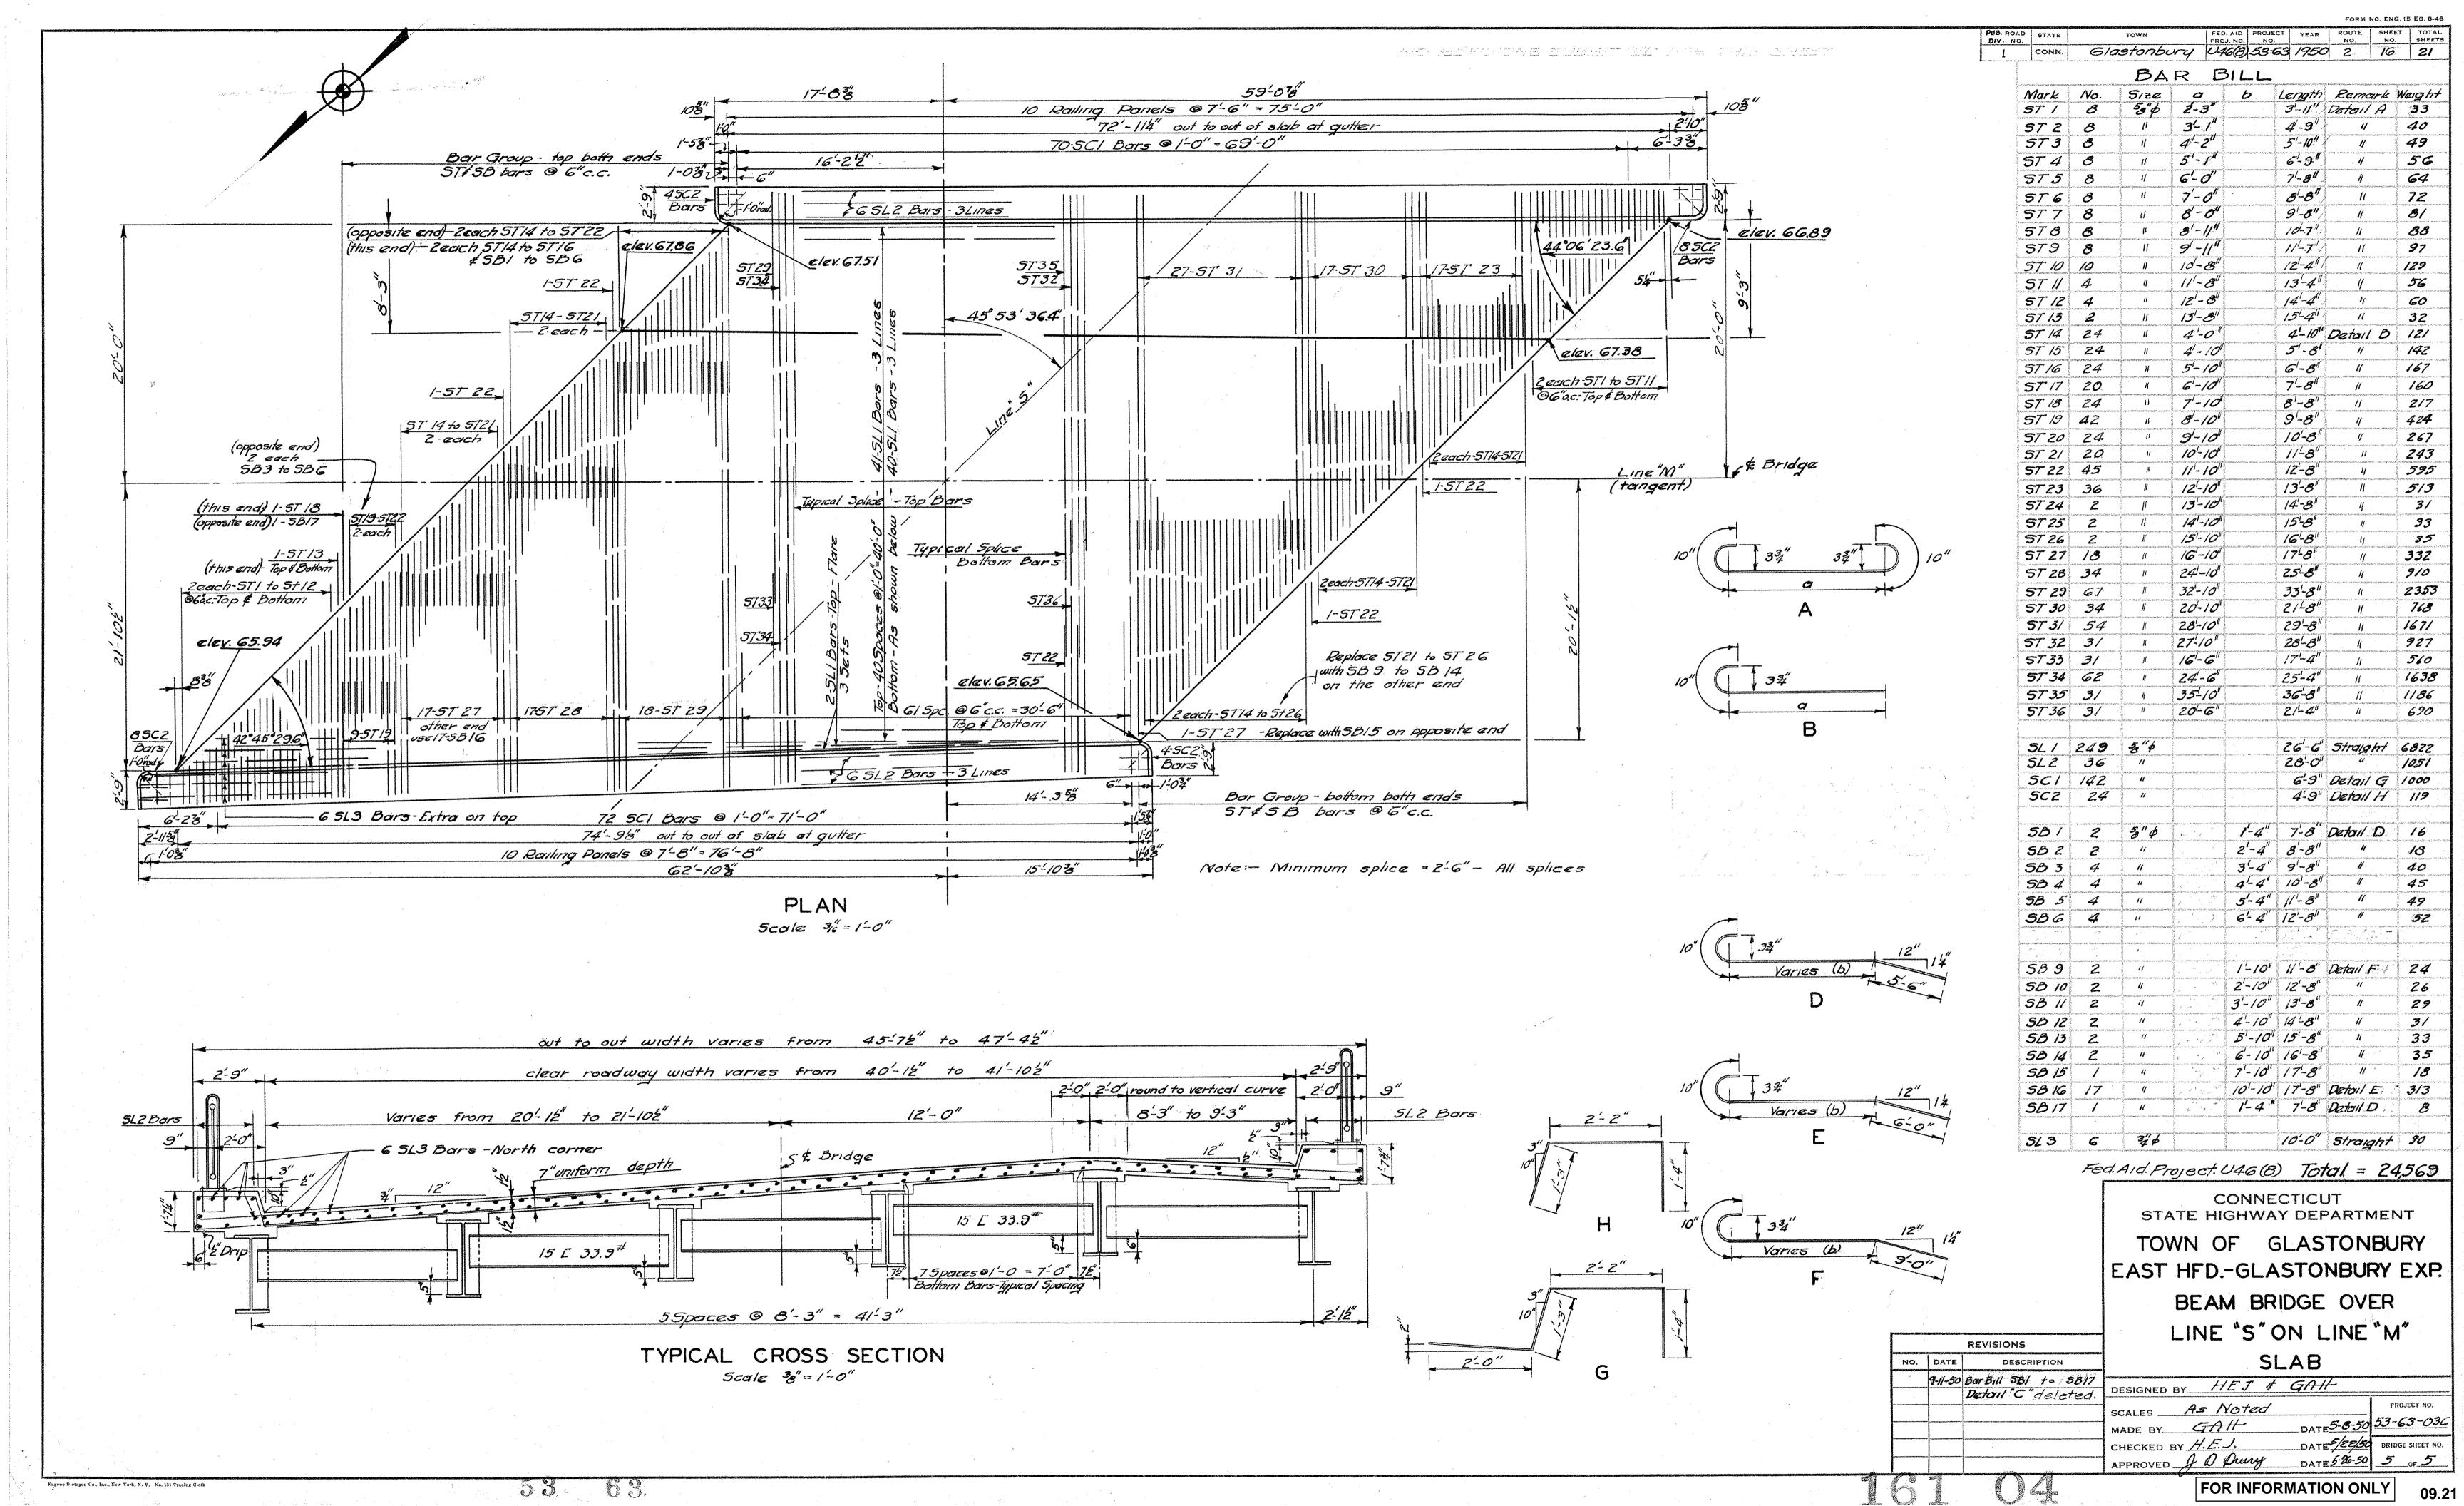


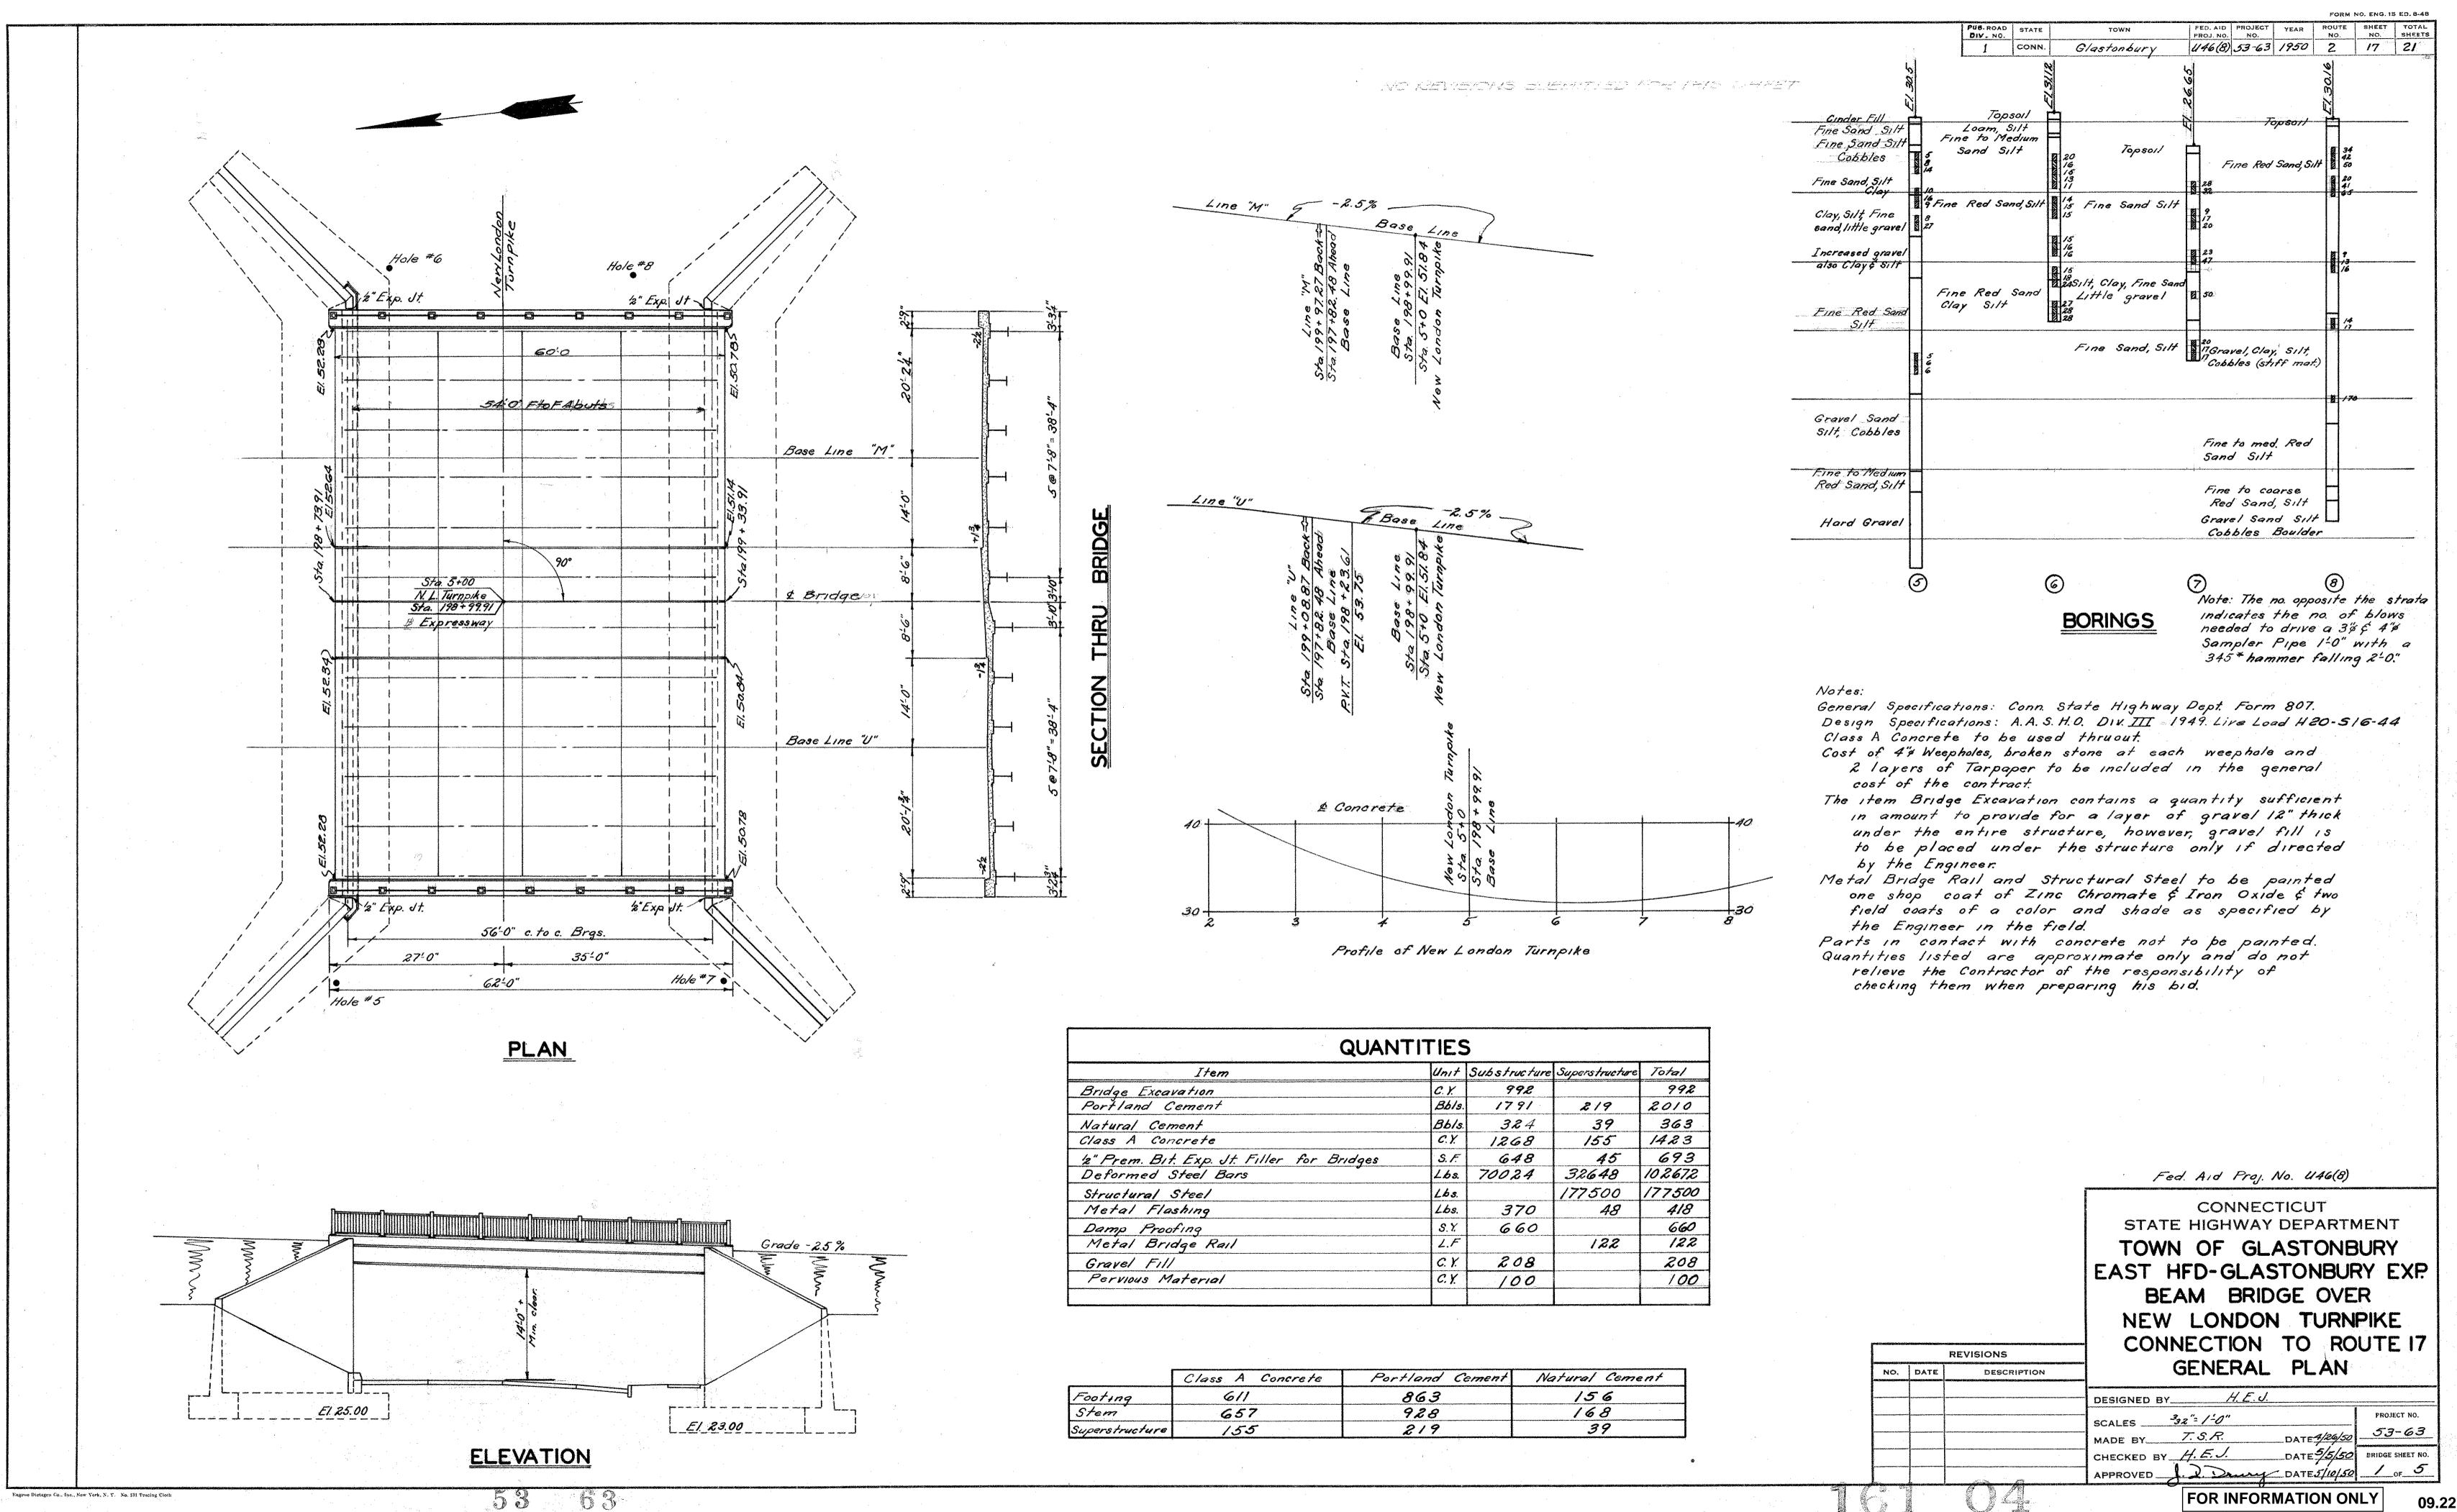

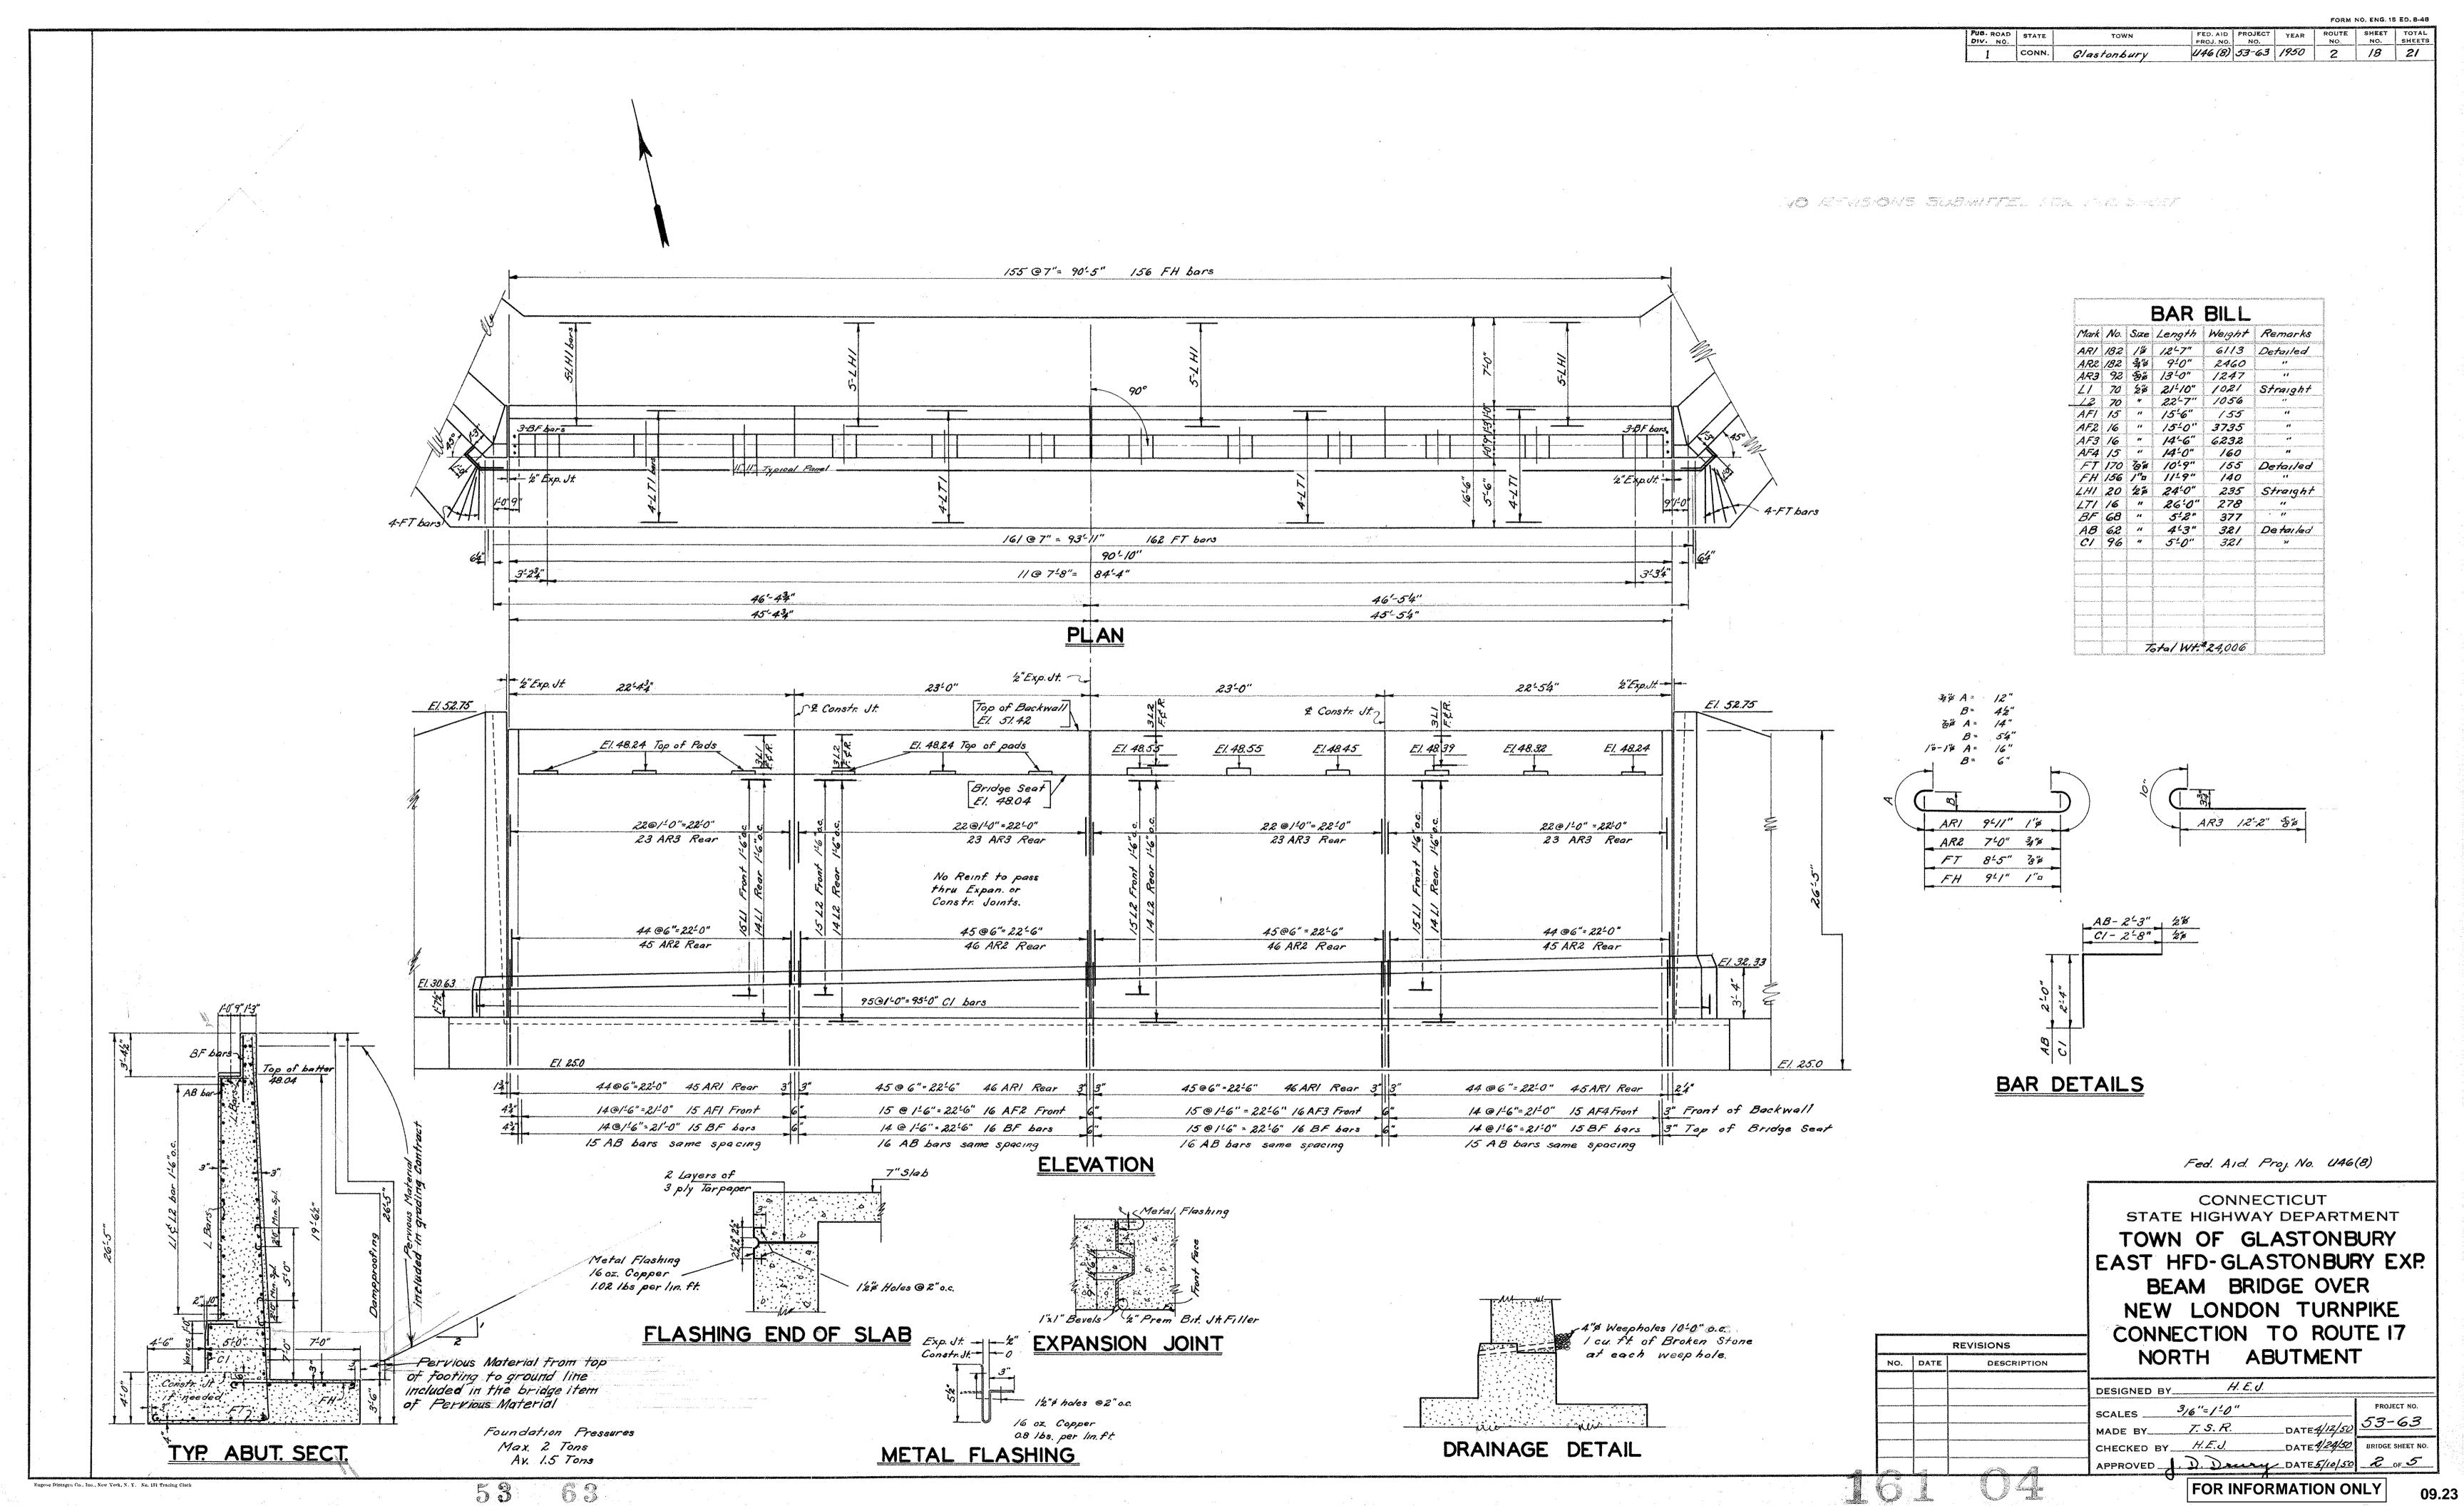

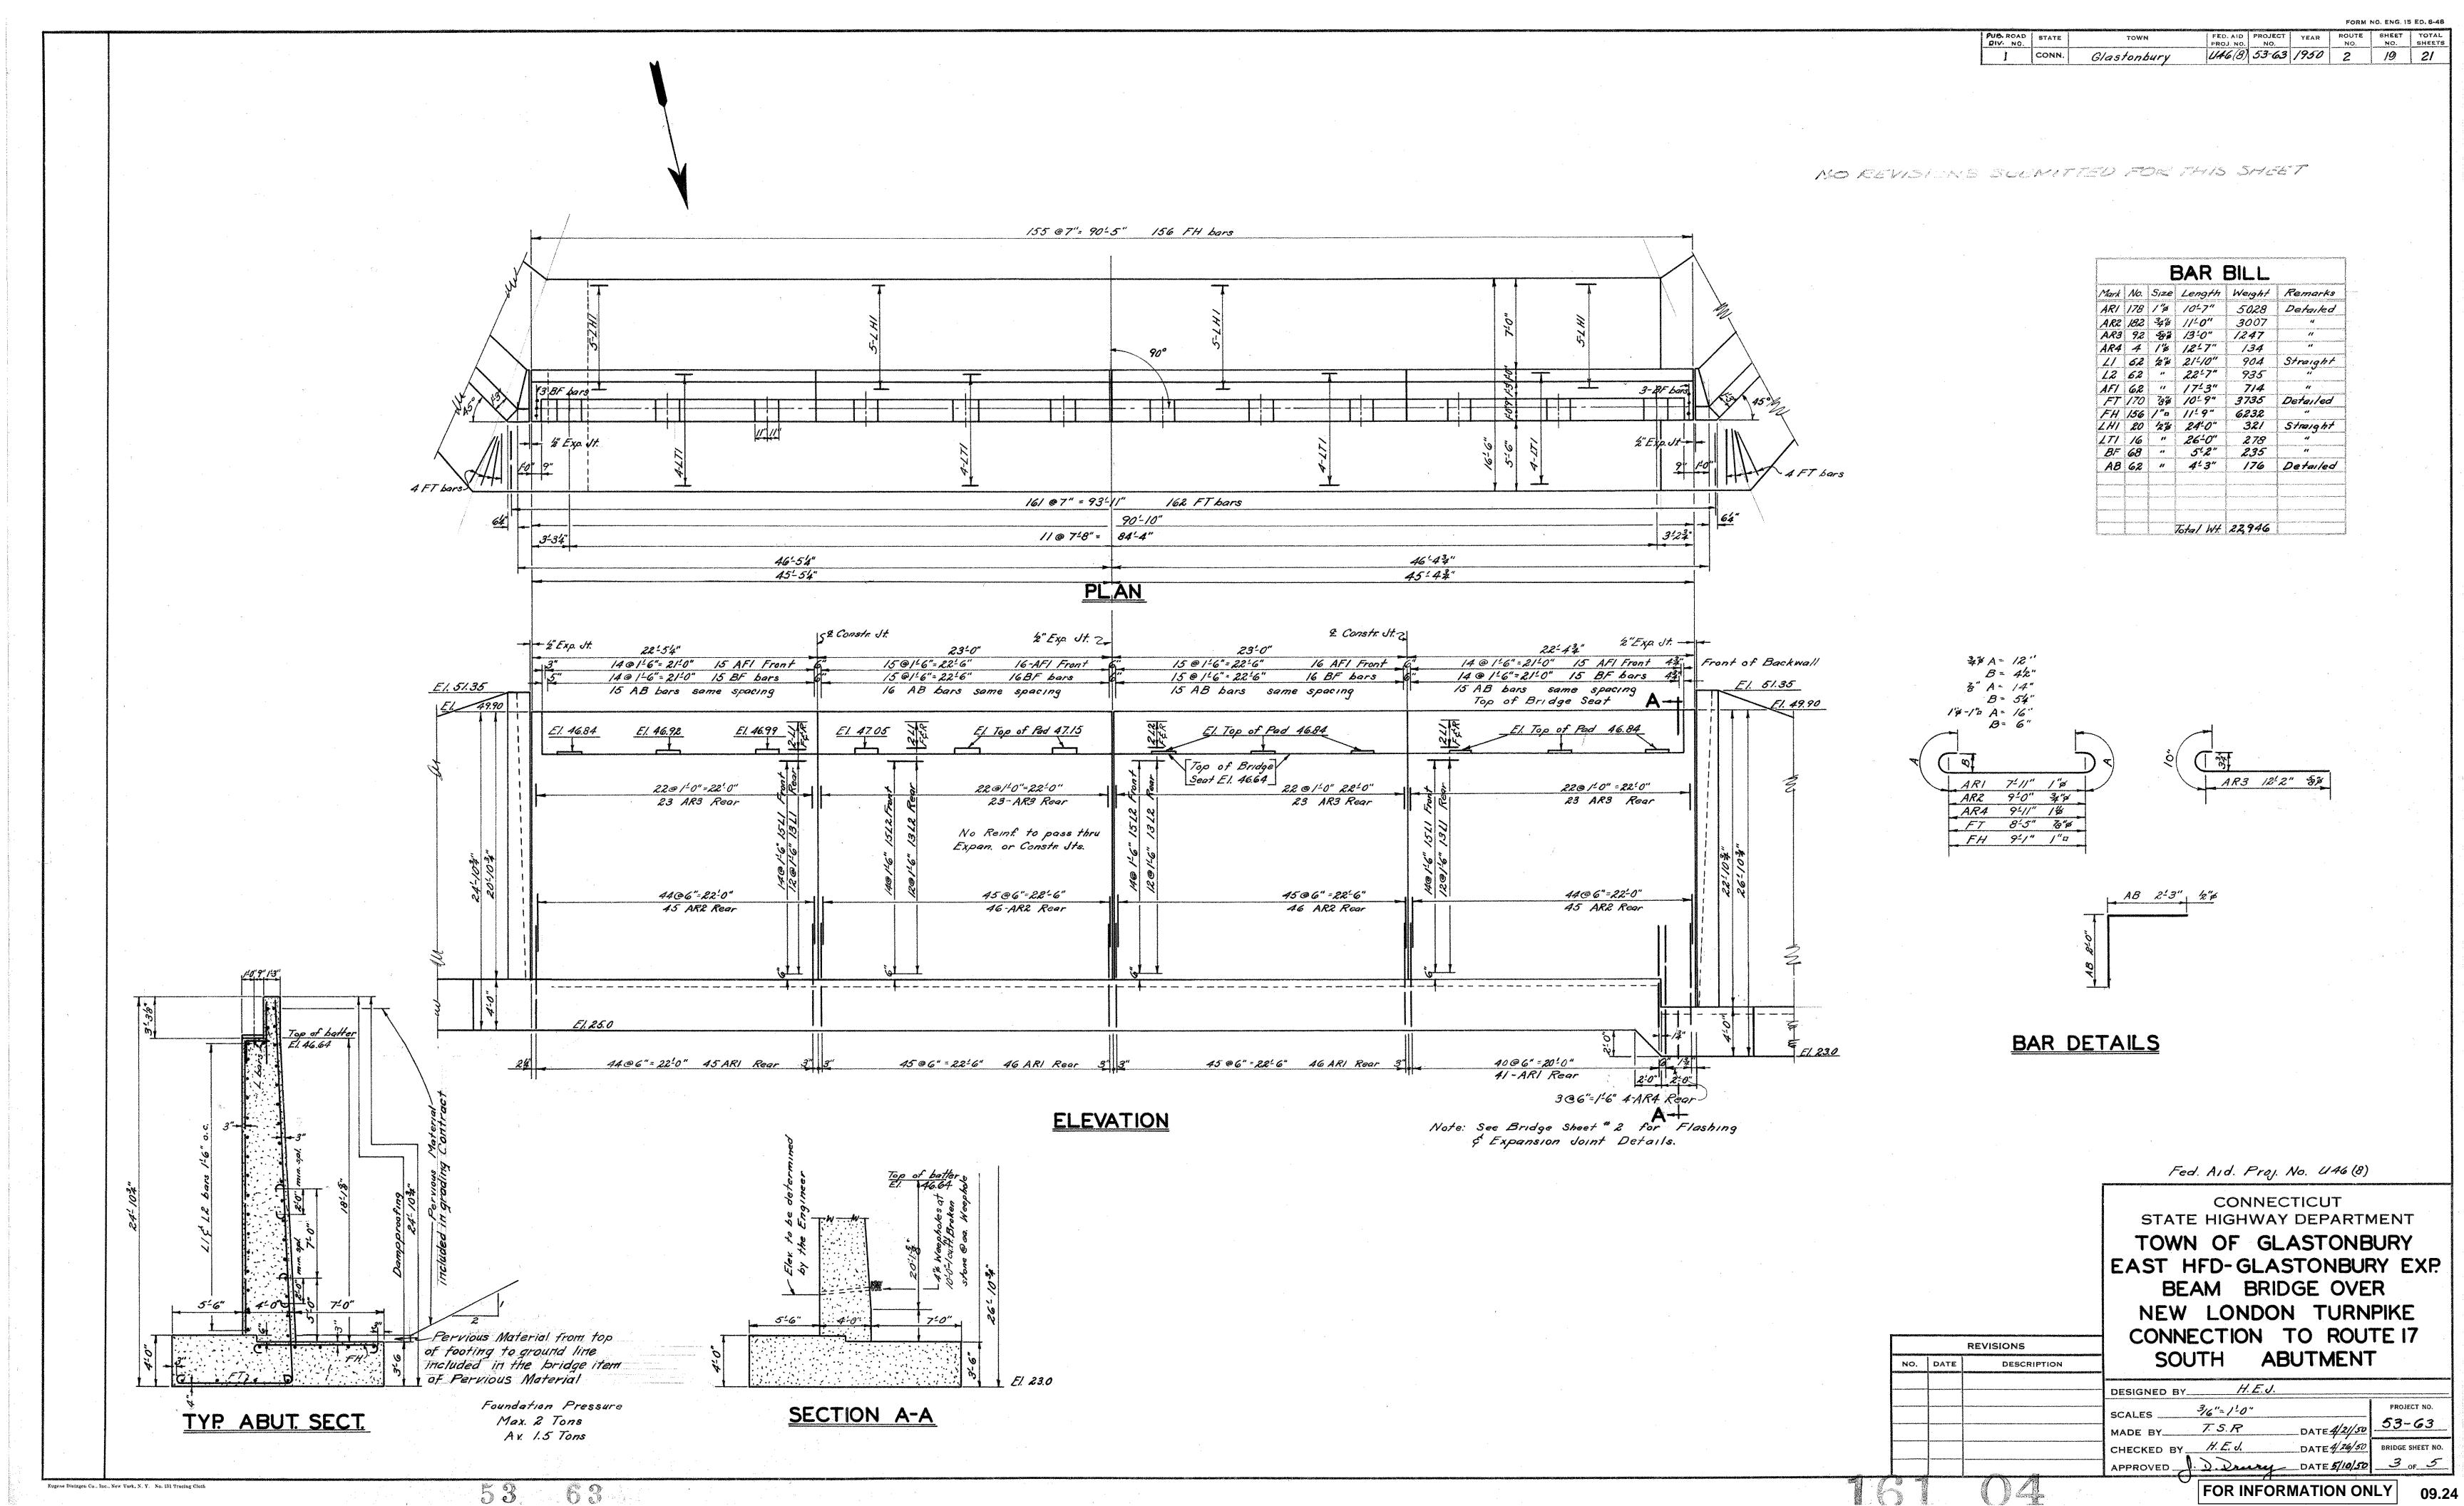

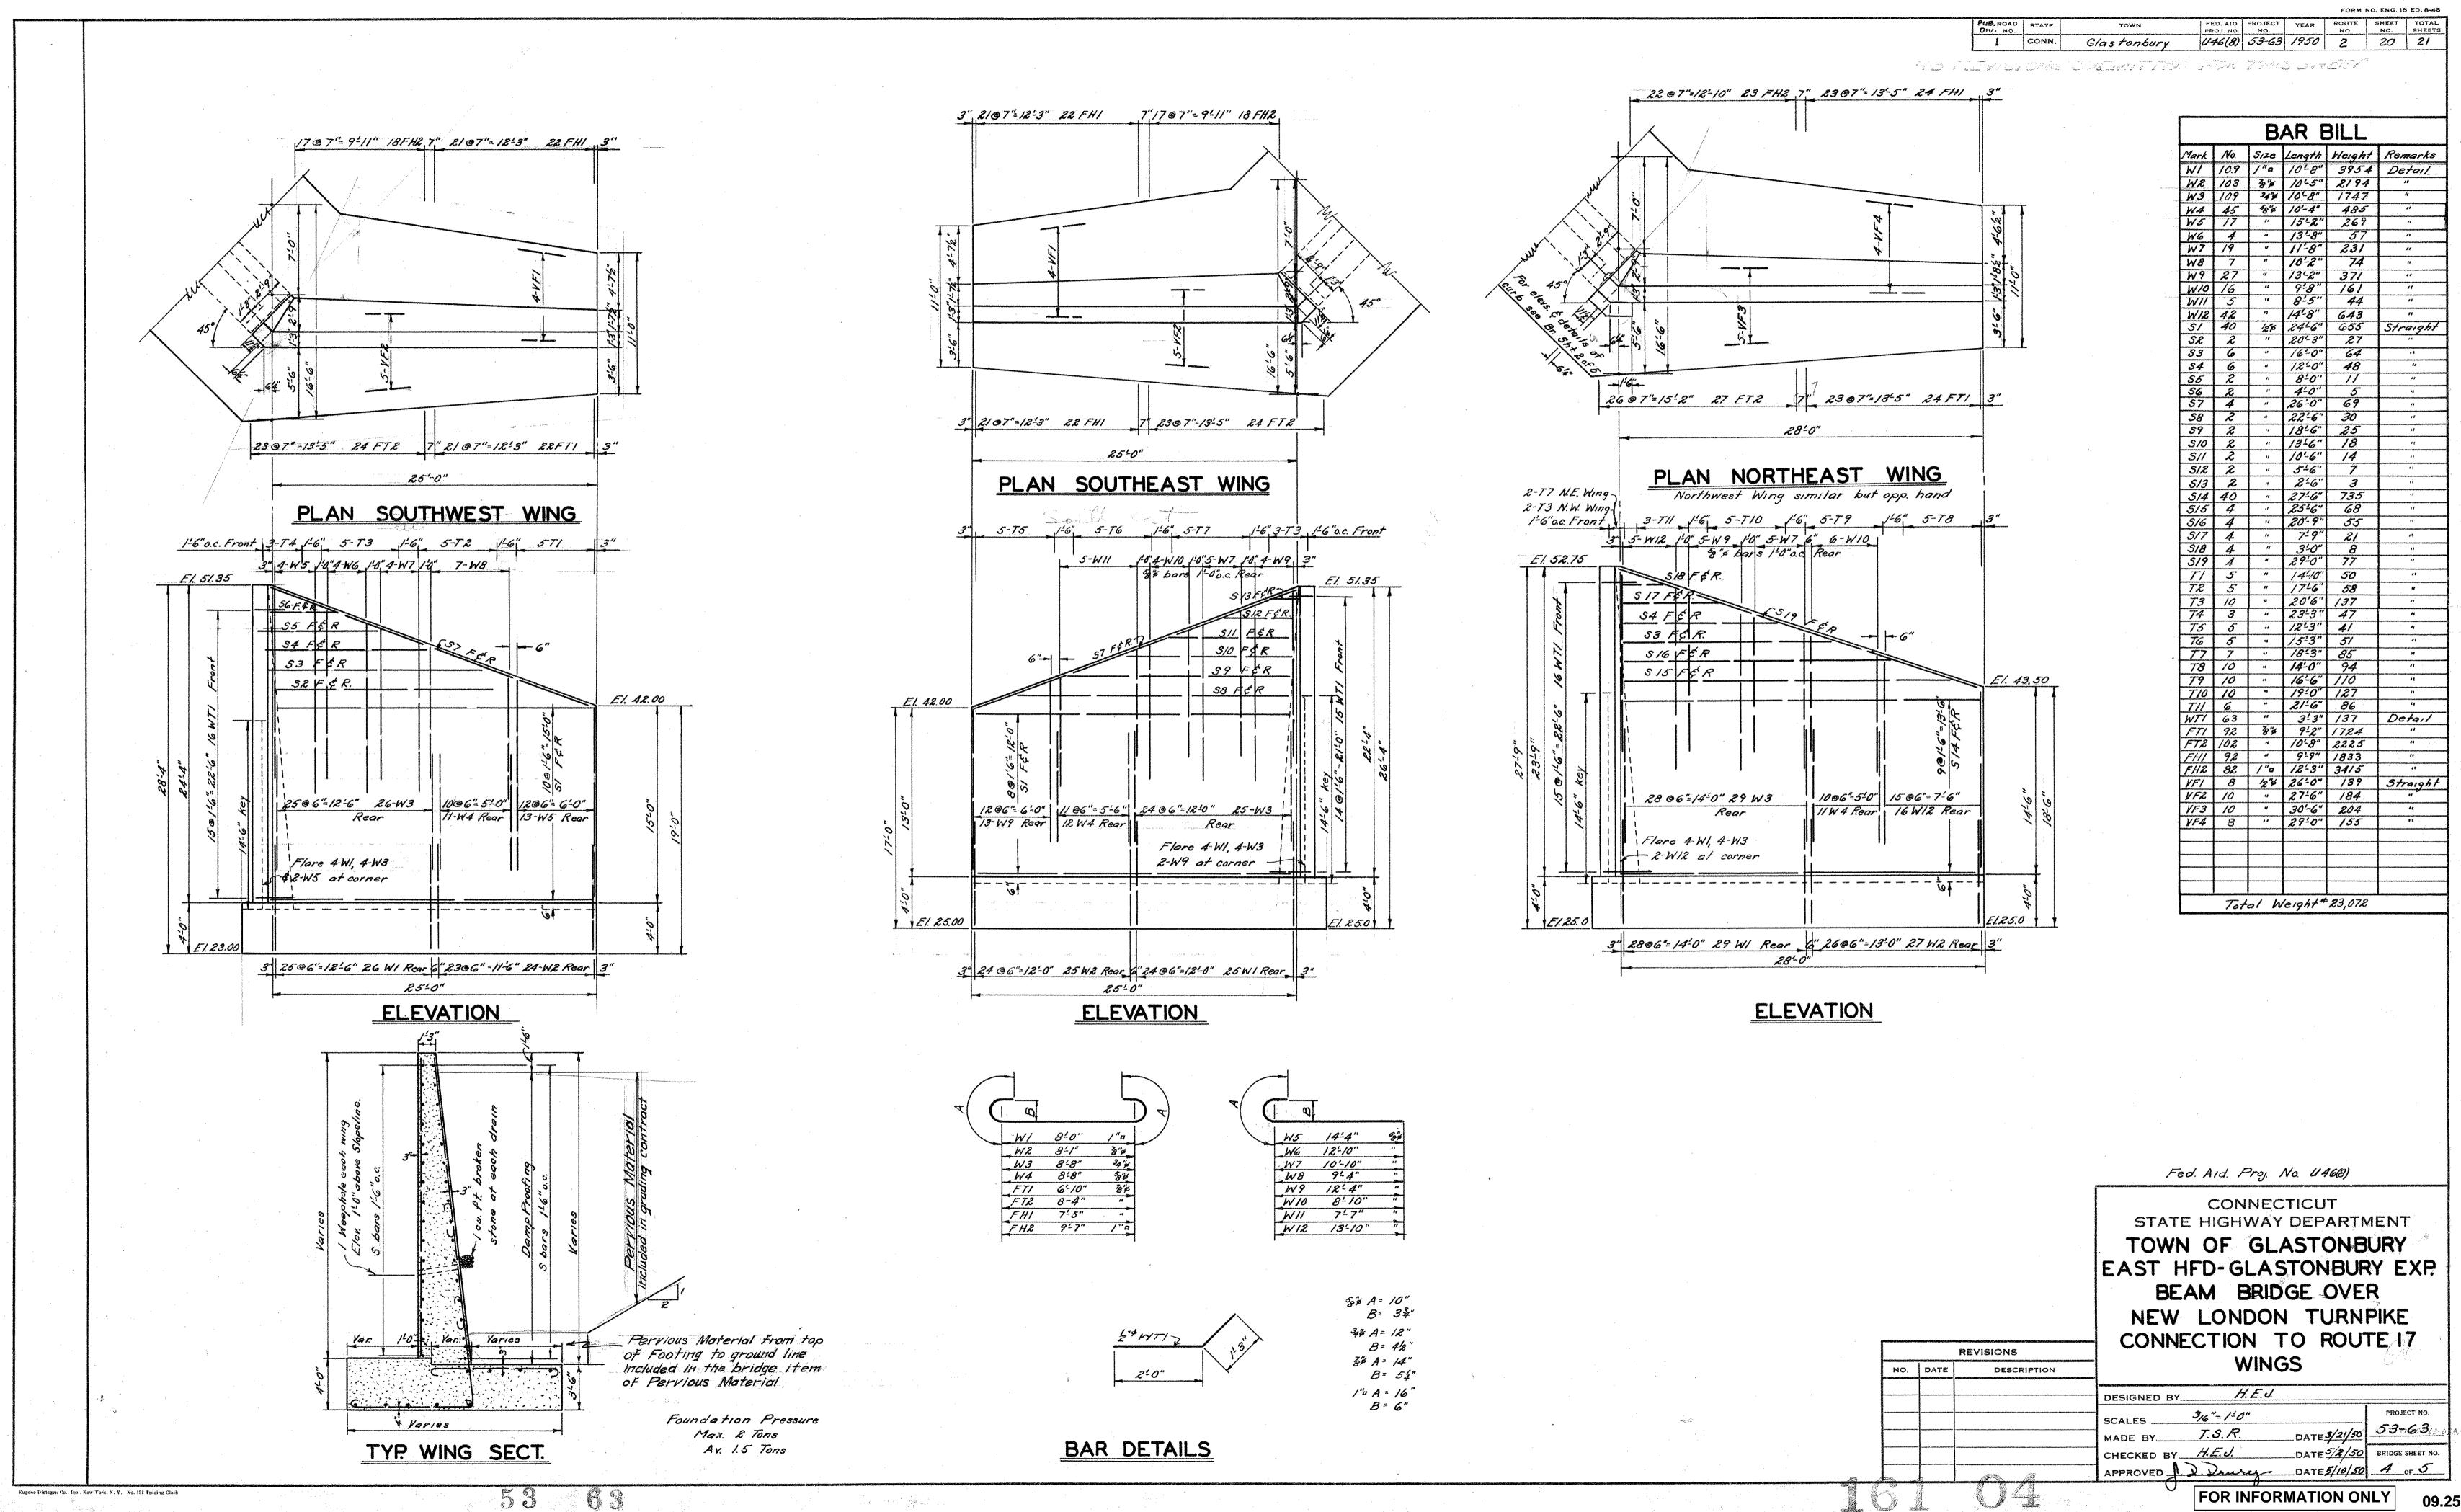

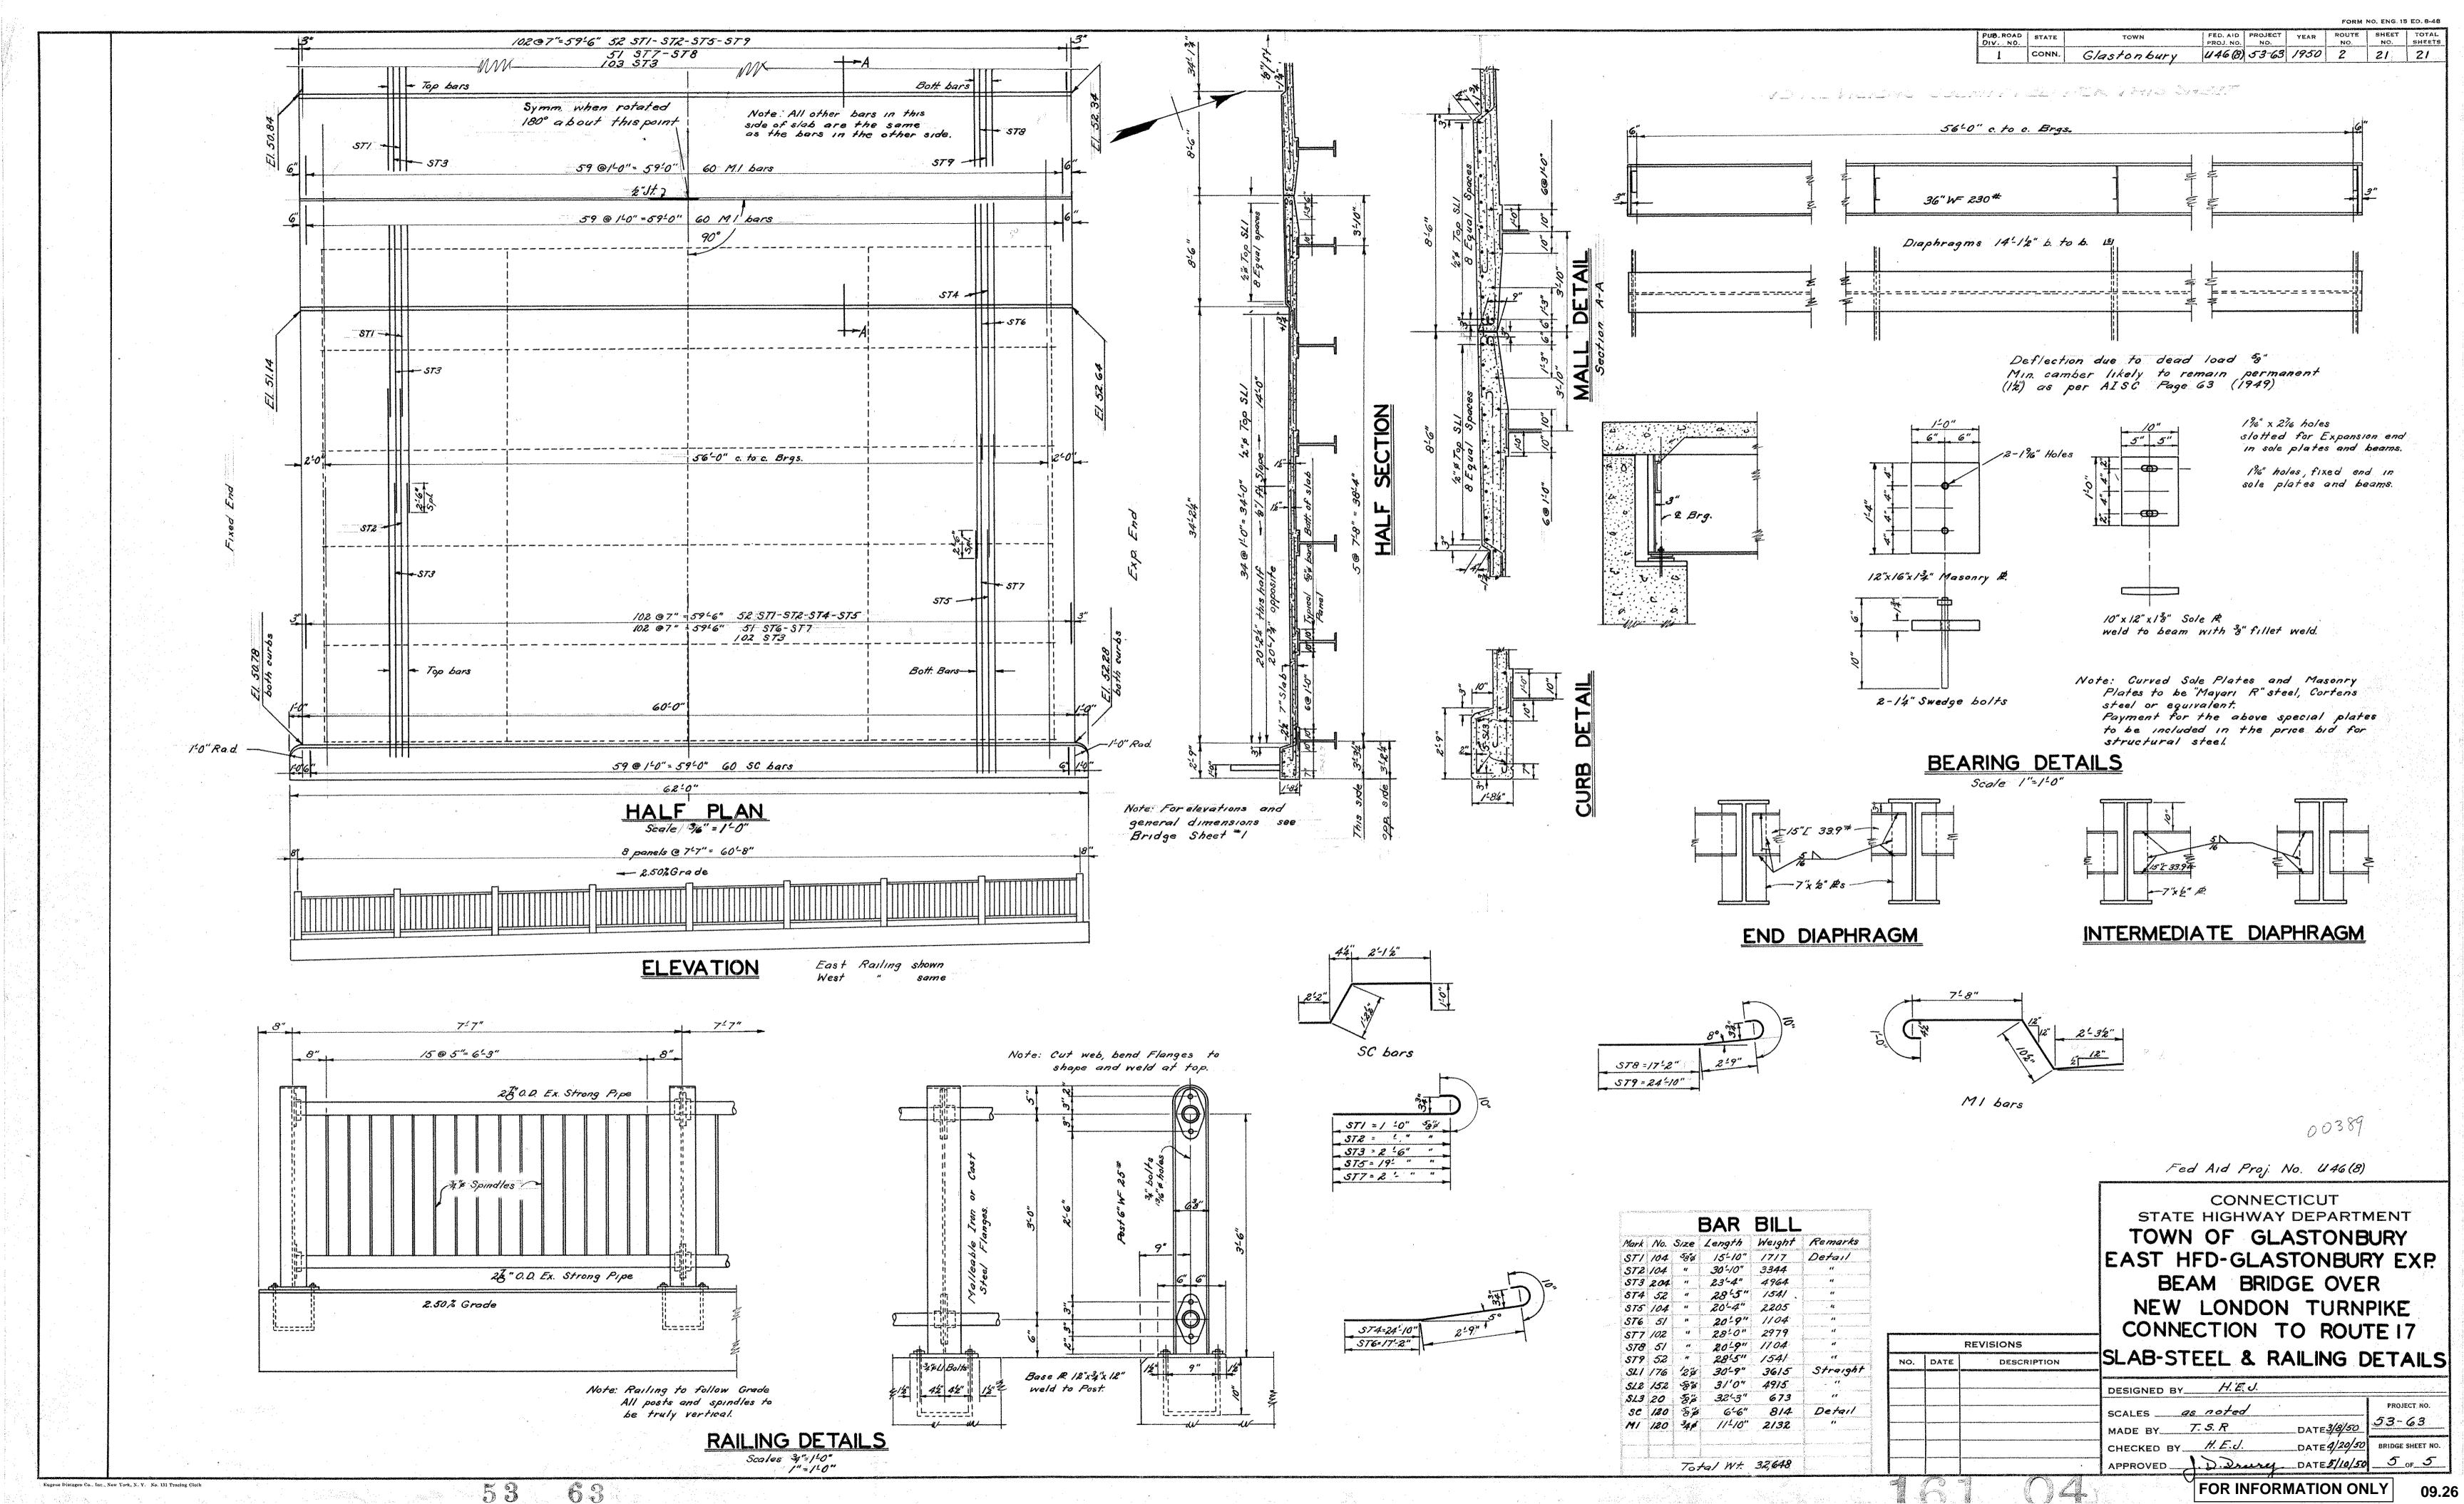

LOCATION PLAN SCALE : 1" = 1'000"

CONNECTICUT DEPARTMENT OF TRANSPORTATION

PLAN

NEW LONDON TURNPIKE ISLAND MODIFICATION

IN THE TOWN OF

GLASTONBURY


FROM STA. 22+15.00 TO STA. 36+70.00

LENGTH 1, 455.00 FT.

PROFILE HOR. 1 IN. = 40 FT. VERT. 1 IN. = 4 FT. CROSS SECTIONS 1 IN. = 5 FT.

OTHER SCALES AS NOTED TO BE MAINTAINED BY THE TOWN

	LIST OF	DRAW	VINGS	
SHEET NO.	TITLE	DRAWING NO.	STANDARD DRAWINGS	DATE
	TITLE SHEET	507-A	MANHOLE, FRAME AND COVER	9/10/90
2-3	DETAILED ESTIMATE SHEETS	507-H	PRECAST CONC. CATCH BASIN TYPE "C" OR"C-L"	12/3/90
4	TYPICAL ROADWAY DETAILS	507-I	TYPE "C" CATCH BASIN	12/3/90
		507 - K	CATCH BASIN FRAME AND GRATE	8/1/91
5	MISCELLANEOUS DETAILS	910 – A	METAL BEAM RAIL (TYPE R-B) & (TYPE MD-B)	3/16/79
6-8	40 SCALE PLAN / PROFILE SHEETS	911-F	END ANCHORAGE TYPE II, METAL BEAM RAIL	÷
9	PAVEMENT MARKING AND SIGNING		TYPES R-I, MD-I AND R-B	
10	TRAFFIC CONTROL SIGNAL	921-A	SIDEWALK AND DRIVES	9/18/91
11-18	CROSS SECTIONS (NEW LONDON TURNPIKE)	925-A	PAVEMENT FOR RAILING	9/18/91
19-23	CROSS SECTIONS (OFF RAMP)	930	OBJECT MARKER	8/1/91
24-27	CROSS SECTIONS (OAK STREET)			
28-38	SIGNAL AND PAVEMENT MARKING DETAILS			
AI - A3	SOUTHERN NEW ENGLAND TELEPHONE CO.		·	*
BI-£3	CONNECTICUT NATURAL GAS CO.			
		`		
				,2

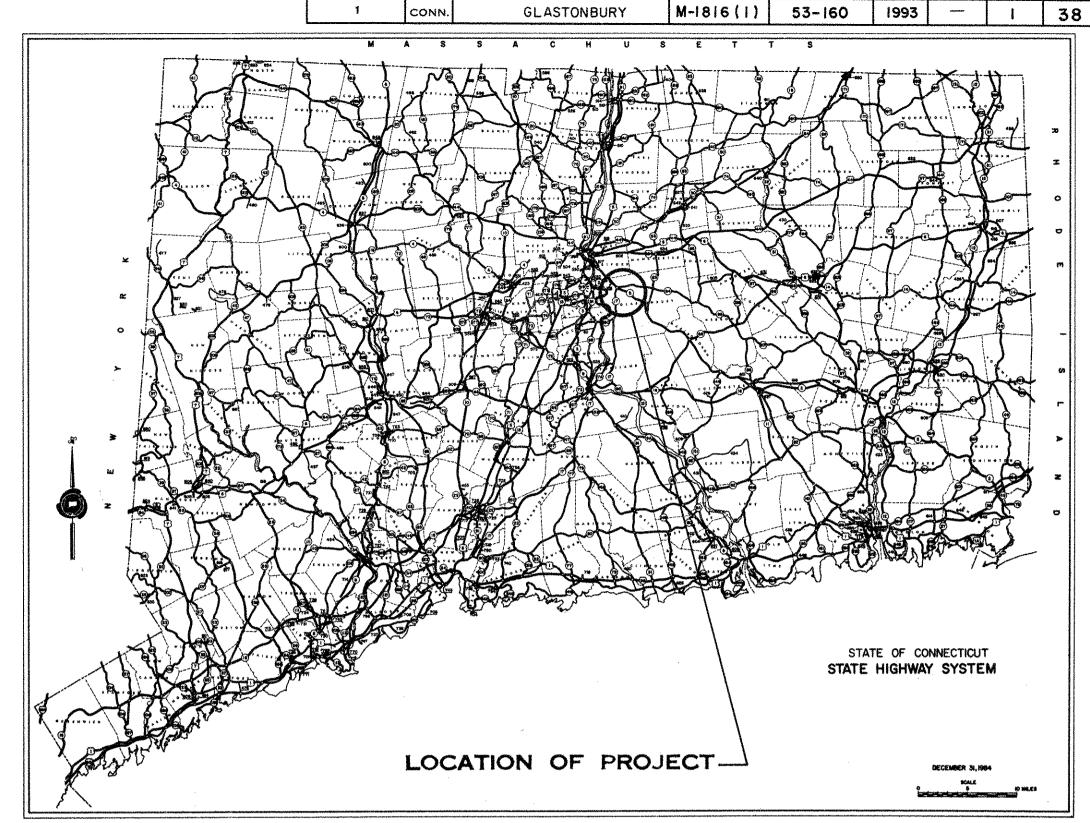

1988 SPECIFICATIONS, FORM NO. 814 INCLUDING SUPPLEMENT THERETO DATED JULY, 1993 GOVERN ALL ELEVATIONS ON THIS PROJECT ARE BASED ON NATIONAL GEODETIC VERTICAL DATUM OF 1929. (MEAN SEA LEVEL)

TOWN NO. 53 PROJECT NO. 160

I. THESE PLANS HAVE BEEN PREPARED BY MAGUIRE GROUP INC. EXCEPT FOR PLANS DESIGNATED AS "UTILITY PLANS", "STANDARD DRAWINGS" AND SHEET NO'S. AI-A2 AND BI WHICH PLANS HAVE BEEN PREPARED BY OTHERS. THE UNDERSIGNED HEREBY DISCLAIMS ALL RESPONSIBILITY FOR THE ACCURACY OF DATA SHOWN ON THE ABOVE MENTIONED PLANS, EXCEPT THAT HE HAS REVIEWED THEM FOR GENERAL COORDINATION WITH PLANS PREPARED BY HIM.

CONSTRUCTION STARTED 4-19-94

CUNSTRUCTION COMPLETED 4-28-95



DESIGNED BY :

MAGUIRE GROUP CT. INC.

RECOMMENDED Jugust 4 1993

53-160

STANDARD CONVENTIONS

Board Fence

Grape Arbor

Retaining Wall

Open Ditch

Telegraph Telephane or Electric Light Poles

Guide Rail

到的和田田田三田三田三田三田

Ledge or Rock \hat{x}

Decidue Evere Hydrant ous Trees greens

ivers, Lakes, Flowing

House

Gas Pump

Swamp

D.O.T. Mon.

Existing C.8.

Proposed C.B.

Random Stone

Bit. Conc. Lip Curb

Curb stated whether

Stone or Conc.

and the second s

Stone Wall

Concrete Wolk

APPROXIMATE AND ASSESSED ASSES

Walk - Tar, Gravel or

Name of Co.
Existing RR, Tracks

Proposed R.R. Tracks

Taking Line

Taking Line NA or NA Line

Easement Line

Property Line

621-02

FOR INFORMATION ONLY

