THE COMMONWEALTH OF MASSACHUSETTS DEPARTMENT OF CONSERVATION AND RECREATION



LANDRY PARK SITE IMPROVEMENTS

LANDRY PARK WALTHAM, MASSACHUSETTS MIDDLESEX COUNTY


DCR CONTRACT NO. P25-3586-C11A

MAURA HEALEY, GOVERNOR KIM DRISCOLL, LT. GOVERNOR REBECCA TEPPER, SECRETARY, ENERGY & ENVIRONMENTAL AFFAIRS BRIAN ARRIGO, COMMISSIONER




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REGIONAL LOCUS MAP

SCALE: 1" = 2000'

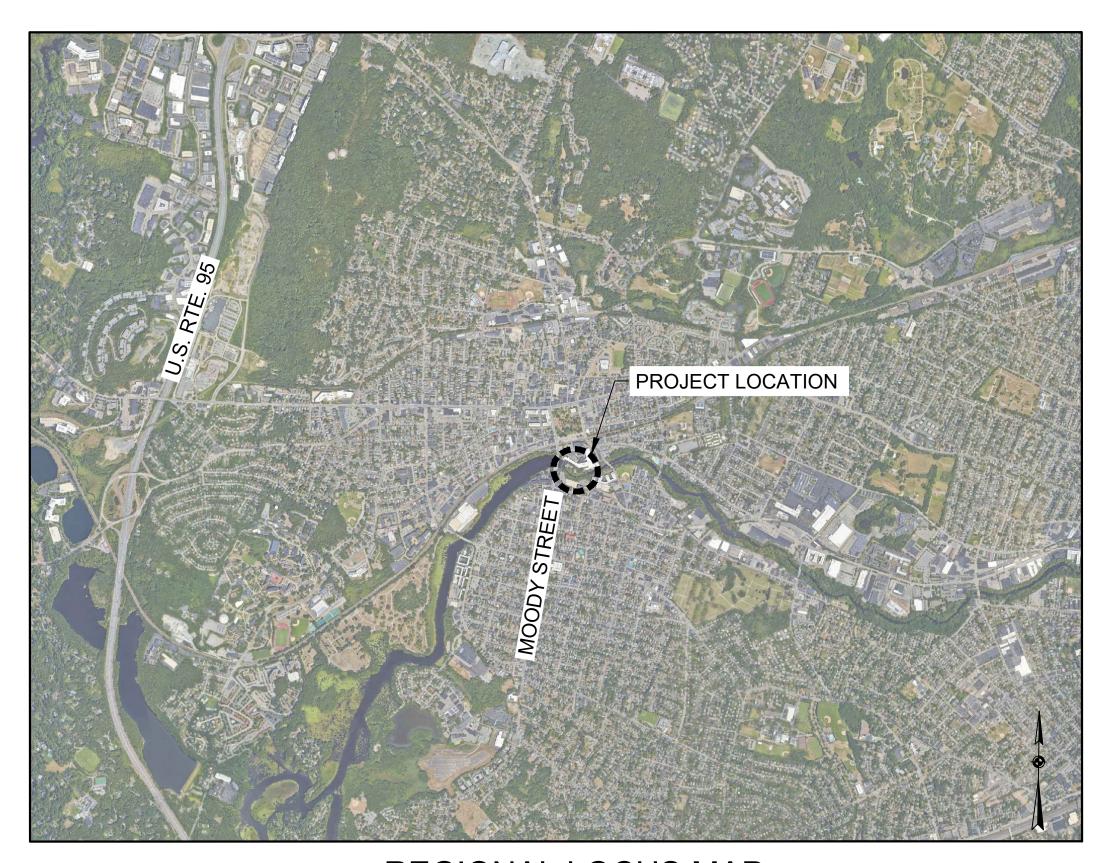

LOCUS MAP
SCALE: 1" = 200'

PRECISION LAND SURVEYING, INC.
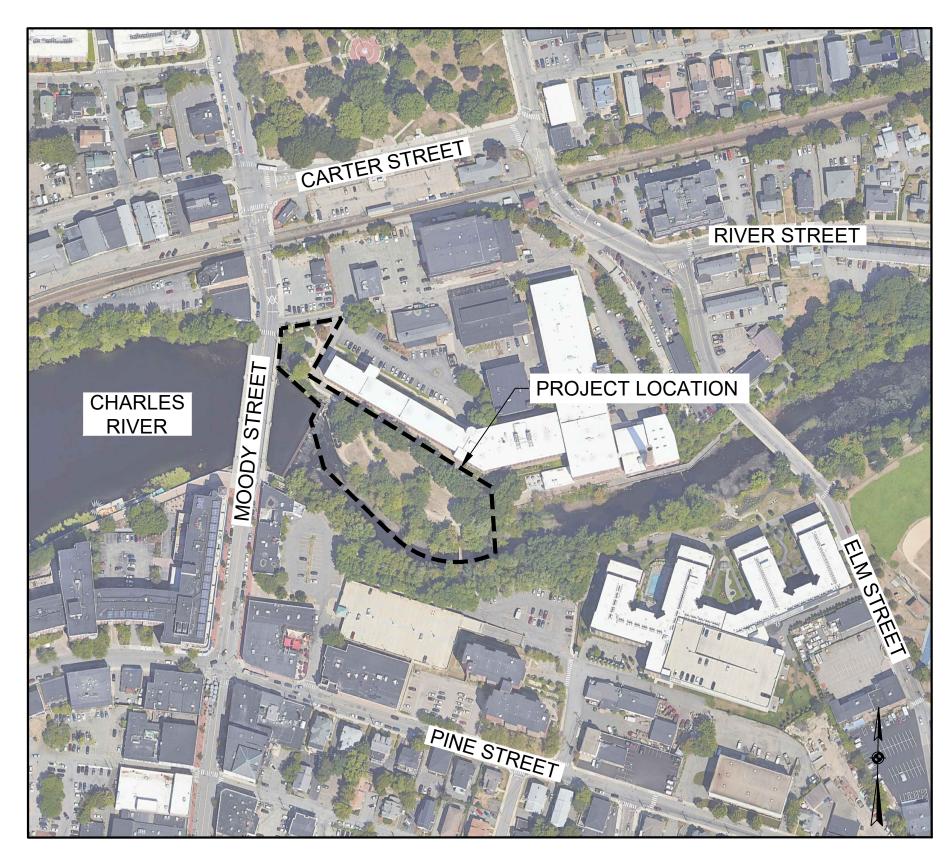
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IRRIGATION DESIGNER


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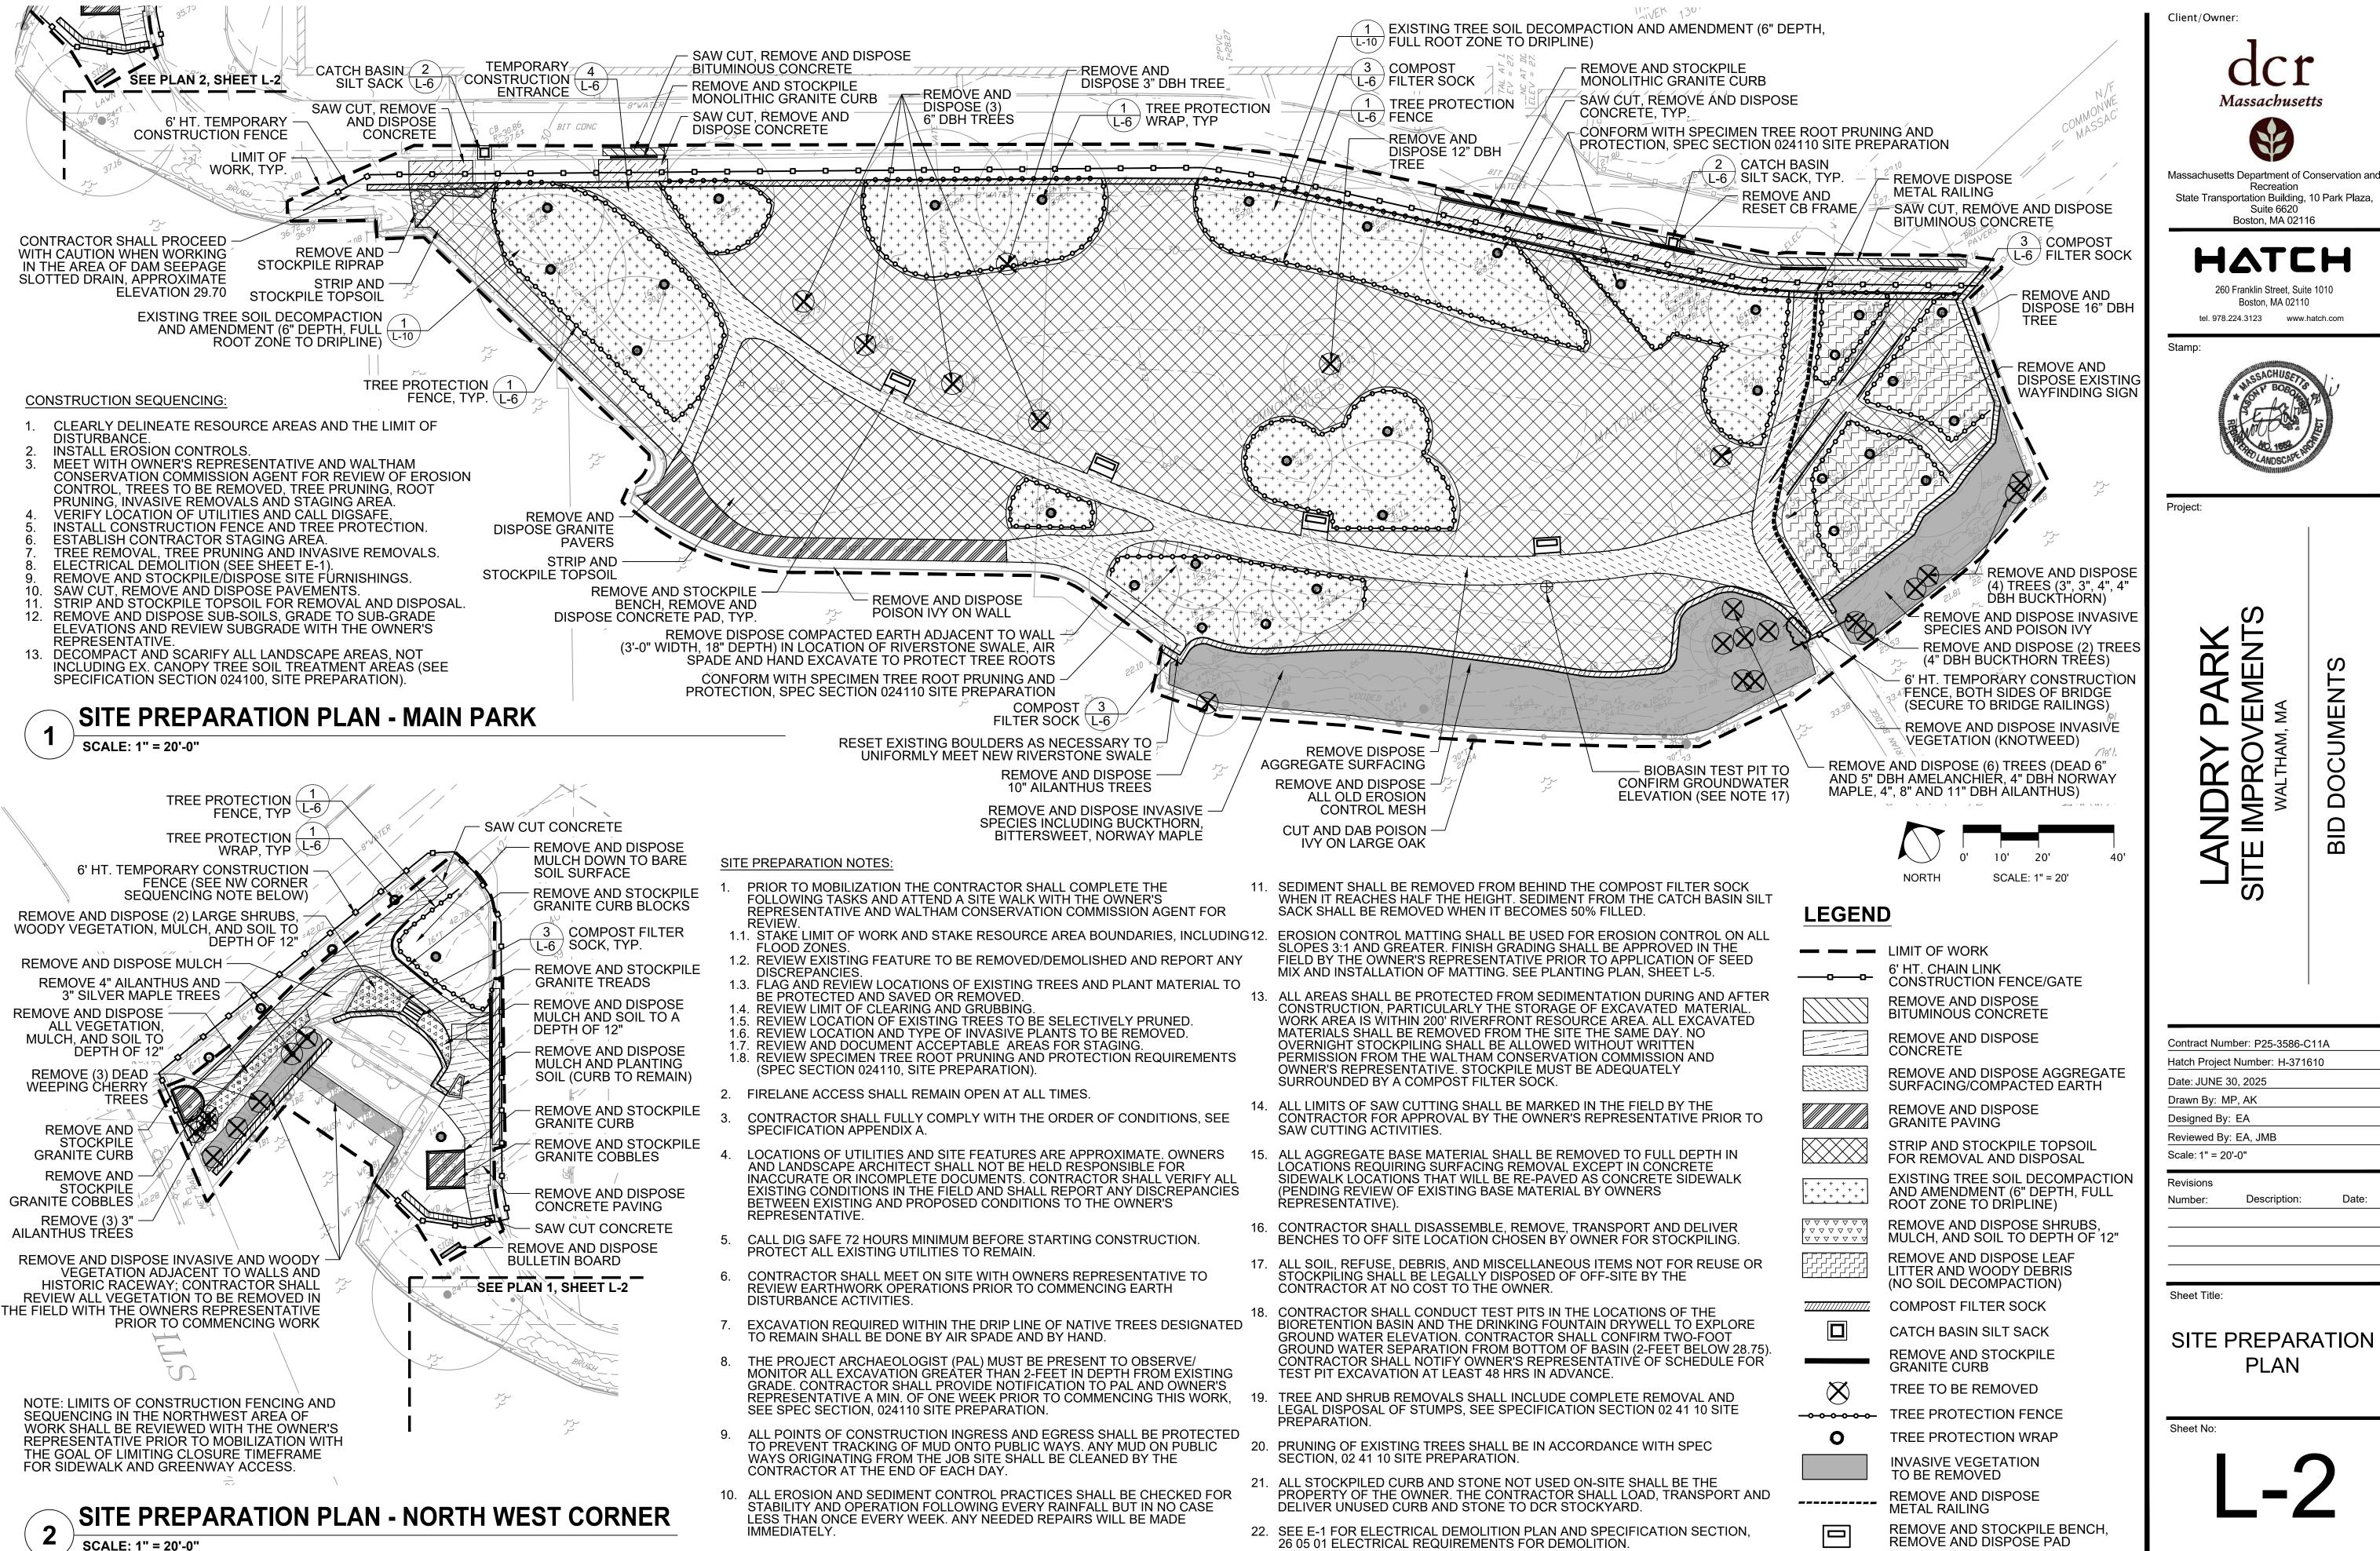
PRIME CONSULTANT & LANDSCAPE ARCHITECT

260 Franklin Street, Suite 1010, Boston, MA 02110 Tel. 857.201.7017 www.hatch.com LANDRY PARK SITE IMPROVEMENTS
WALTHAM, MASSACHUSETTS

BID DOCUMENTS

DRAWN: JN/MP DESIGNED: DB/AK	CONTRACT NO. P25-3586	-C11A
CHECKED: JB	DATE: JUNE 30 2025	SCALE: AS NOTED
REVIEWED: JB/EA	ACC. NO. 104893x	SHEET 1 OF 21



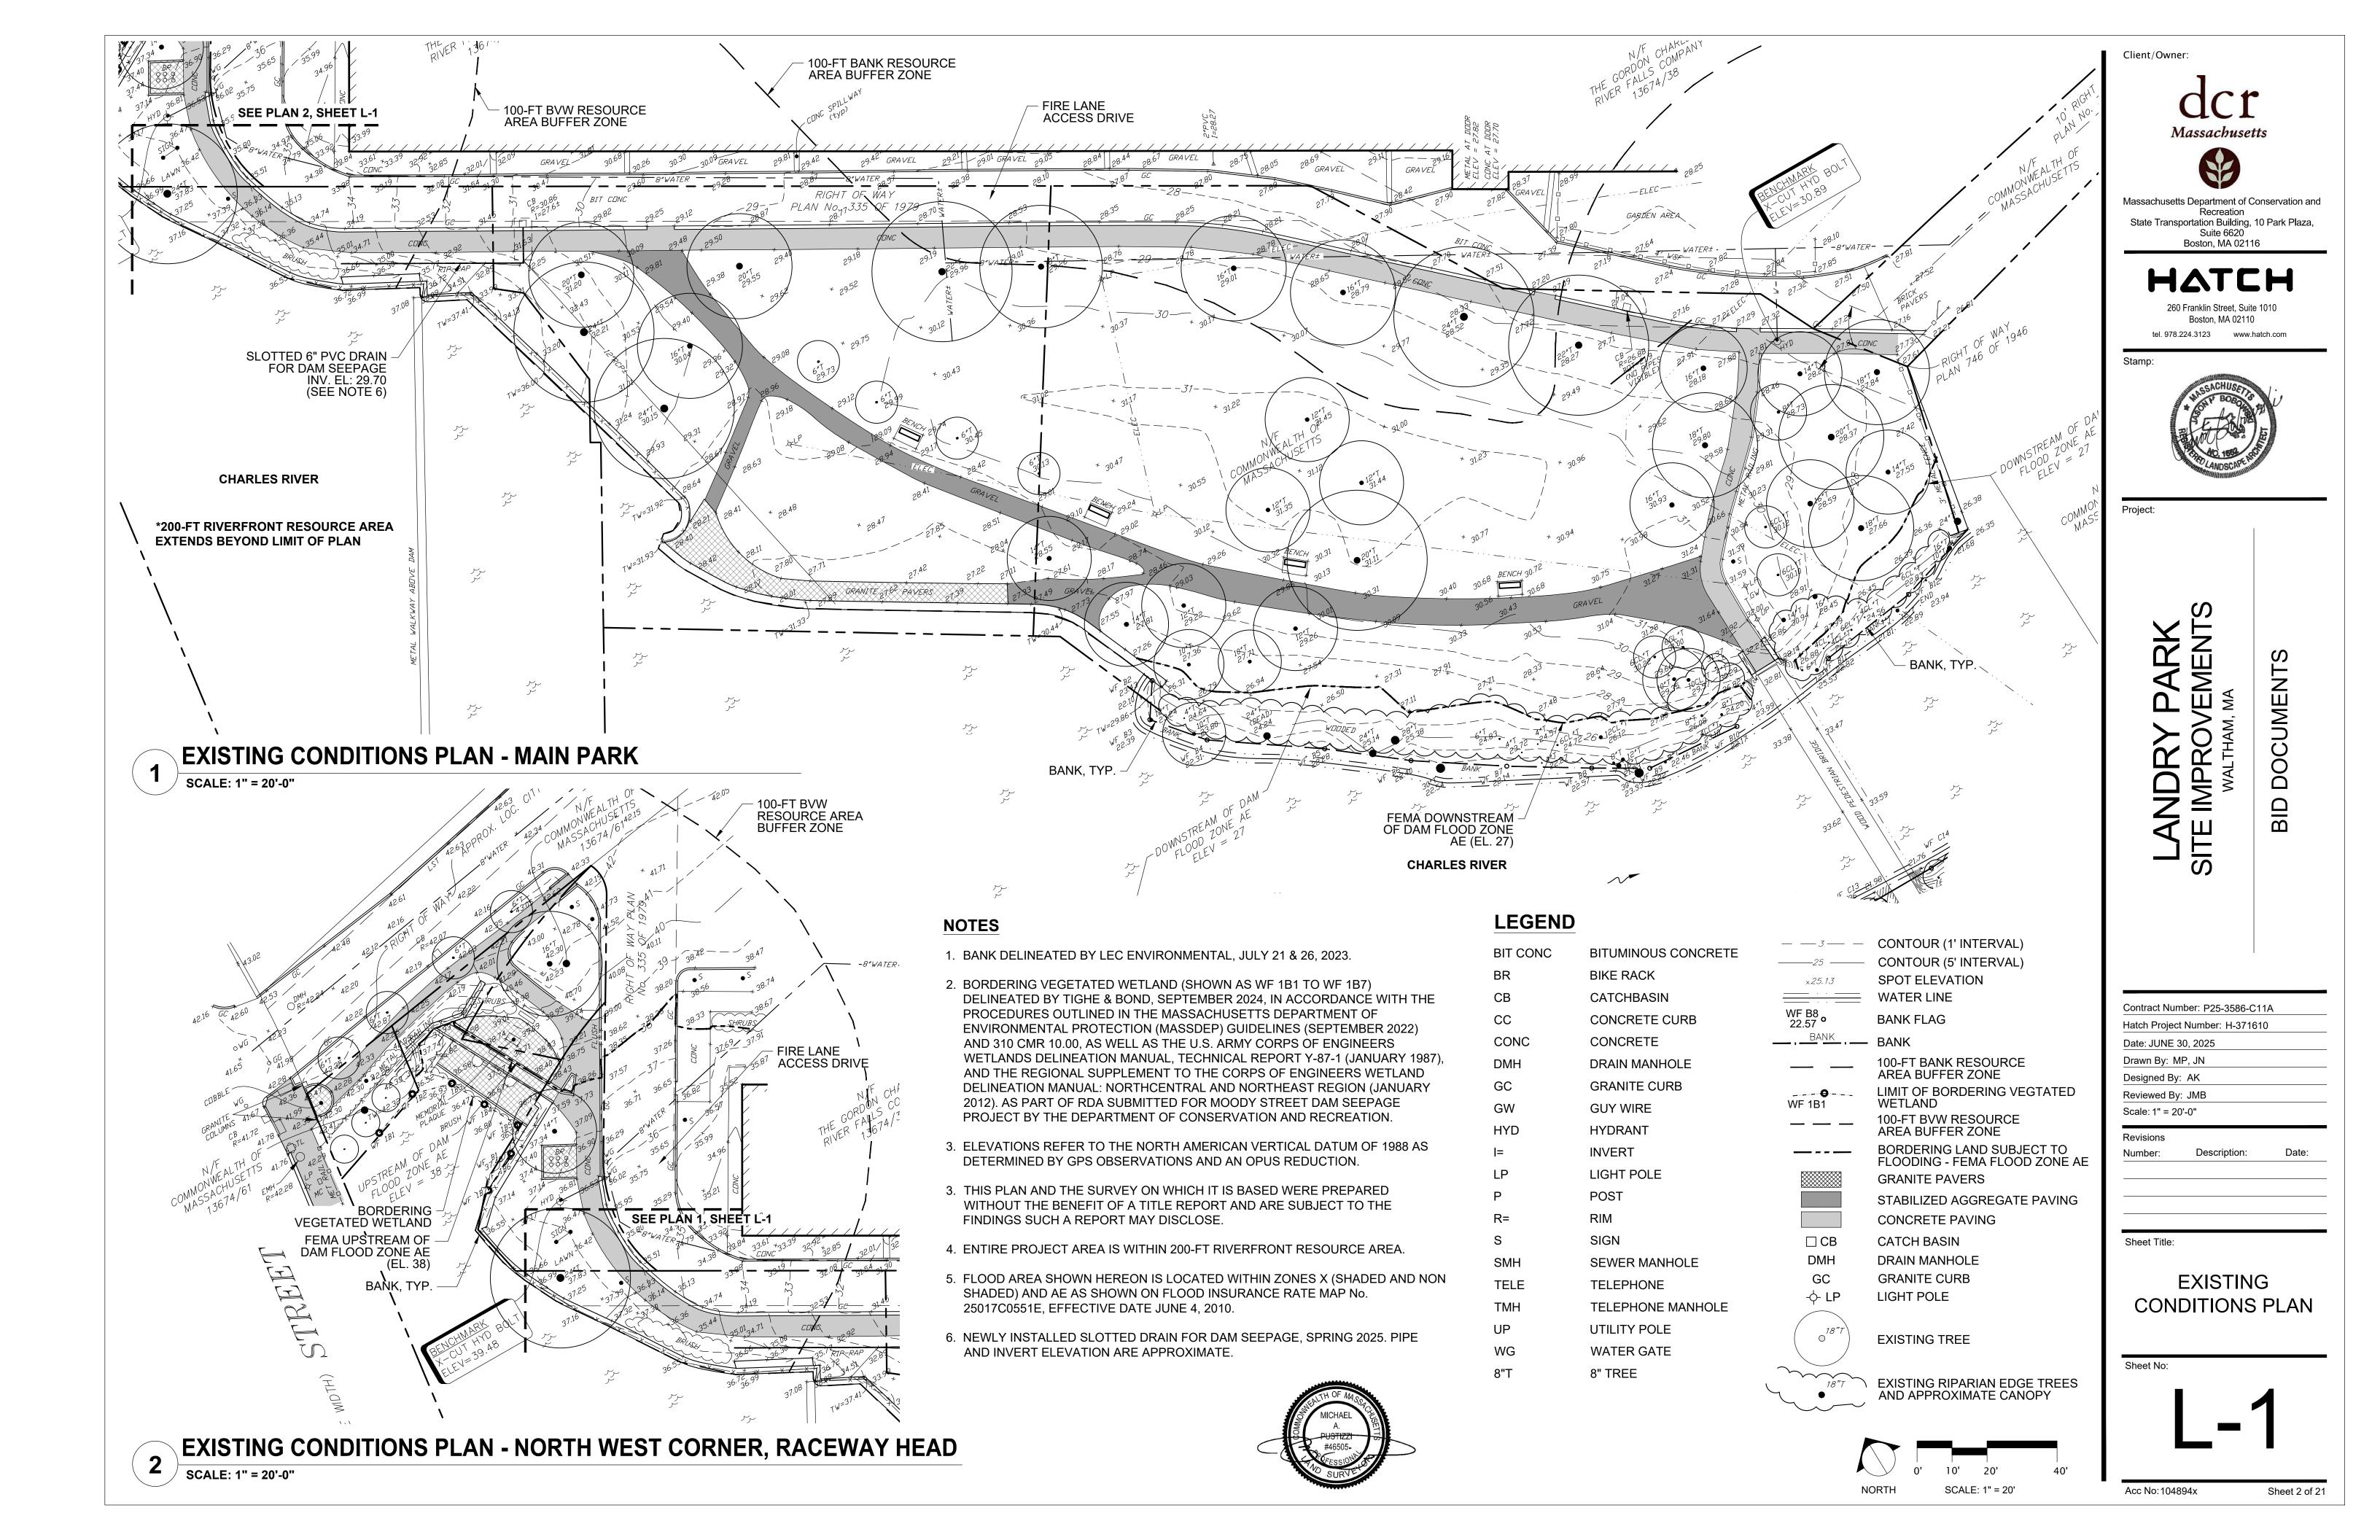



Acc No: 104895x Sheet 3 of 21

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Date:



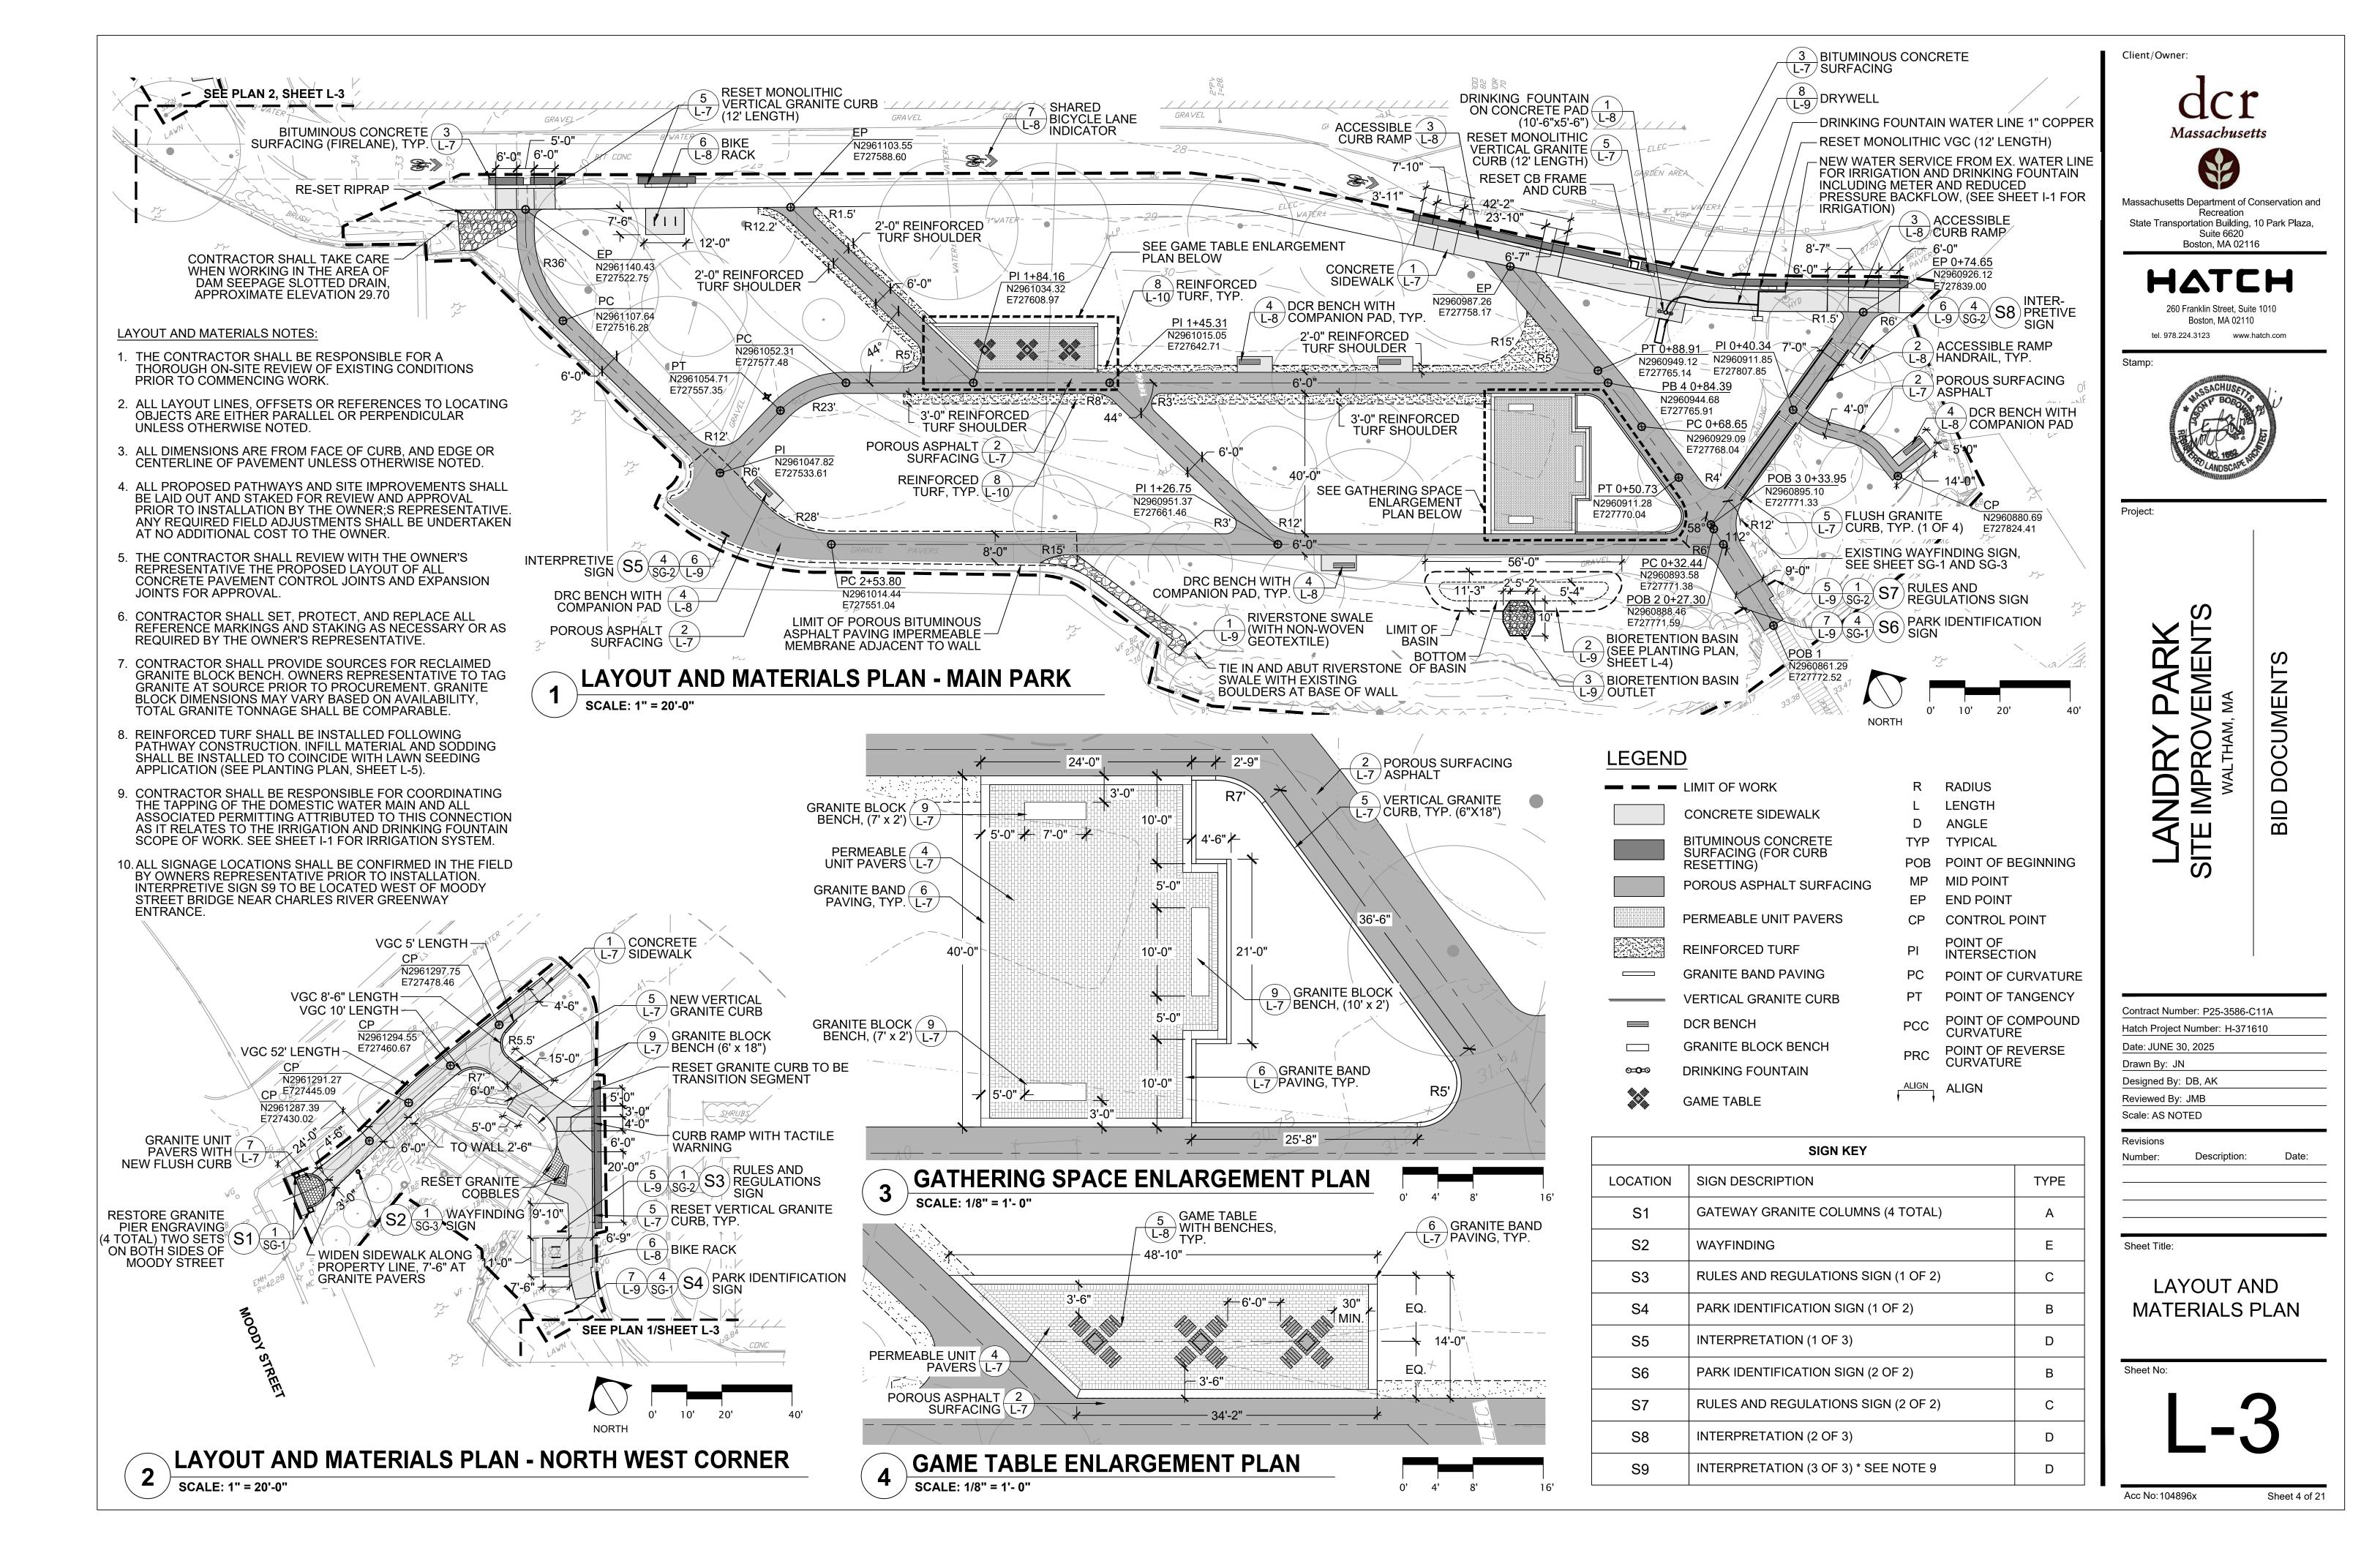

GRADING AND DRAINAGE PLAN - MAIN PARK

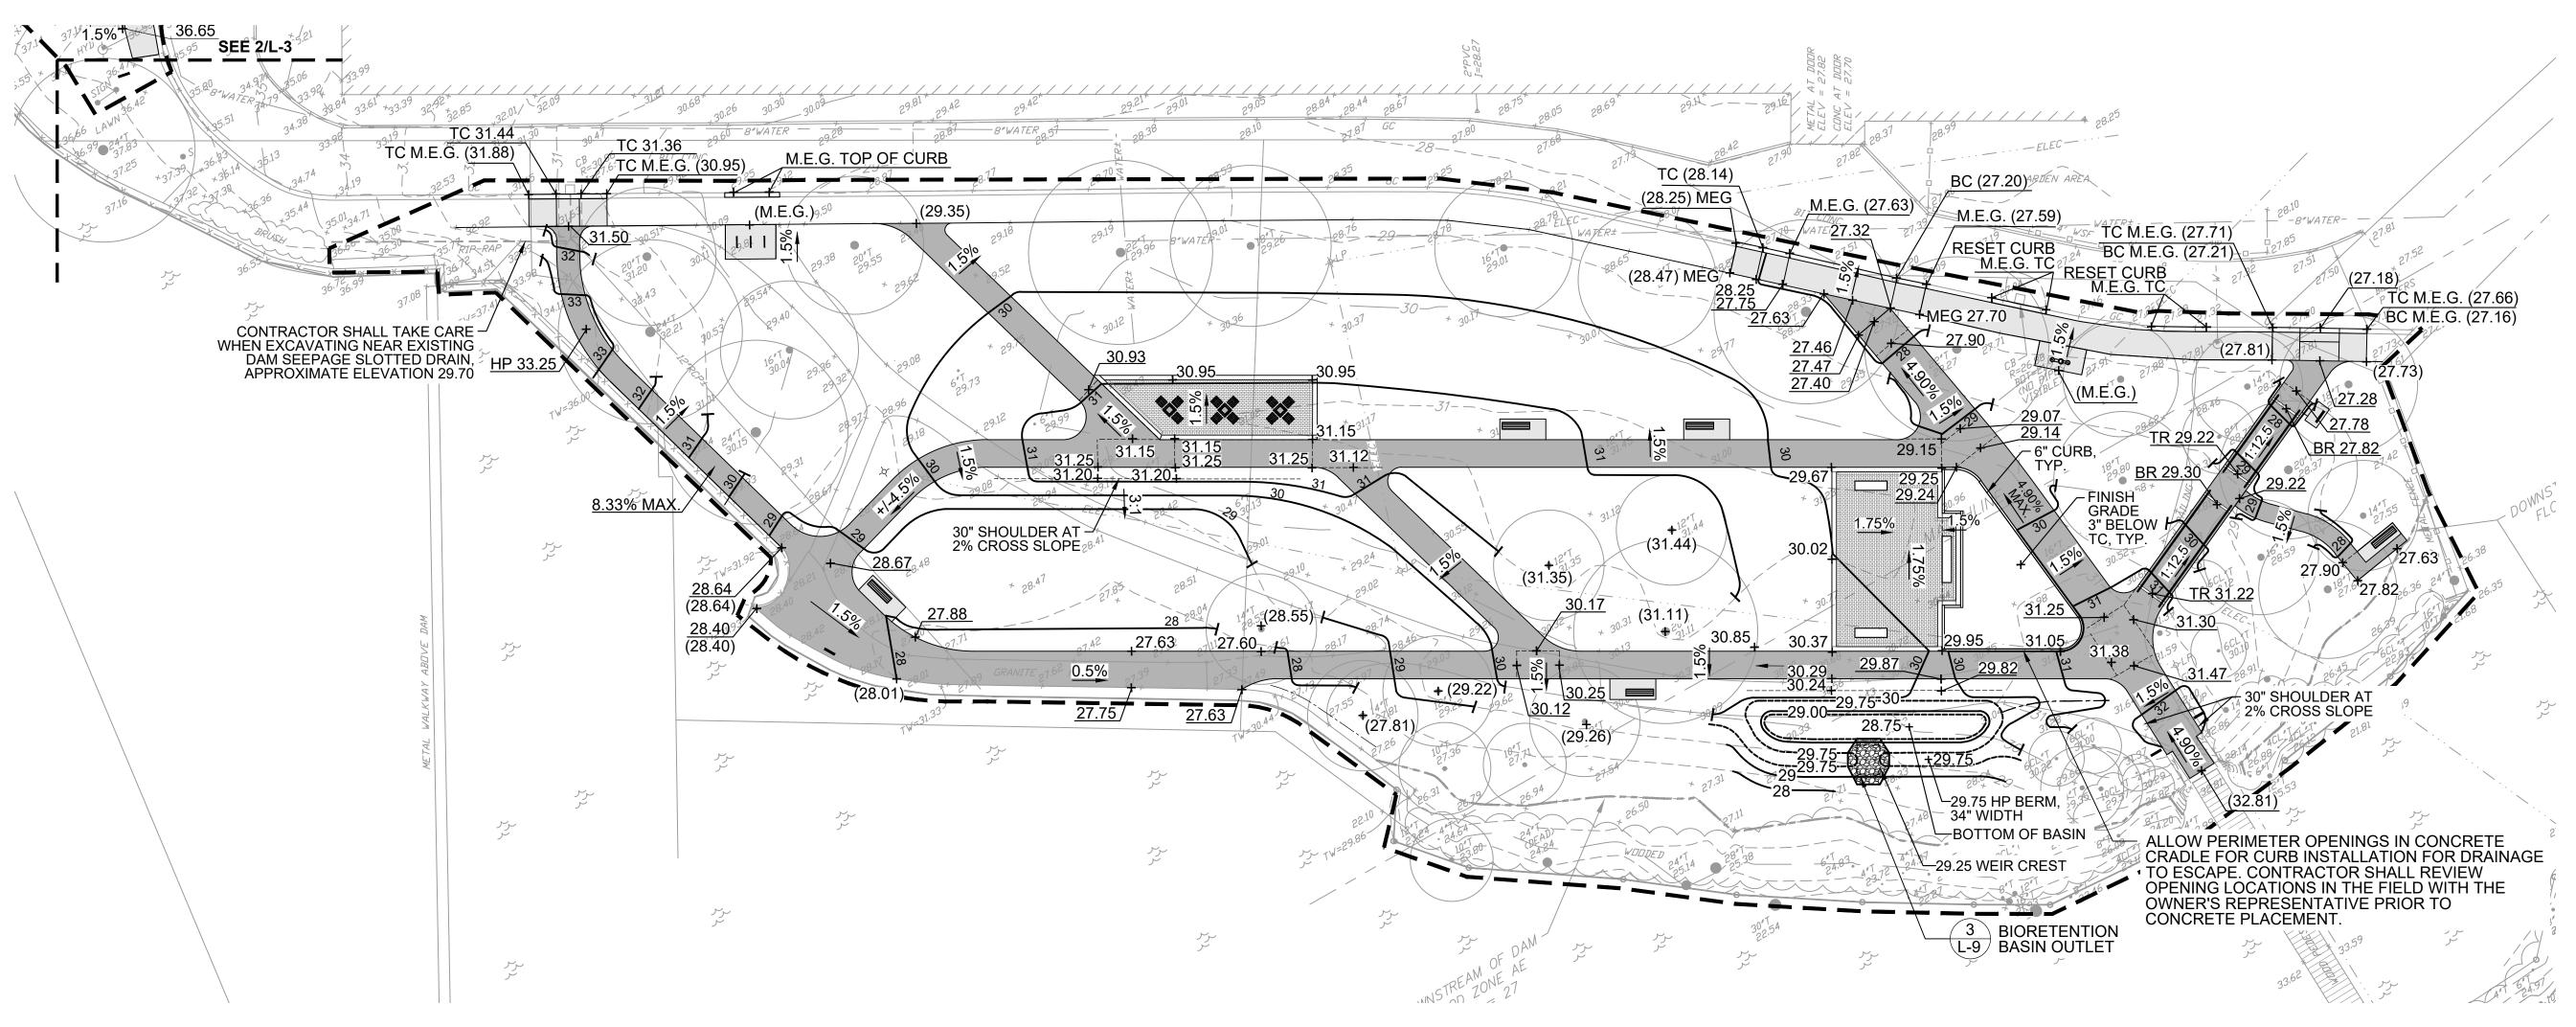SCALE: 1" = 20'-0"

SCALE: 1" = 20'-0"

BC & TC 41.87 TC 40.47 BC 39.97 TC & BC 42.25 PLANTING BED FINSH GRADE 2"# BELOW TW AND PATH, TYP. M.E.G. (38.43) M.E.G. (37.47) ²M.É.G. TC (37.00) M.E.G. BC (36.48) SEE PLAN 1, SHEET L-3

GRADING AND DRAINAGE PLAN - NORTH WEST CORNER

GRADING AND DRAINAGE NOTES:

- THE CONTRACTOR SHALL VERIFY ALL EXISTING GRADES IN THE FIELD AND SHALL REPORT ANY DISCREPANCIES BETWEEN THE EXISTING AND PROPOSED CONDITION TO THE OWNER'S REPRESENTATIVE.
- EXCAVATION REQUIRED WITHIN PROXIMITY OF KNOWN EXISTING UTILITY LINES SHALL BE DONE BY HAND. CONTRACTOR SHALL REPAIR ANY DAMAGE TO EXISTING UTILITY LINES OR STRUCTURES INCURRED DURING CONSTRUCTION OPERATIONS AT NO COST TO THE OWNER.
- CONTRACTOR IS CAUTIONED THE LOCATION AND/OR ELEVATION OF EXISTING UTILITIES AND STRUCTURES, AS SHOWN ON THESE PLANS, IS BASED ON THE EXISTING SURVEY. THIS INFORMATION IS NOT TO BE RELIED ON AS BEING EXACT OR COMPLETE. THE CONTRACTOR, PRIOR TO THE START OF CONSTRUCTION, SHALL VERIFY THE LOCATION OF ALL UNDERGROUND UTILITIES AND STRUCTURES IN THE FIELD. THE CONTRACTOR MUST CONTACT THE APPROPRIATE UTILITY COMPANY, AND ANY GOVERNING PERMITTING AUTHORITY, AT LEAST 72 HOURS PRIOR TO ANY EXCAVATION WORK TO REQUEST THE EXACT FIELD LOCATION OF UTILITIES INTERFERING WITH THE PROPOSED CONSTRUCTION AND APPROPRIATE REMEDIAL ACTIONS TAKEN BEFORE PROCEEDING WITH THE WORK. IT SHALL BE THE RESPONSIBILITY OF THE CONTRACTOR TO RELOCATE ALL EXISTING UTILITIES WHICH CONFLICT WITH THE PROPOSED IMPROVEMENTS SHOWN ON THE PLAN.
- ALL NEW PATHWAY GRADING MUST CONFORM TO CURRENT AMERICANS WITH DISABILITIES ACT (ADA), AND MASSACHUSETTS ARCHITECTURAL ACCESS BOARD (MAAB) REGULATIONS, UNLESS OTHERWISE DIRECTED BY THE OWNER'S REPRESENTATIVE. WALKWAYS SHALL MAINTAIN A CROSS PITCH OF NOT MORE THAN ONE AND A HALF (1.5%) PERCENT AND THE RUNNING SLOPE (PARALLEL TO THE DIRECTION OF TRAVEL) BETWEEN 1% MIN. AND 4.5% MAX. ANY DISCREPANCIES NOT ALLOWING THIS TO OCCUR SHALL BE REPORTED TO THE OWNERS REPRESENTATIVE PRIOR TO CONTINUING WORK.
- CONTRACTOR SHALL STAKE LIMITS OF SWALE AND BIORETENTION BASIN IN THE FIELD FOR REVIEW BY THE OWNER'S REPRESENTATIVE PRIOR TO COMMENCING EXCAVATION.

- CONTRACTOR SHALL NOTIFY OWNER'S REPRESENTATIVE UPON COMPLETION OF ROUGH GRADING OF SUBGRADE FOR REVIEW AND APPROVAL PRIOR TO COMMENCING PLACEMENT OF NEW SOILS OR HARDSCAPE BASE MATERIALS.
- 7. WHERE NEW EARTHWORK MEETS EXISTING EARTHWORK, CONTRACTOR SHALL BLEND THE GRADES SMOOTHLY, PROVIDING VERTICAL CURVES OR ROUNDS AT ALL TOP AND BOTTOM OF SLOPES, AND ELIMINATE ROUGH SPOTS AND ABRUPT GRADE CHANGES.
- 8. ALL PROPOSED PAVEMENTS SHALL EVENLY MEET THE LINE, GRADE AND EDGES OF EXISTING ADJACENT PAVEMENT SURFACES AS WELL THE TOP OF RAMPS AND BACK OF CURBS.
- ALL UTILITY GRATES, COVERS OR OTHER SURFACE ELEMENTS INTENDED TO BE EXPOSED AT GRADE SHALL BE FLUSH WITH THE ADJACENT FINISHED GRADE AND ADJUSTED TO PROVIDE A SMOOTH TRANSITION AT ALL EDGES.
- 10. CONTRACTOR SHALL ENSURE ALL AREAS PROPERLY PITCH TO DRAIN, WITH NO SURFACE WATER PONDING OR PUDDLING.
- 11. BENCH PADS SHALL NOT EXCEED 1.5% MAXIMUM SLOPE.
- 12. CONTRACTOR SHALL BE RESPONSIBLE FOR ESTABLISHING AND MAINTAINING ALL CONTROL POINTS AND BENCH MARKS NECESSARY FOR THE WORK.

LEGEND

	LIMIT OF WORK
37	PROPOSED CONTOUR
	EXISTING CONTOUR
×24.50	EXISTING SPOT ELEVATION
+ 24.50	SPOT ELEVATION
HP 36.24	HIGH POINT
LP 36.24	LOW POINT
TC 36.24	TOP OF CURB
BC 36.24	BOTTOM OF CURB
TR 36.24	TOP OF RAMP
BR 36.24	BOTTOM OF RAMP
1.5%	SLOPE

NORTH SCALE: 1" = 20'

Massachusetts



Massachusetts Department of Conservation and Recreation State Transportation Building, 10 Park Plaza, Suite 6620 Boston, MA 02116

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260 Franklin Street, Suite 1010 Boston, MA 02110 tel. 978.224.3123 www.hatch.com

Client/Owner:



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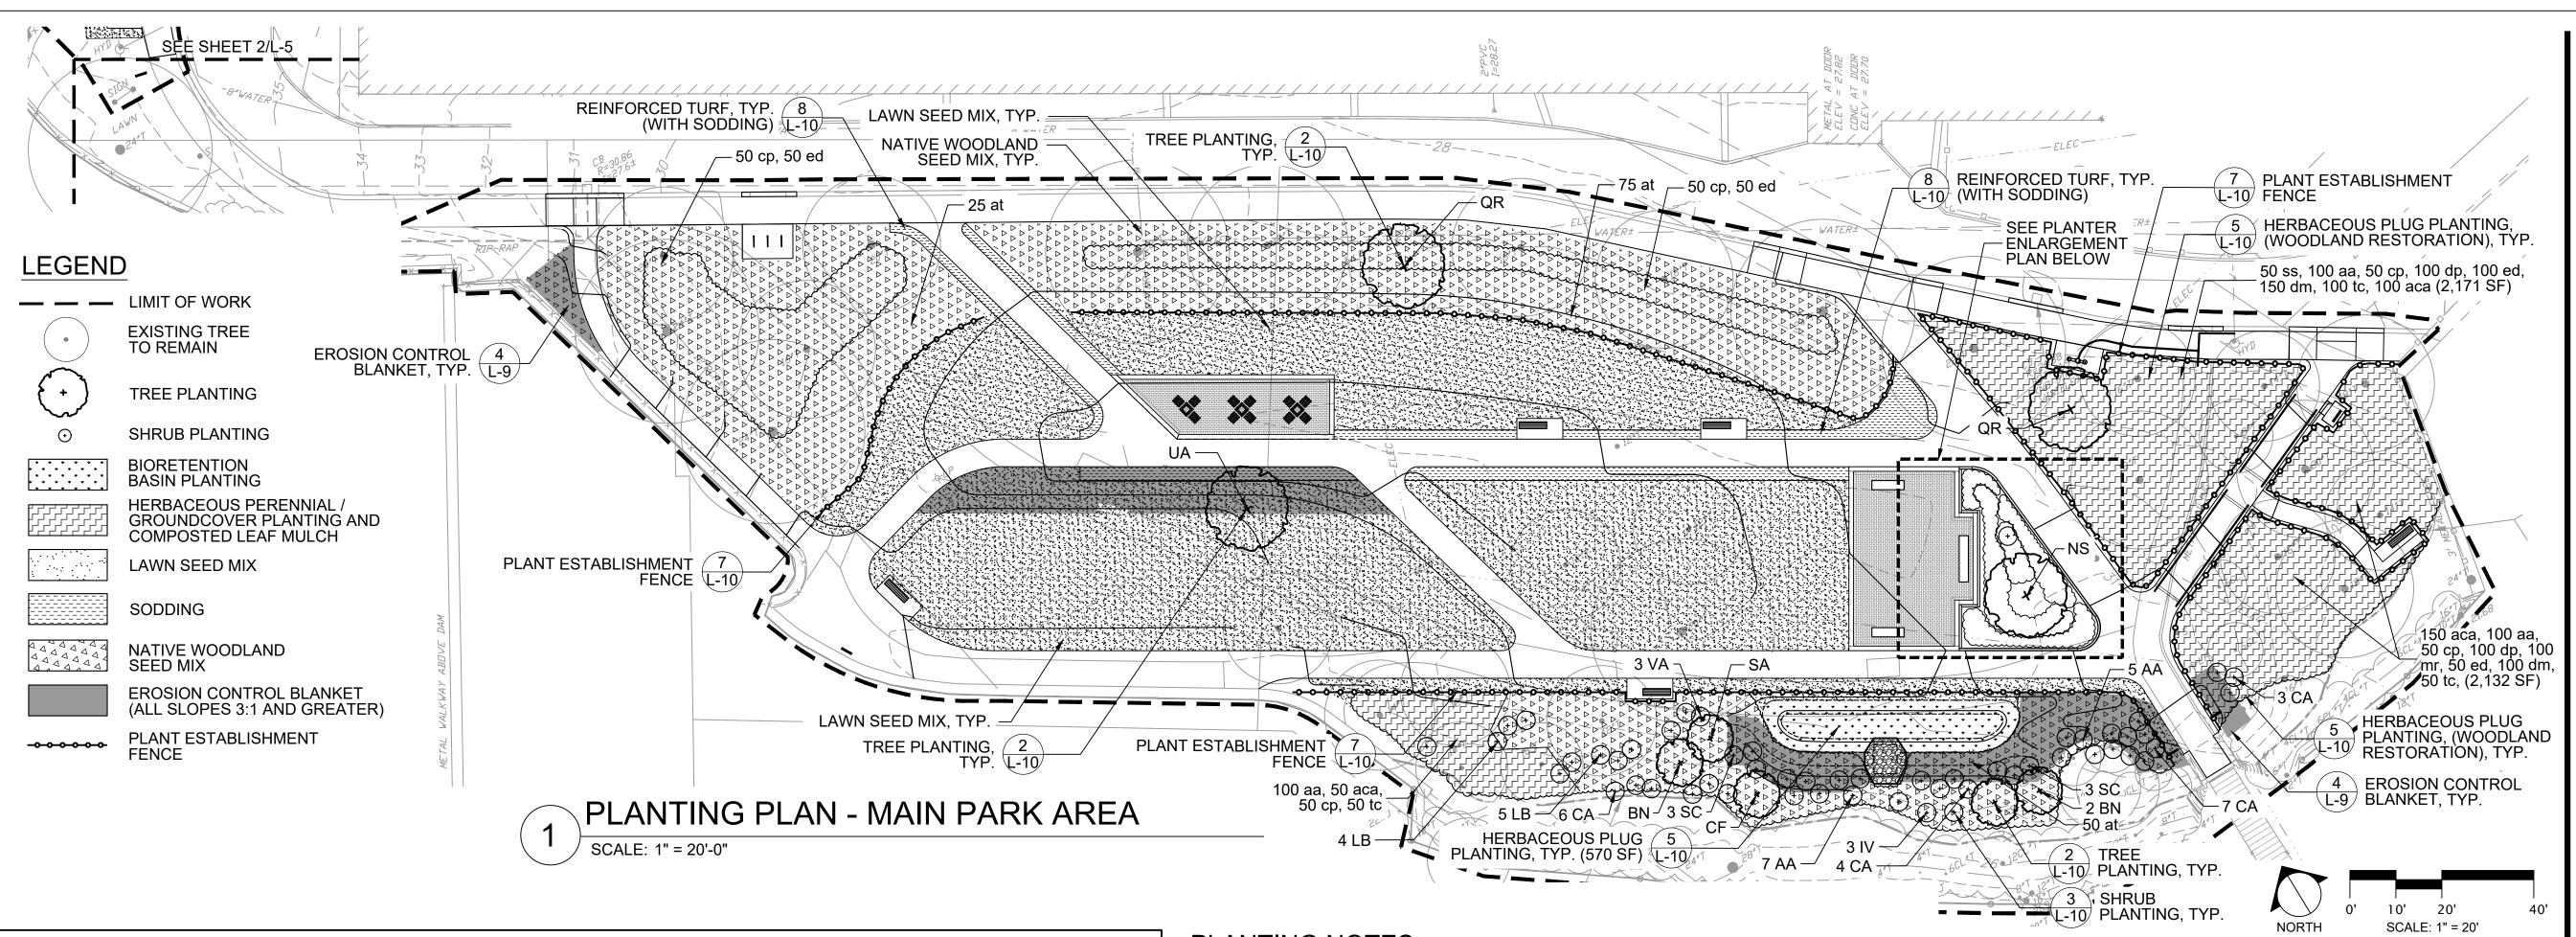
Contract Number: P25-3586-C11A Hatch Project Number: H-371610 Date: JUNE 30, 2025 Drawn By: MP, JN Designed By: DB, AK Reviewed By: EA, JMB Scale: 1" = 20'-0" Revisions Description: Number:

Sheet Title:

GRADING AND DRAINAGE PLAN

Sheet 5 of 21


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QTY.	ID	SCIENTIFIC NAME	COMMON NAME	SIZE	WETLAND STATUS	SHADE TOLERANCE	COMMENTS
TREE	 S			•			
3	BN	Betula nigra	river birch	8' HT.	FACW	FULL SUN/PART SHADE	B&B, MULTI-STEM
1	CF	Cornus florida	flowering dogwood	8' HT.	FACU	FULL SUN/PART SHADE	B&B
1	NS	Nyssa sylvatica	black gum	2.5"-3" CAL.	FAC	FULL SUN/PART SHADE	B&B
2	QR	Quercus rubra	red oak	2.5"-3" CAL.	FACU	FULL SUN	B&B
1	SA	Sassafras albidum	sassafras	8' HT.	FACU	FULL SUN/PART SHADE	B&B
1	UA	Ulmus americana 'Princeton		2.5"-3" CAL.	FACW	FULL SUN	B&B
9	Total						
SHRU							
12	AA	Aronia arbutifolia	red chokeberry	24" HT.	FACW	FULL SUN/PART SHADE	CONT.
20	CA	Clethra alnifolia	summersweet	24" HT.	FAC	SUN/PART SHADE	CONT.
1	HV	Hamamelis virginiana	common witch hazel	24" HT.	FACU	PART SHADE	CONT.
3	IV	llex verticillata	winterberry	24" HT.	FACW	FULL SUN/PART SHADE	CONT.
9	LB	Lindera benzoin	spicebush	24" HT.	FACW	PART SHADE	CONT.
6	SC	Sambucus canadensis	common elderberry	24" HT.	FACW	FULL SUN/PART SHADE	CONT.
11	VA	Viburnum acerifolium	mapleleaf viburnum	3' HT.	UPL	FULL SUN/PART SHADE	CONT.
62	Total				, <u> </u>	, · · · · · · · · · · · · · · · · · · ·	1
		S - 12" SPACING					
300	aca	Asarum canadense	Canadian wild ginger	2.5" PLUG	UPL	PARTIAL/FULL SHADE	MIN. GROUPS OF
100	auu	Arctostaphylos uva—ursi	bearberry	2.5" PLUG	UPL	FULL SUN/PART SHADE	MIN. GROUPS OF
300	aa	Athyrium angustum	lady fern	2.5" PLUG	FAC	PARTIAL/FULL SHADE	MIN. GROUPS OF
150	at	Asclepias tuberosa	butterfly weed	2.5" PLUG	N/A	FULL SUN	MIN. GROUPS OF
250	Ср	Carex pensylvanica	Pennsylvania sedge	2.5" PLUG	N/A	PARTIAL/FULL SHADE	MIN. GROUPS OF
200	dp	Dennstaedtia punctilobula	hay-scented fern	2.5" PLUG	UPL	PARTIAL SHADE	MIN. GROUPS OF
250	dm	Dryopteris marginalis	marginal woodfern	2.5" PLUG	FACU	PARTIAL/FULL SHADE	MIN. GROUPS OF
250	ed	Eurybia divaricata	white wood aster	2.5" PLUG	N/A	PARTIAL/FULL SHADE	MIN. GROUPS OF
100	mr	Maianthemum racemosum	false solomon's seal	2.5" PLUG	FÁCU	PARTIAL/FULL SHADE	MIN. GROUPS OF
50	SS	Schizachyrium scoparium	little bluestem	2.5" PLUG	FACU	FULL SUN	MIN. GROUPS OF
200	tc	Tiarella cordifolia	foamflower	2.5" PLUG	FACU	PARTIAL/FULL SHADE	MIN. GROUPS OF
2150	Total						
BIORE	TENTIC	ON BASIN					
50	at	Asclepias tuberosa	butterfly weed	2.5" PLUG	N/A	FULL SUN	15" SPACING
50	jc	Juncus canadensis	Canada rush	2.5" PLUG	N/A	FULL SUN/PART SHADE	15" SPACING
50	je	Juncus effusus	soft rush	2.5" PLUG	OBL	FULL SUN/PART SHADE	15" SPACING
50	p۷	Panicum virgatum	switchgrass	2.5" PLUG	FAC	FULL SUN/PART SHADE	18" SPACING
100	SS	Schizachyrium scoparium	little bluestem	2.5" PLUG	FACU	FULL SUN	15" SPACING
300	Total			•			
PLANT	ER AN	D NORTHWEST ENTRY AREA	1				
90	auu2	Arctostaphylos uva—ursi	bearberry	1 GAL.	UPL	FULL SUN/PART SHADE	18" SPACING
46	at2	Asclepias tuberosa	butterfly weed	1 GAL.	N/A	FULL SUN	18" SPACING
15	cp2	Carex pensylvanica	Pennsylvania sedge	1 GAL.	N/A	PARTIAL/FULL SHADE	18" SPACING
39	dp2	Dennstaedtia punctilobula	hay-scented fern	1 GAL.	UPL	PARTIAL SHADE	18" SPACING
125	ss2	Schizachyrium scoparium	little bluestem	1 GAL.	FACU	FULL SUN	18" SPACING
315	Total	Comzaonymann Coopanam	, helio bidoblom	1 . 0	17100	1 0014	1.0 01/101110


PLANTING NOTES:

- ALL LANDSCAPE AND SEEDED AREAS OUTSIDE OF EXISTING TREE DRIP LINES SHALL RECEIVE 6" DEPTH NEW TURF SOIL MIX, SEE SPECIFICATION SECTION, 32 91 13 PLANTING SOILS.
- CURBED PLANTER AREA SHALL RECEIVE 24" DEPTH NEW PLANTING SOIL, SEE SPECIFICATION SECTION, 32 91 13 PLANTING SOILS.
- 3. ALL TREE. SHRUB AND HERBACEOUS PLANTINGS SHALL BE BACKFILLED WITH NEW PLANTING SOIL.
- 4. THE PROJECT ARCHAEOLOGIST (PAL) MUST BE PRESENT TO OBSERVE ALL EXCAVATION GREATER THAN 2-FEET IN DEPTH FROM EXISTING GRADE. CONTRACTOR SHALL PROVIDE WRITTEN NOTIFICATION TO PAL AND OWNER'S REPRESENTATIVE ONE WEEK PRIOR TO COMMENCING THIS WORK.
- CONTRACTOR SHALL LOCATE EXISTING AND PROPOSED UTILITIES TO VERIFY PROPOSED PLANT LOCATIONS AND SHALL REPORT ANY CONFLICTS TO THE OWNER'S REPRESETATIVE.
- ACCEPTANCE OF FINAL GRADING AND EROSION CONTROL BLANKET MUST BE PROVIDED BY THE OWNER'S REPRESENTATIVE PRIOR TO COMMENCING PLANTING OPERATIONS.
- 7. EROSION CONTROL BLANKET IS NOT LIMITED TO LOCATIONS SHOWN. EROSION CONTROL BLANKET SHALL BE PROVIDED FOR ALL 3:1 SLOPES AND GREATER. LIMITS OF EROSION CONTROL SHALL BE REVIEWED WITH THE OWNER'S REPRESENTATIVE PRIOR TO SEEDING AND BLANKET INSTALLATION.
- 8. ALL PLANTS SHALL BE STRAIGHT SPECIES (NO CULTIVARS) UNLESS OTHERWISE NOTED.
- 9. CONTRACTOR SHALL IDENTIFY SOURCING FOR ALL PLANT MATERIAL WITHIN TWO-WEEKS (14) DAYS OF AWARD OF CONTRACT.
- 10. SUBSTITUTIONS OF PLANT SPECIES SHALL NOT BE ALLOWED UNLESS PROOF IS PROVIDED AN INDIVIDUAL SPECIES IS NOT COMMERCIALLY AVAILABLE. SUBSTITUTIONS SHALL REQUIRE WRITTEN APPROVAL BY THE OWNER'S REPRESENTATIVE.
- 11. ALL PLANTS SHALL BE APPROVED BY THE LANDSCAPE ARCHITECT AT THE NURSERY PRIOR TO DELIVERY TO SITE. TAGGING REPRESENTATIVE SHRUBS AND HERBACEOUS PLANTS MAY BE ACCEPTABLE WITH PRIOR APPROVAL.
- 12. IF DISCREPANCIES EXIST BETWEEN NUMBER OF PLANTS ON THE PLANTING PLAN AND IN THE PLANT SCHEDULE, THE PLANTING PLAN SHALL GOVERN.
- 13. LOCATIONS OF ALL PROPOSED PLANTING SHALL BE FLAGGED ON-SITE FOR APPROVAL BY THE OWNER'S REPRESENTATIVE PRIOR TO PLANTING.
- 14. INSTALLATION OF HERBACEOUS MATERIAL IN MIXED PLANTING BEDS SHALL OCCUR ONLY AFTER SHRUBS AND/OR TREES HAVE BEEN INSTALLED.
- 15. SEED ALL DISTURBED AREAS. OWNER'S REPRESENTATIVE SHALL REVIEW ALL SEEDING OUTSIDE LIMIT OF WORK FOR APPROVAL OF SEED MIX.
- 16. ALL SEEDED AREAS MUST BY PROTECTED BY EITHER CONSTRUCTION FENCING OR SEED ESTABLISHMENT FENCING. FENCING SHALL BE IN PLACE IMMEDIATELY FOLLOWING SEED APPLICATION UNTIL GERMINATION IS COMPLETE. THE MAIN 9-FOOT PATH MAY BE OPENED PRIOR TO THE REST OF THE SITE AT THE DIRECTION OF THE OWNER. THE CONTRACTOR SHALL ADJUST FENCING AS NECESSARY AT NO ADDITIONAL COST TO THE OWNER.
- 17. WATERING OF INSTALLED PLANTS AND SEEDED AREAS, SHALL OCCUR WITHIN 24 HOURS OF THE SAME DAY OF PLANTING INSTALLATION OR SEED APPLICATION AND CONTINUE AS SPECIFIED.
- 18. THE CONTRACTOR SHALL BE RESPONSIBLE FOR REPLACING ALL DAMAGED, STOLEN, DEAD, DECLINING OR LOST PLANT MATERIAL UNTIL THE COMPLETION OF THE MAINTENANCE AND GUARANTEÉ PERIODS.
- 19. EX. TREE PRUNING SHALL BE IN ACCORDANCE WITH SPEC SECTION, 024110 SITE PREPARATION.
- 20. SEE SHEET I-1 FOR LANDSCAPE IRRIGATION PLAN.



PLANTER ENLARGEMENT 2

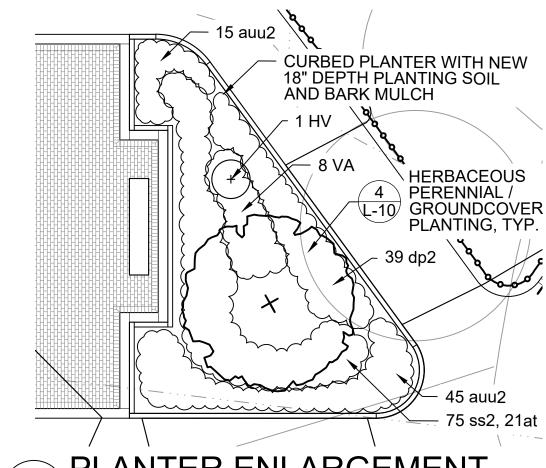SCALE: 1" = 10'-0"

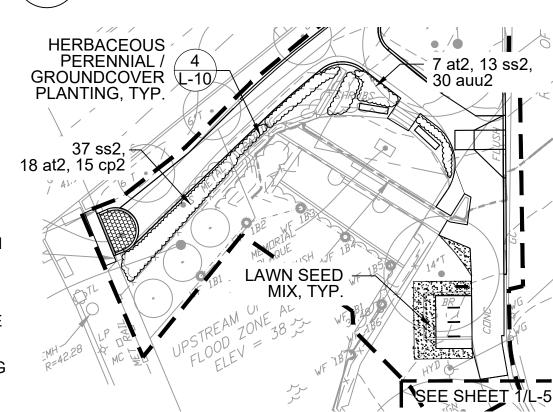

NORTHWEST ENLARGEMEN^T SCALE: 1" = 20'-0"

Client/Owner:



Massachusetts Department of Conservation and State Transportation Building, 10 Park Plaza, Suite 6620

HATCH

Boston, MA 02116

260 Franklin Street, Suite 1010 Boston, MA 02110 tel. 978.224.3123 www.hatch.com



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Contract Number: P25-3586-C11A Hatch Project Number: H-371610 Date: JUNE 30, 2025 Drawn By: MP, JN Designed By: DB, AK

Scale: AS NOTED Revisions

Reviewed By: JMB

Description: Date: Number:


Sheet Title:

PLANTING PLAN & PLANT SCHEDULE

Sheet No:


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Sheet 6 of 21

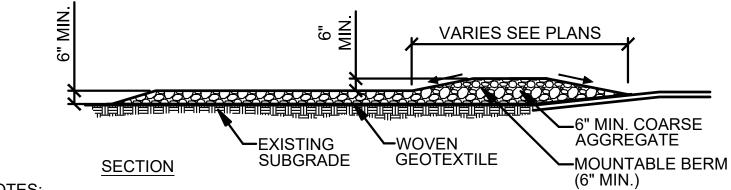


NOTES:

- 1. INSTALL GRAVEL CONSTRUCTION PAD AT INGRESS/EGRESS. MINIMUM WIDTH TO BE EQUAL TO WIDTH OF VEHICULAR ACCESS. ACTUAL WIDTH AND LENGTH TO BE DETERMINED IN FIELD BY OWNER REPRESENTATIVE PRIOR TO CONSTRUCTION.
- 2. PLACE GEOTEXTILE ON EXISTING GROUND PRIOR TO PLACING THE 6" DEEP STONE PAD.
- 3. SEE SPECIFICATIONS SECTION, 312300 EXCAVATING, BACKFILLING AND COMPACTING FOR MATERIÁL.
- 4. PROVIDE PERIODIC TOP DRESSING OF COARSE AGGREGATE AS NEEDED.
- 5. REMOVE TRAPPED SEDIMENT AFTER EACH STORM. CLEAN OR REPLACE FILTER MATERIAL AS NEEDED.
- 6. REMOVE ALL MATERIALS OFF SITE OR AS PER SPECS UPON COMPLETION OF CONSTRUCTION.

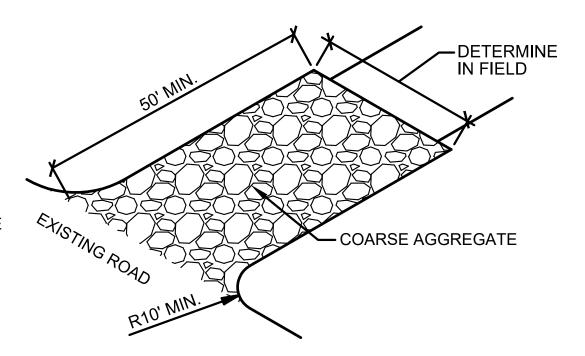

TEMPORARY CONSTRUCTION ENTRANCE

SCALE: NTS

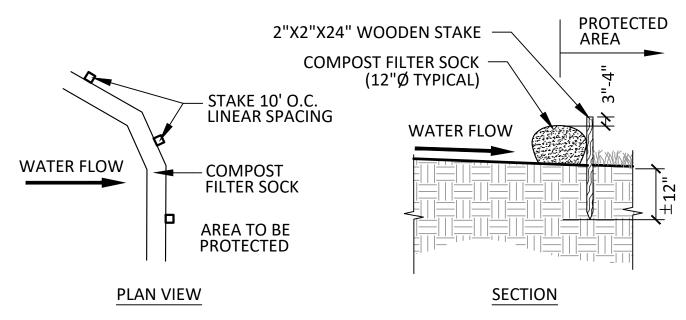


NOTE:

CONTRACTOR TO SLICE MESH FABRIC TUBING OF COMPOST FILTER SOCK, REMOVE ALL FABRIC OFF SITE AND RAKE OUT MULCH AT COMPLETION OF PROJECT.

COMPOST FILTER SOCK

SCALE: NTS

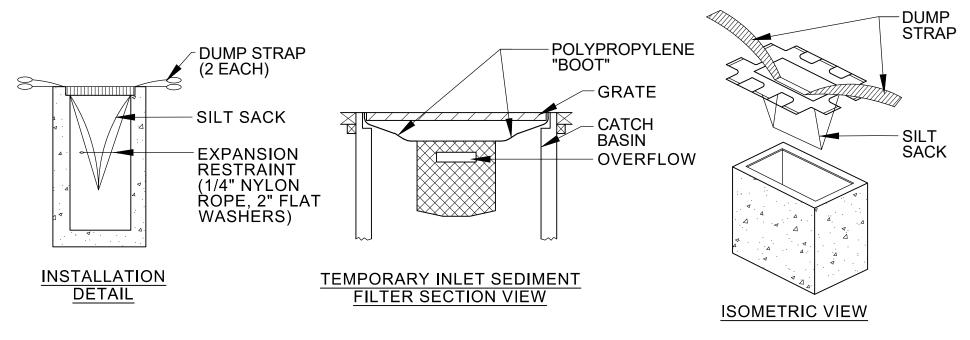


NOTE:

MAINTAIN FILTER IN ACCORDANCE WITH MANUFACTURER'S SPECIFICATIONS.







TREE PROTECTION FENCE AND WRAP SCALE: NTS

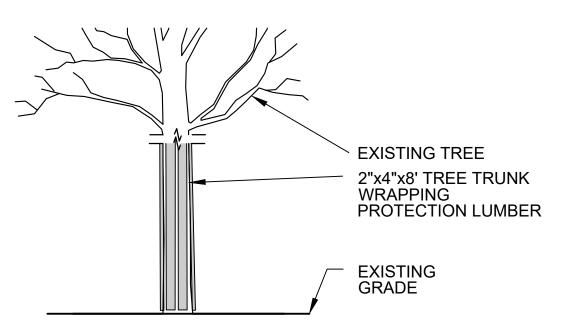


WRAP PROTECTION SECTION B-B'

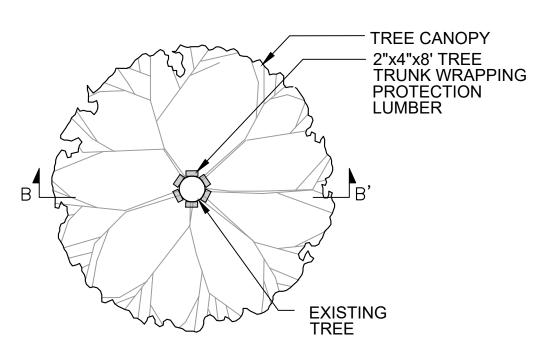

WRAP PROTECTION PLAN

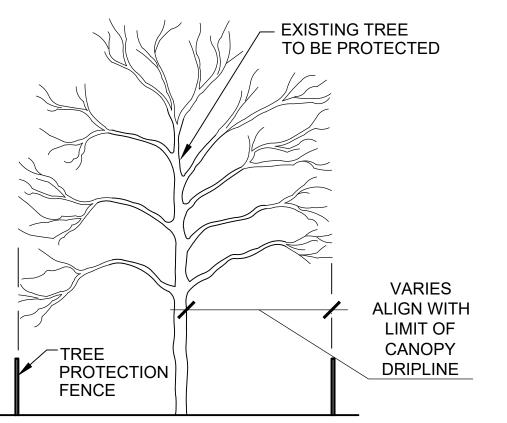

FENCE PROTECTION SECTION A-A'

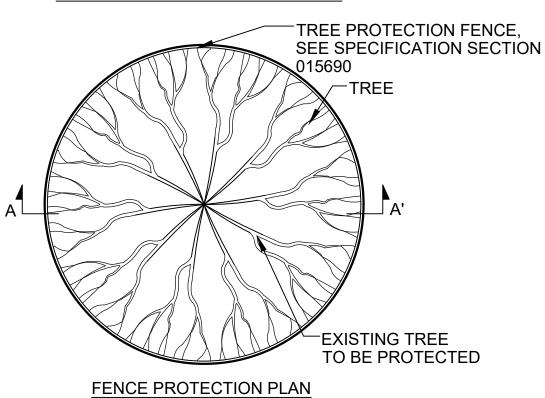

NOTE:

- 1. ALL TREE PROTECTION SHALL BE INSTALLED PRIOR TO ANY CONSTRUCTION ACTIVITIES AND MAINTAINED IN GOOD CONDITION THROUGHOUT THE CONSTRUCTION PERIOD.
- 2. SEE L-2 SITE PREPARATION PLAN FOR LAYOUT OF TREE PROTECTION.

Client/Owner:

Massachusetts

Massachusetts Department of Conservation and Recreation State Transportation Building, 10 Park Plaza, Suite 6620 Boston, MA 02116

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Project:

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Contract Number: P25-3586-C11A Hatch Project Number: H-371610

Date: JUNE 30, 2025 Drawn By: JN

Designed By: AK Reviewed By: EA, JMB Scale: AS NOTED

> Revisions Description: Number:


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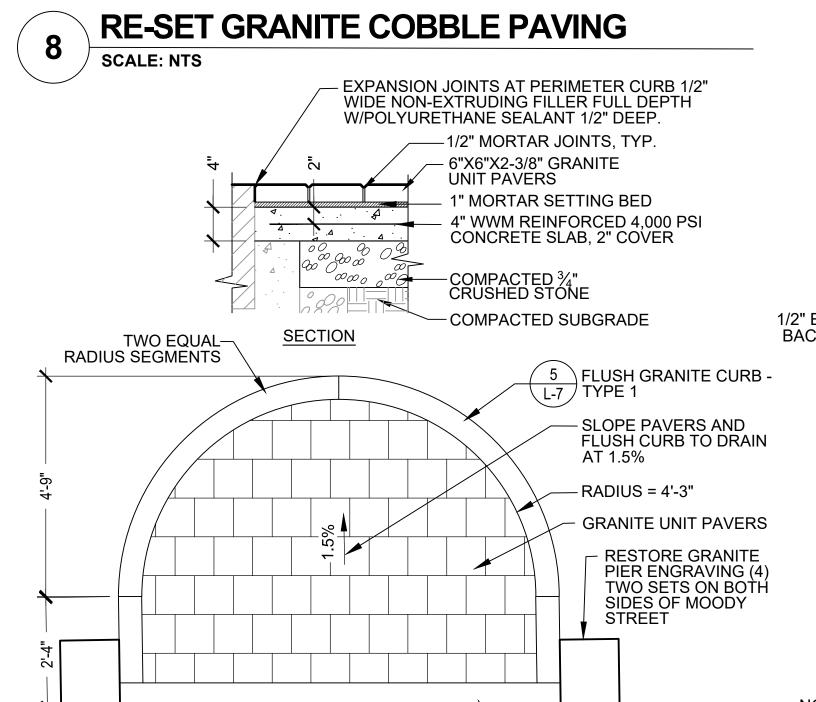
SITE **DETAILS**

Sheet No:

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Sheet 7 of 21



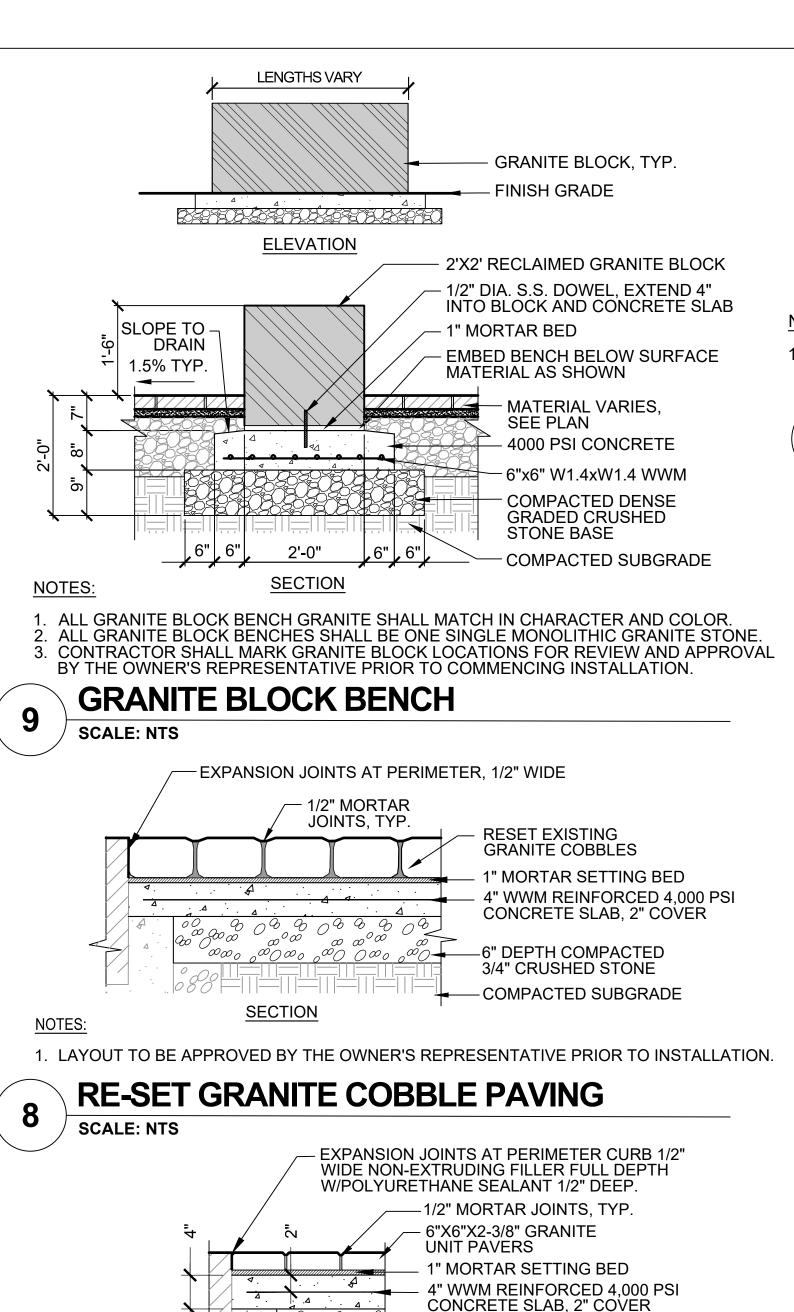

1. CONTRACTOR TO SUBMIT GRANITE PAVER SAMPLE FOR APPROVAL BY THE **OWNER'S REPRESENTATIVE**

9'-6" (VERIFY IN FIELD

<u>PLAN</u>

2. CONTRACTOR SHALL CONFIRM DIMENSIONS AND DISTANCE BETWEEN GRANITE PIERS AND REPORT ANY DISCREPANCIES TO THE OWNER'S REPRESENTATIVE.

CONTRACTOR SHALL SUBMIT SHOP DRAWINGS. 4. RADIAL CURBS TO BE EQUAL LENGTH SEGMENTS

GRANITE UNIT PAVER

SCALE: NTS

ONE SINGLE LENGTH

GRANITE CURB


SCALE: NTS

NOTES:

12" X 30" X 3" GRANITE PAVER, THERMAL FINISH TOP, SAWN SIDES - MATERIAL VARIES, SEE PLAN 1" MORTAR BED 4000 PSI CONCRETE 6"X6" W1.4XW1.4 WWM REINFORCEMENT COMPACTED DENSE GRADED CRUSHED STONE BASE **COMPACTED SUBGRADE** NOTES: **SECTION**


1. CONTRACTOR SHALL SUBMIT SHOP DRAWINGS FOR APPROVAL SHOWING COMPLETE LAYOUT AND ALL PAVER DIMENSIONS.

GRANITE BAND PAVING

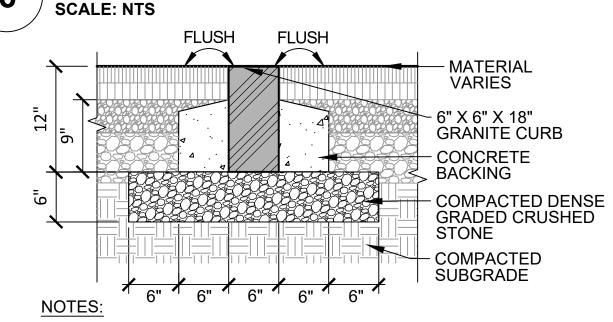


- CONTRACTOR TO SUBMIT SHOP DRAWINGS INDICATING ALL
- DIMENSIONS AND FINISHES. 2. TOP SHALL HAVE THERMAL FINISH

FLUSH GRANITE CURB

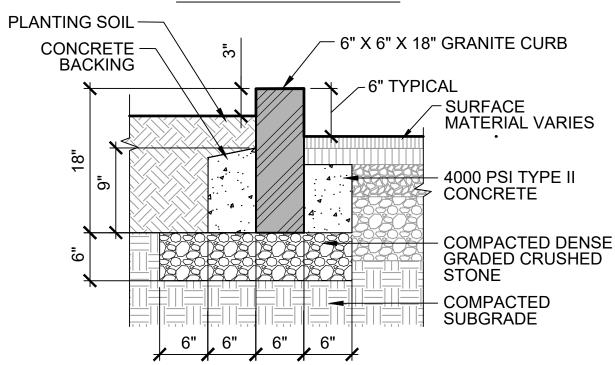


- REFER TO MASSDOT DETAIL E 106.3.0 FOR THE STATE STANDARD METHOD OF SETTING VERTICAL CURB. CONTRACTOR TO SUBMIT SHOP DRAWINGS.
 - VERTICAL GRANITE CURB

SECTION

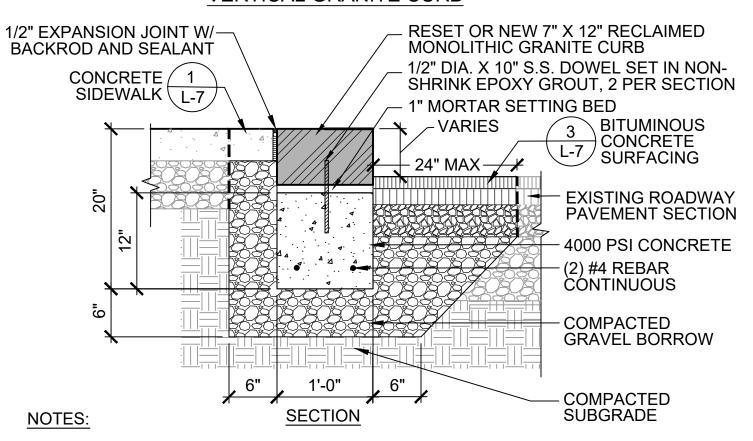

- EXISTING MONOLITHIC GRANITE CURB TO BE RESET. ANY NEW MONOLITHIC GRANITE CURBING SHALL MATCH THE SIZE AND CHARACTER OF EXISTING VERTICAL CURB. NEW MONOLITHIC GRANITE CURB SHALL BE APPROVED BY THE OWNER'S REPRESENTATIVE PRIOR TO PROCUREMENT
- EXISTING CURBING DIMENSIONS MAY VARY, CONTRACTOR SHALL CONFIRM CURBING SIZE IN THE FIELD AND COORDINATE INSTALLATION APPROACH WITH OWNER'S REPRESENTATIVE PRIOR TO SETTING CURB.

MONOLITHIC VERTICAL GRANITE CURB

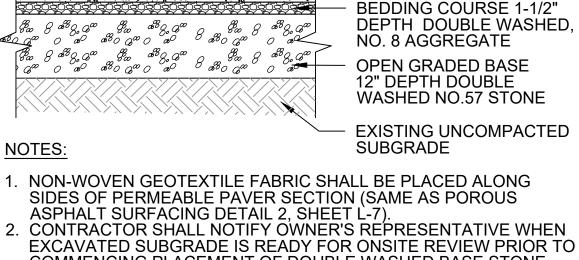

PERMEABLE JOINT OPENING DOUBLE

PERMEABLE PAVERS

2-3/4" THICK

NO 2 STONE

RESERVOIR

-NON-WOVEN

GEOTEXTILE

FABRIC, TYP.

COURSE

WASHED, NO. 9 AGGREGATE

SIDES OF PERMEABLE PAVER SECTION (SAME AS POROUS ASPHALT SURFACING DETAIL 2, SHEET L-7).

COMMENCING PLACEMENT OF DOUBLE WASHED BASE STONE. 3. DOUBLE WASHED STONE SHALL BE REVIEWED ON SITE BY OWNER'S REPRESENTATIVE. STONE WITH SEDIMENT SHALL BE

PERMEABLE UNIT PAVERS

- 4. CONTRACTOR SHALL COMPLETE TESTING AS REQUIRED IN SPECIFICATION SECTION 321443.11.
- 5. CONTRACTOR TO CONSTRUCT SAMPLE FOR APPROVAL BY OWNER'S REPRESENTATIVE PRIOR TO CONTINUING PAVER INSTALLATION.

SCALE: NTS

EXISTING

-IMPERMEABLE

SECTION AT WALL

1. IMPERMEABLE MEMBRANE SHALL BE PLACED

ALL SUBGRADE SHALL BE APPROVED BY THE

OWNER'S REPRESENTATIVE PRIOR TO ANY

TO WALL AS INDICATED ON PLANS.

-UNDISTURBED

SUBGRADE

MEMBRANE

WALL


NOTES:

SAWCUT PER PLAN APPLY TACK COAT – 1-1/2" HMA (9.5 MM) ON EXPOSED FACE TOP COURSE 2" HMA (12.5 MM) INTERMEDIATE/ BINDER COURSE **DENSE GRADED CRUSHED STONE** COMPACTED GRAVEL **BORROW SUBBASE** CONFORMING TO MADOT M1.03.00 TYPE B EXISTING SUBGRADE

SECTION

- 1. CONTRACTOR SHALL CONFIRM ALL SAWCUTTING LIMITS
- WITH OWNER'S REPRESENTATIVE PRIOR TO CUTTING. SAWCUT PAVEMENT SHALL RECEIVE TACK COAT ON EXPOSED FACE JOINT PRIOR TO PLACEMENT OF NEW BITUMINOUS CONCRETE SURFACING.
- 3. BITUMINOUS CONCRETE SURFACING INTENDED ONLY FOR ASPHALT PATCHING AREAS AS INDICATED ON PLANS.

BITUMINOUS CONCRETE 3 **SURFACING (FIRELANE)**

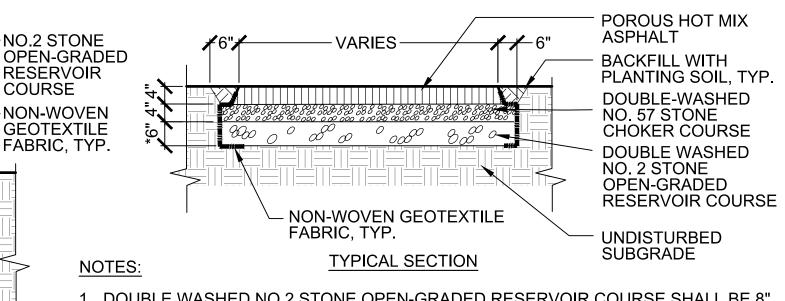


. DOUBLE WASHED NO.2 STONE OPEN-GRADED RESERVOIR COURSE SHALL BE 8" DEPTH ALONG MAIN MULTI-USE PATH FROM PEDESTRIAN BRIDGE TO FIRELANE. 2. DOUBLE WASHED STONE SHALL BE INSPECTED ONSITE BY OWNER'S

REPRESENTATIVE PRIOR TO PLACEMENT, STONE WITH ANY SEDIMENT OR DEBRIS SHALL BE REJECTED. CONTRACTOR SHALL TAKE CARE NOT TO COMPACT SUBGRADE WITH HEAVY AGAINST WALL VERTICALLY AND ALONG BOTTOM MACHINERY. ALL SUBGRADE SHALL BE APPROVED BY THE OWNER'S (BELOW RESERVOIR STONE) IN AREAS ADJACENT

REPRESENTATIVE PRIOR TO ANY AGGREGATE STONE PLACEMENT . CONTRACTOR SHALL COMPLETE ALL SUBGRADE AND SURFACE TESTING AS DEFINED IN SPECIFICATION SECTION 321243, POROUS HOT MIX ASPHALT . CONTRACTOR SHALL PROTECT WASHED STONE COURSES AND FINISHED POROUS HOT MIX ASPHALT SURFACE FROM SEDIMENT AND DEBRIS AT ALL

PLACMENT OF IMPERMEABLE LINER. 3. SEE SPEC SECTION 321243 FOR IMPERMEABLE TIMES, SEE SPECIFICATION SECTION 321243, POROUS HOT MIX ASPHALT POROUS ASPHALT SURFACING

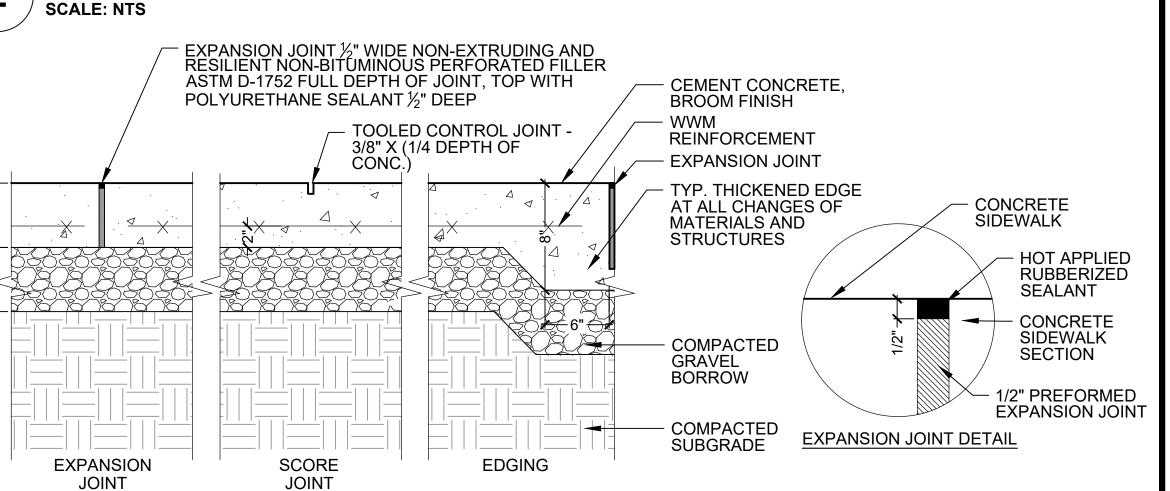

NOTES:

- TYP. E.J. SHALL BE USED WHENEVER HORIZONTAL CONCRETE AND/OR OTHER PAVING SURFACES MEET VERTICAL CONCRETE AND/OR MASONRY SURFACES. NOT MORE THAN 20' IN ANY DIRECTION OR AS SHOWN ON PLANS.
- 2. CONCRETE 4000 PSI TYPE II IN 28 DAYS.
- 3. EXPANSION AND CONTROL JOINTS SHALL FOLLOW SCORING PATTERN WHERE SHOWN ON PLANS. 4. PROVIDE EXPANSION JOINTS AT MIN. 20 FT. O.C. U.N.O. WITH PRE-FORMED JOINT FILLER.
- 5. CONCRETE FINISHED W/STIFF BRISTLED NYLON BROOM, PROVIDE BROOM FINISH IN DIRECTION PERPENDICULAR TO CURB.

CONCRETE SIDEWALK SCALE: NTS

SCALE: NTS Project: EN H $\overline{\geq}$ Ш

Client/Owner:

Massachusetts

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Recreation

Contract Number: P25-3586-C11	A
Hatch Project Number: H-371610	
Date: JUNE 30, 2025	
Drawn By: MP, JN	
Designed By: AK	
Reviewed By: JMB	
Scale: AS NOTED	

MP

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Revisions Description: Date: Number:


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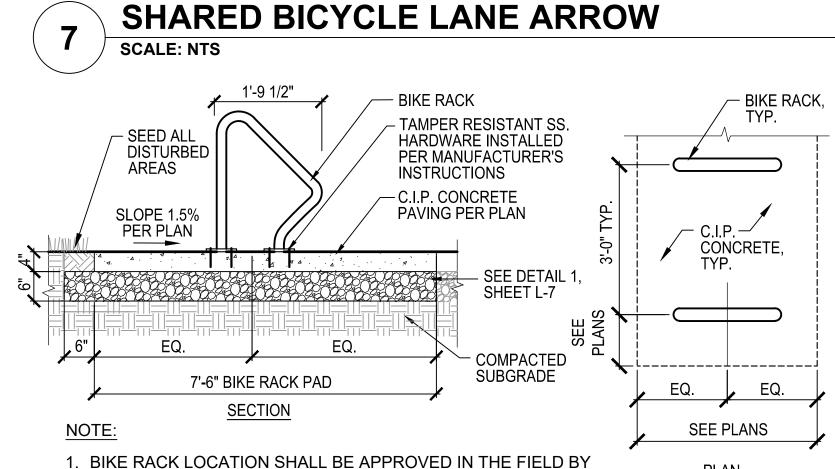
SITE **DETAILS**


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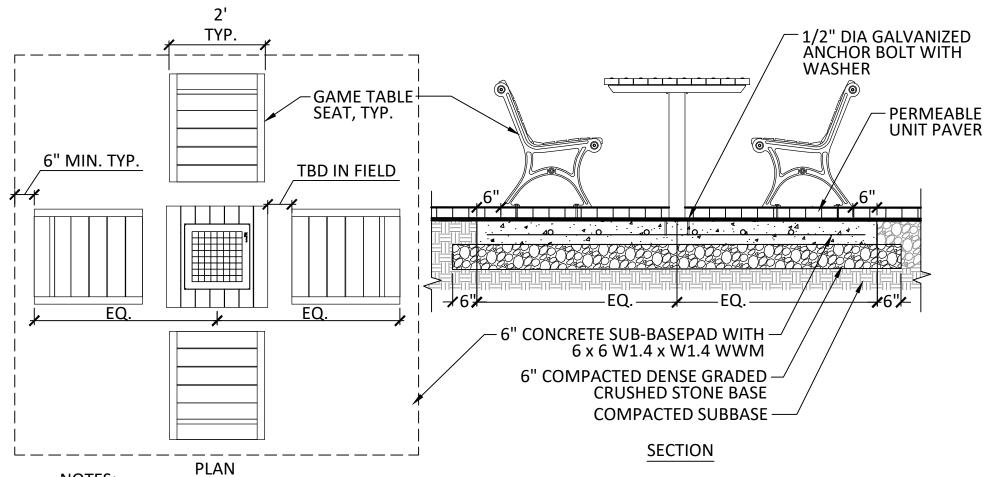
Sheet 8 of 21

Acc No: 104900x







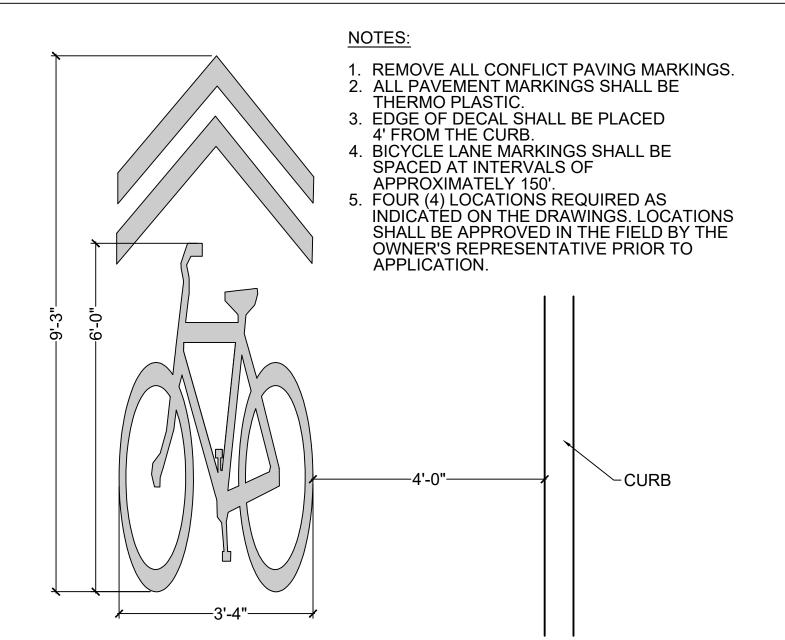

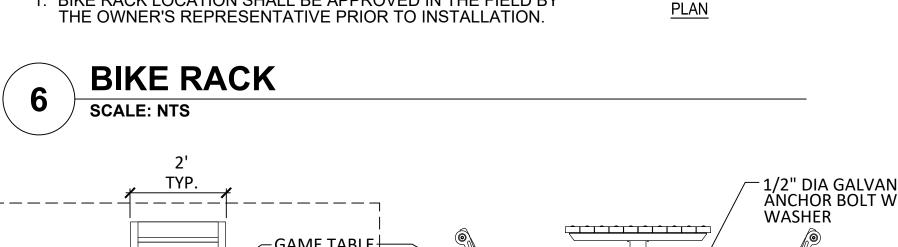

- 1. BENCHES SHALL BE PROVIDED FOR GAME TABLES AS INDICATED ON THE PLANS. ONE (1) GAME TABLE SHALL HAVE THREE (3) SEATS LEAVING ONE SPACE OPEN FOR WHEELCHAIR ACCESSIBLE POSITION.
- 2. CONTRACTOR TO SUBMIT SHOP DRAWINGS FOR REVIEW BY OWNER'S REPRESENTATIVE. 3. GAME TABLE LOCATIONS SHALL BE REVIEWED FOR APPROVAL BY THE OWNER'S REPRESENTATIVE IN THE FIELD PRIOR TO INSTALLATION.
- 4. SEE SPECIFICATION SECTION 32 33 00, SITE IMPROVEMENTS FOR MATERIALS, FINISHES, AND HARDWARE.

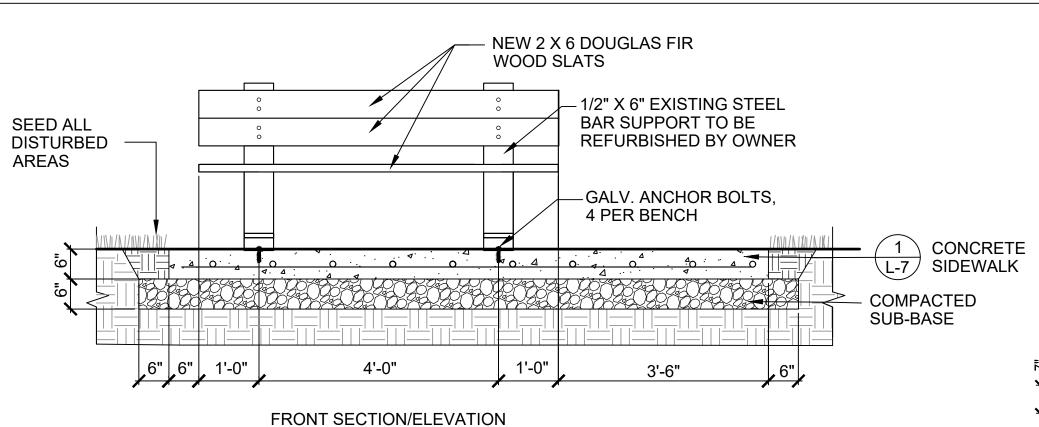

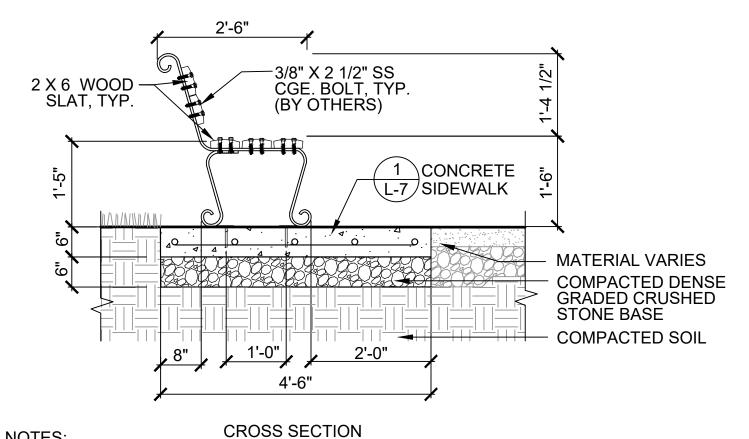

NOTES: CONTRACTOR SHALL DISMANTLE, STOCKPILE, DELIVER AND UNLOAD EXISTING


BENCH MATERIALS TO OWNER. CONTRACTOR SHALL PROVIDE AND DELIVER NEW LUMBER TO THE OWNER FOR REFURBISHING OF BENCHES. NEW LUMBER IS IN EXCESS OF QUANTITY NEEDED FOR NEW BENCHES, SEE SPECIFICATION SECTION, 32 33 00 SITE IMPROVEMENTS FOR TOTAL QUANTITY.

CONTRACTOR SHALL PICK UP AND TRANSPORT REFURBISHED BENCHES BACK TO THE PROJECT SITE FOR INSTALLATION.

ALL DCR BENCH PADS SHALL HAVE ACCESSIBLE COMPANION SEATING AREA. WELDED WIRE MESH (WWM) REINFORCING SHALL BE FLAT SHEET FORM-ROLLED. FORM WWM SHALL NOT BE ACCEPTED. SEE SPECIFICATION SECTION, 32 13 13 CONCRETE PAVING FOR WWM.

BENCH LOCATIONS SHALL BE APPROVED IN THE FIELD BY THE OWNER'S REPRESENTATIVE PRIOR TO FASTENING TO CONCRETE PAD.

DCR BENCH (SUPPLIED BY OWNER)

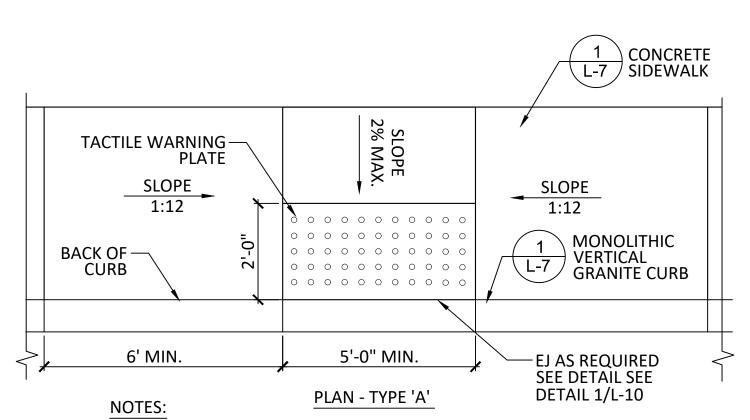

- 1. CONTRACTOR SHALL CONFIRM ALL EXISTING GRADES IN THE FIELD AND REPORT ANY INCONSISTENCIES TO THE OWNER'S REPRESENTATIVE.
- CONTRACTOR SHALL SUBMIT SHOP DRAWINGS FOR ALL CURB RAMPS. 3. SEE SHEET L-4 FOR GRADING PLAN.

ACCESSIBLE CURB RAMP

SCALE: NTS

SCHEDULE 40 **GALVANIZED STEEL** HANDRAIL, TYP. **RAILING** 1-1/2" TYP. -LOWER 2

→ RAILING VARIES, SEE PLAN _2"x1/4" GALVANIZED STEEL MOUNTING BRACKET, WELDED TO POST, TYP. <u>PLAN</u> CONTRACTOR SHALL SUBMIT SHOP DRAWINGS OF ALL FULL RAILINGS LENGTHS FOR APPROVAL BY OWNER'S REPRESENTATIVE PRIOR TO PROCUREMENT OF MATERIALS SEE SPECIFICATION SECTION, 055200 MISCELLANEOUS METALS. RAIL **EXTENDS** — 1'-0" -SCHEDULE 40 GALVANIZED PAST EDGE STEEL HANDRAIL OF RAMP

ACCESSIBLE RAMP HANDRAIL SCALE: NTS


HANDRAIL END ENLARGEMENT

RAIL PARALLEL

TO RAMP

RAIL PARALLEL

TO LANDING

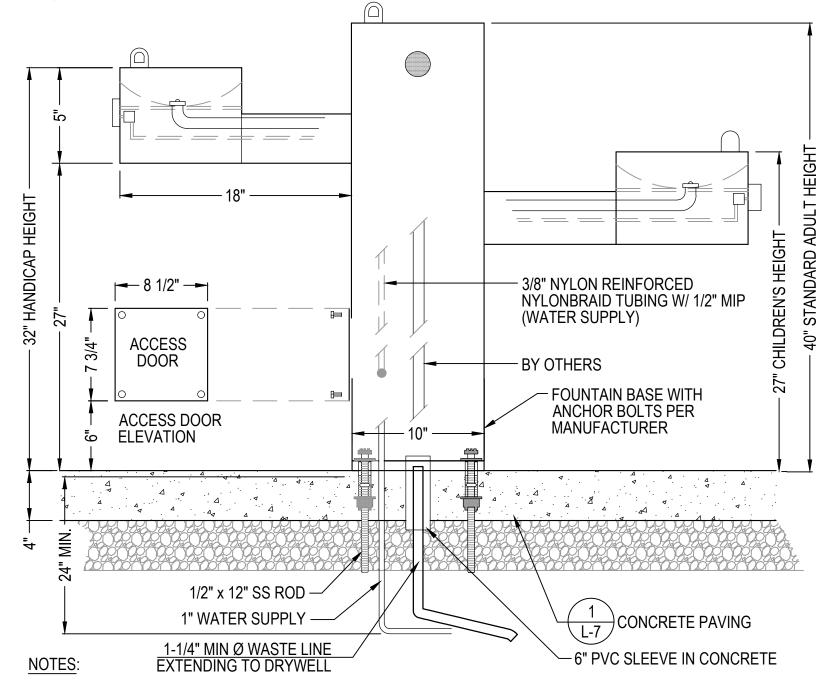

- DRINKING FOUNTAIN TO BE SUPPLIED BY THE OWNER, SEE SPECIFICATION SECTION, 32 33 00 SITE IMPROVEMENTS. DETAIL IS FOR REFERENCE ONLY. CONTRACTOR TO INSTALL PER MANUFACTURER'S INSTALLATION INSTRUCTIONS AND ALL APPLICABLE LOCAL CODES.
- CONTRACTOR SHALL PROVIDE SHOP DRAWINGS FOR APPROVAL BY OWNER'S REPRESENTATIVE
- 4. SEE DETAIL 8, L-9 FOR DRYWELL.

DRINKING FOUNTAIN ON CONCRETE PAD **SCALE: NTS**

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Date:

Contract Number: P25-3586-C11A Hatch Project Number: H-371610 Date: JUNE 30, 2025 Drawn By: RH, JN Designed By: EA, AK Reviewed By: JMB, EA Scale: AS NOTED

Revisions Description: Number:

Sheet Title:


SITE **DETAILS**

Sheet No:

Acc No:104901x Sheet 9 of 21


GAME TABLE WITH BENCHES SCALE: NTS

NOTES:

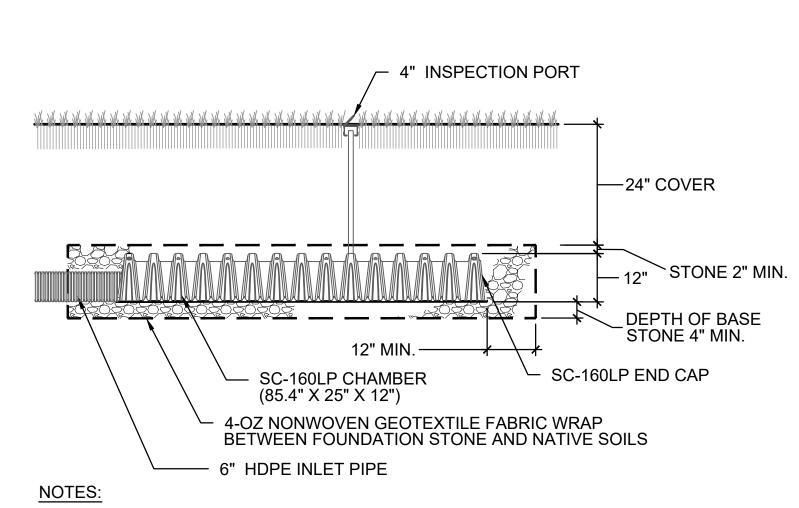

- 1. CONTRACTOR SHALL FLAG LOCATION OF DRYWELL IN THE FIELD FOR
- APPROVAL BY OWNER'S REPRESENTATIVE PRIOR TO EXCAVATION 2. CONTRACTOR SHALL PERFORM GROUNDWATER ELEVATION TEST PIT AND COORDINATE TEST PIT EXCAVATION AND TEST PIT RESULTS WITH THE
- OWNER'S REPRESENTATIVE PRIOR TO CONSTRUCTING DRYWELL 3. CONTRACTOR SHALL SUBMIT SHOP DRAWINGS SHOWING ALL COMPONENTS
- AND CONNECTIONS PRIOR TO PROCUREMENT OF MATERIALS. 4. OWNER'S REPRESENTATIVE SHALL REVIEW EXCAVATED SUBGRADE FOR APPROVAL PRIOR TO INSTALLATION OF DRYWELL.

DRYWELL

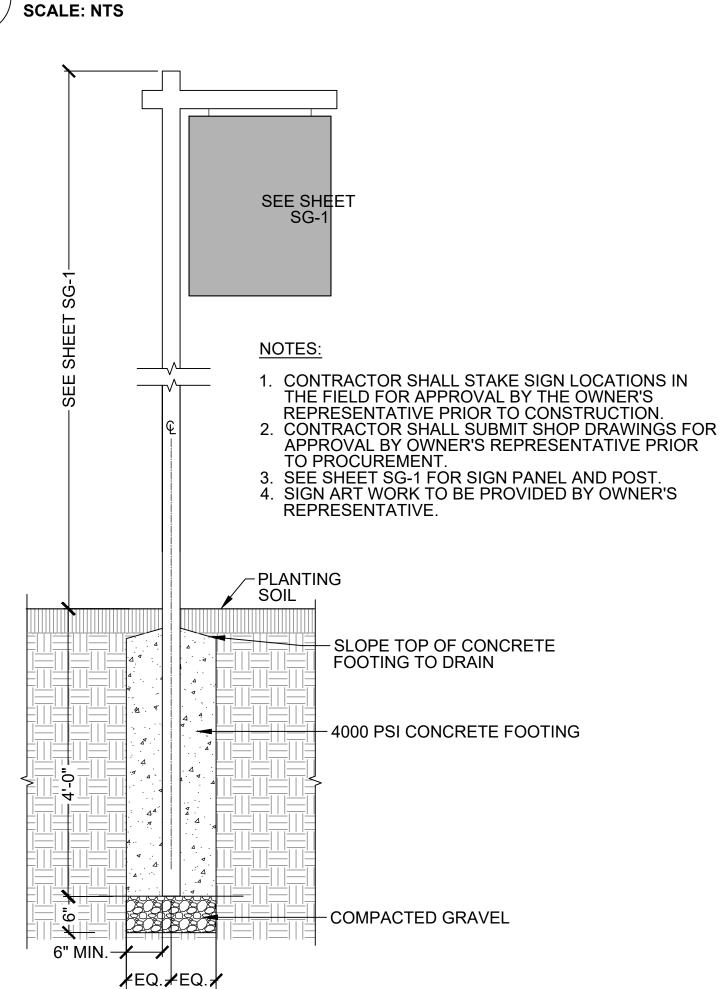

EROSION CONTROL BLANKET

SCALE: NTS

– SEE SHEET SG-2 — 🗡 INTERPRETIVE SIGNAGE PANEL SEE SHEET SG-2 REAR **FRONT** SEE SHEET SG-2 CAST-IN-PLACE -CONCRETE FINISH GRADE SIDE PROFILE -4000 PSI CONCRETE STONE, TYP. COMPACTED 4" CRUSHED STONE SUBBASE - COMPACTED SUBGRADE FRONT SECTION

NOTES: SEE SHEET L- 4 LAYOUT AND MATERIALS PLAN FOR SIGN LOCATIONS.

FINISH: SEE SHEET SG-2. SIGNAGE ARTWORK GRAPHIC TO BE PROVIDED BY OWNER'S REPRESENTATIVE.

CONTRACTOR RESPONSIBLE FOR MOUNTING PANEL IN SIGN.

SIGN AND PANEL SHALL BE GRAFFITI RESISTANT. CONTRACTOR SHALL SUBMIT SHOP DRAWINGS FOR APPROVAL BY OWNER'S REPRESENTATIVE.

INTERPRETIVE SIGNAGE

SCALE: NTS


PANEL - SEE SHEET **SEE SHEET** SG-2 TBD" - SEE SHEET SG-2 %" HEX HEAD BOLT, **NUT AND WASHER** - P 1. FOR PANEL AND ARTWORK SEE SIGN TYPE C, SHEET SG-2 -12" DIA. CONCRETE FOOTING, 4000 PSI, 2. ARTWORK: DIGITAL FILE TO BE 4'-0" MIN SLOPE TO DRAIN PROVIDED BY THE OWNERS REPRESENTATIVE. BASE POST -COMPACTED GRAVEL UNDISTURBED SUBGRADE

ALUMINUM SIGN AND POST

6" WOOD "ECO-STAKE" OR WRAP TOP EDGE OF MAT APPROVED EQUAL @ 24" INTO 6"WX6"D KEY TRENCH O.C. IN FIELD, TYP. SECURE WITH 6" STAKES @ 6" O.C. AND BACKFILL, TYP. SEED MIX, UNDER MAT SEE PLANTING PLAN L-5 **EROSION CONTROL MAT** FLUSH WITH FINISHED GRADE PLANTING SOIL

EROSION CONTROL MATTING SHALL BE PLACED ON ALL SLOPES 3:1 AND GREATER. 2. MATTING SHALL BE MADE OF NATURAL FIBER. REFER TO SPECIFICATION SECTION 329200, SODDING, SEEDING AND GRASSES.

CONCRETE PAD

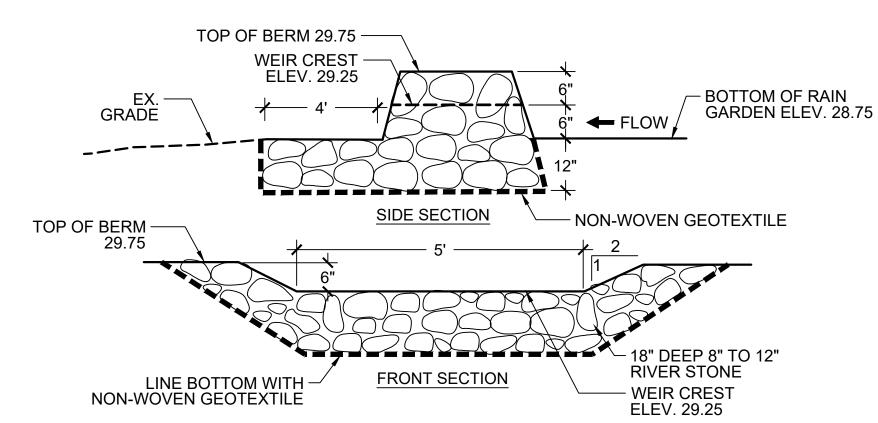


NOTE:

CONTRACTOR SHALL SUBMIT RIVER STONE FOR APPROVAL PRIOR TO PROCUREMENT.

BIORETENTION BASIN OUTLET


SCALE: NTS

SCALE: NTS

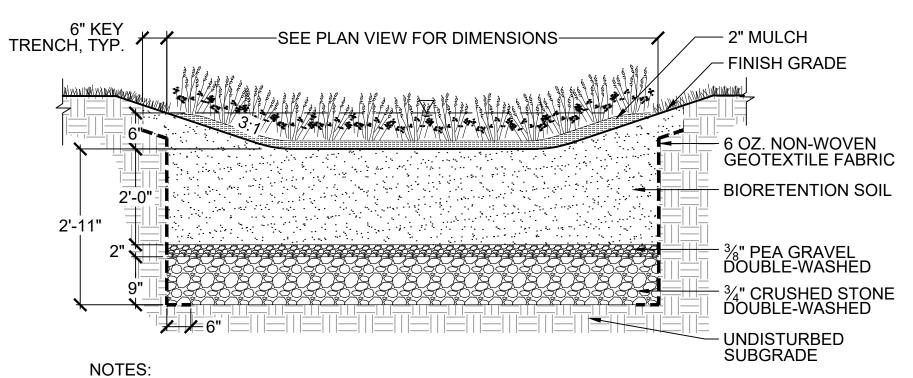

LIMITS OF BASIN SHALL BE STAKED IN FIELD BY CONTRACTOR FOR APPROVAL BY OWNER'S REPRESENTATIVE PRIOR TO COMMENCING EARTH DISTURBANCE.

BIORETENTION BASIN

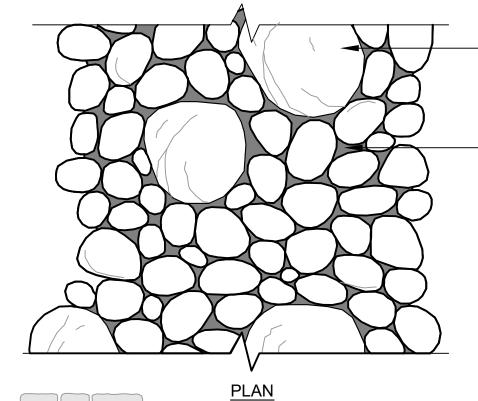

3'-0" WIDTH

SEE SHEET L-3

UNDISTURBED SUBGRADE

MBEDDED 8"-24" DIAMETER GRANITE RIVERSTONE HAND PLACED (TYP.)

-4"-6" DIAMETER RIVERSTONE COBBLE WITH SAND AND **GRAVEL MATRIX (TYP.)**

NOTES:

- HAND EXCAVATE TO 12" DEPTH ENTIRE WIDTH OF SWALE WHILE PROTECTING ROOTS GREATER THAN 1.5" IN DIA.
- 2. TIE NEW SWALE RIVERSTONE SNUGLY INTO EXISTING LARGE **BOULDERS AT BASE OF SWALE** OWNERS REPRESENTATIVE SHALL **REVIEW BOULDER LAYOUT**
- AND CONSTRUCTED SAMPLE 3. APPLY SAND/GRAVEL MATRIX OVER TOP OF SWALE TO LOCK RIVERSTONES INTO PLACE UPON COMPLETION.

GRANITE RIVERSTONE WITH SAND/GRAVEL MATRIX

LIMIT OF EXCAVATION

EMBEDDED 8"-24" DIAMETER

NON-WOVEN GEOTEXTILE FABRIC

INSTALL EXTRA WIDTH TO FLAP **OVER SWALE TO PROTECT FROM** SEDIMENTATION DURING PLANT ESTABLISHMENT PERIOD (ENOUGH TO OVERLAP TOP OF SWALE)

RIVERSTONE SWALE SCALE: NTS

Client/Owner:

Massachusetts



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Contract Number: P25-3586-C11A Hatch Project Number: H-371610 Date: JUNE 30, 2025 Drawn By: RH, JN

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Designed By: EA, AK Reviewed By: EA, JMB Scale: AS NOTED

Revisions

Description: Number:

Sheet Title:

SITE **DETAILS**

Sheet No:

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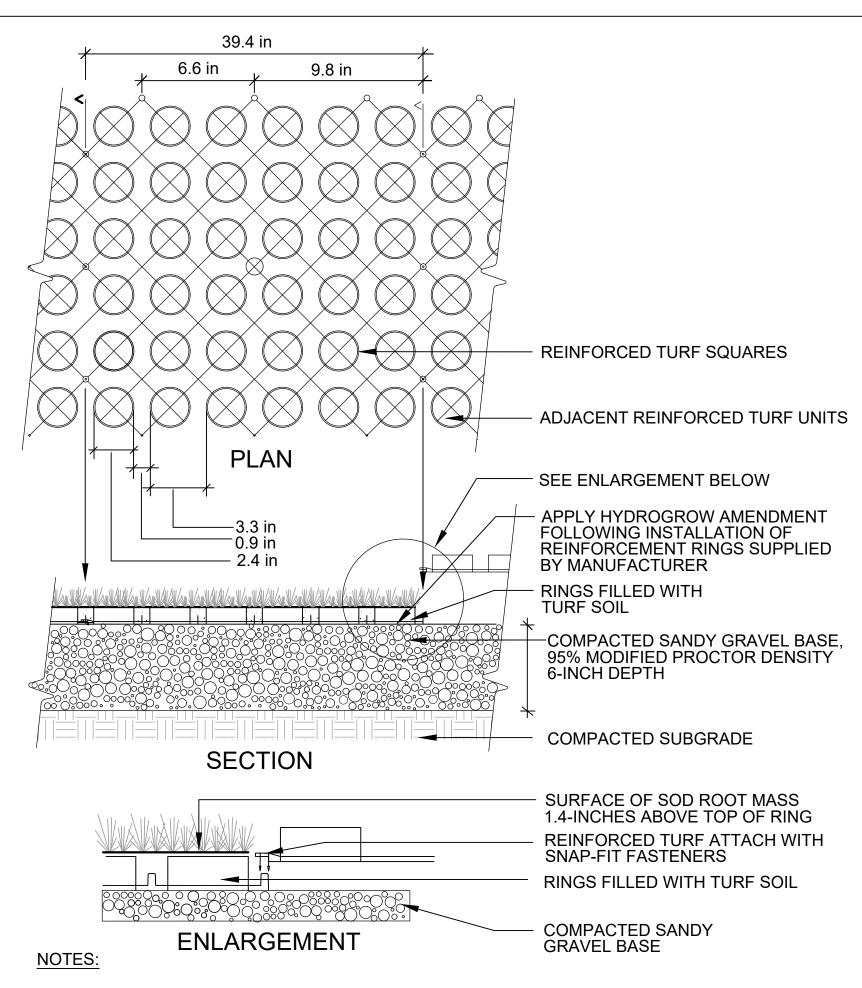
Sheet 10 of 21

PARK IDENTIFICATION SIGN **SCALE: NTS**

FOOTING


SCALE: NTS

NOTES:



- 1. VEGETATED COVER FOR REINFORCED TURF SHALL BE SOD, SEE SPECIFICATION SECTION, 329200 SODDING, LAWNS AND GRASSES
- 2. SEE MANUFACTURE INSTRUCTIONS FOR REINFORCED RING INSTALLATION AND CUTTING TECHNIQUE
- 3. REINFORCED SHOULDER SIZE VARIES. SEE LAYOUT AND MATERIALS PLAN. SHEET L-3.

REINFORCED TURF **SCALE: NTS**

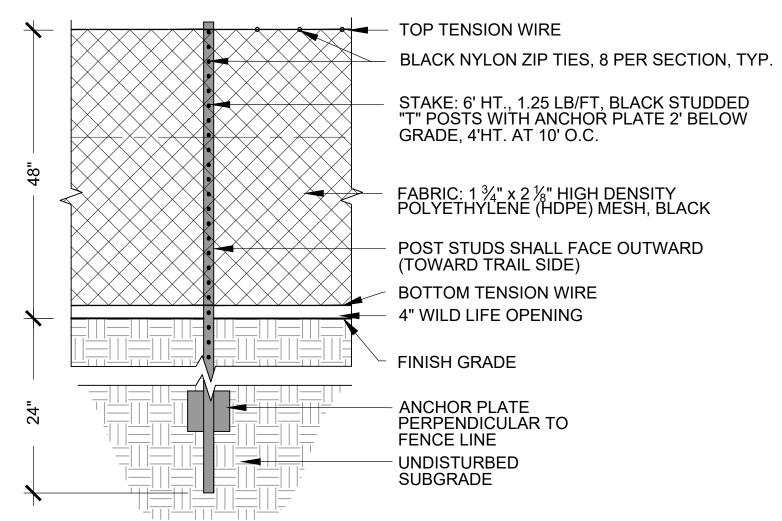


NOTES:

- FENCING SHALL BE IN PLACE IMMEDIATELY FOLLOWING COMPLETION OF PLANTING.
- 2. SECTIONS OF FENCE THAT BECOME LOOSE OR DAMAGED SHALL BE REPLACED IMMEDIATELY.
- 3. CONTRACTOR SHALL STAKE ALIGNMENT IN FIELD FOR APPROVAL BY OWNERS REPRESENTATIVE.

PLANT ESTABLISHMENT FENCE **SCALE: NTS**


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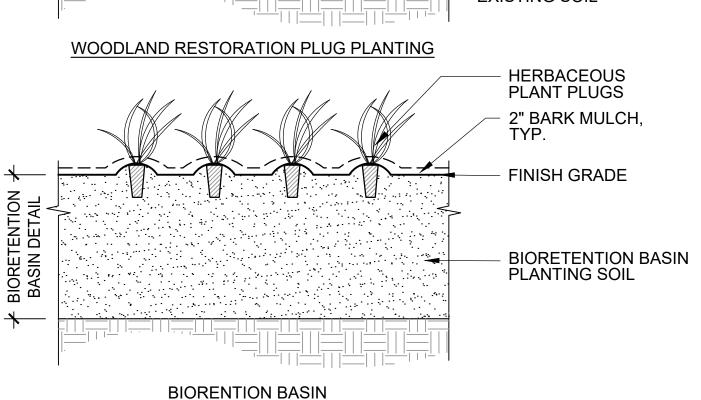
- 1. SEED ESTABLISHMENT FENCE SHALL BE IN PLACE IMMEDIATELY FOLLOWING APPLICATION OF SEED.
- 2. SEED ESTABLISHMENT FENCE SHALL REMAIN IN PLACE UNTIL SEED GERMINATION IS COMPLETE AND REMOVAL IS APPROVED BY THE OWNER'S REPRESENTATIVE
- 3. ANY SECTIONS OF SEED ESTABLISHMENT FENCE THAT BECOME DAMAGED SHALL BE REPLACED IMMEDIATELY.

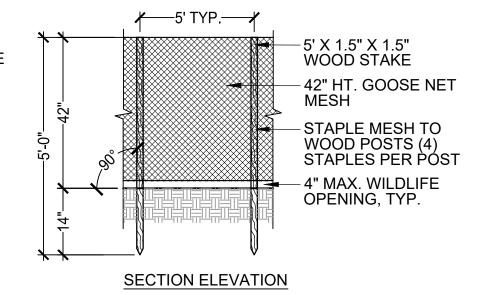

SEED ESTABLISHMENT FENCE


SCALE: NTS



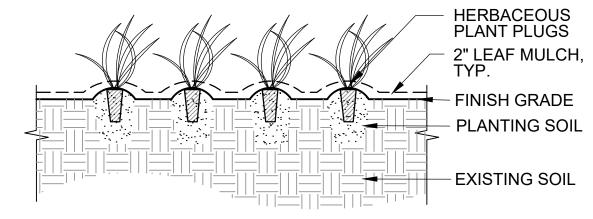

- 1. SEE PLANT SCHEDULE FOR PLUG SPACING.
- 2. CONTRACTOR SHALL BUTTERFLY CUT AND LOOSEN ROOTBOUND PLUGS PRIOR TO PLANTING
- 2. PLANTS TO BE LAID OUT IN THE FIELD BY THE CONTRACTOR AND LOCATIONS APPROVED BY THE OWNER'S REPRESENTATIVE PRIOR TO INSTALLATION.
- 3. CONTRACTOR MUST HAVE ALL REQUIRED FERTILIZER, MYCORRHIZAE, MULCH, AND WATER ON SITE AT THE TIME OF PLANTING AS DEFINED IN SPECIFICATION SECTION 329300, OR PLANTING SHALL NOT COMMENCE
- 4. CONTRACTOR SHALL HAVE ALL APPROVED FENCING MATERIALS ON SITE AND READY FOR INSTALLATION IMMEDIATELY FOLLOWING COMPLETION (SAME DAY) OF PLUG PLANTING.

HERBACEOUS PLUG PLANTING

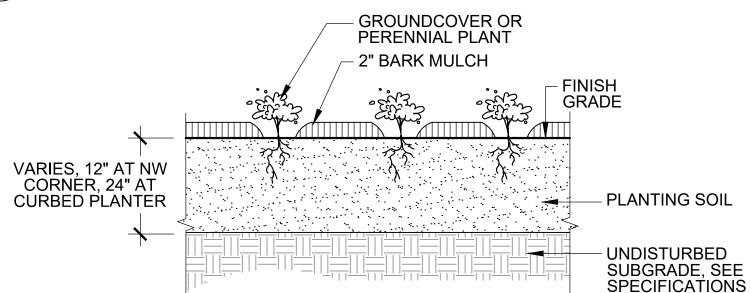


NOTES:

SCALE: NTS

- CONTRACTOR SHALL HAVE ALL REQUIRED FERTILIZER, MYCORRHIZAE, MULCH. AND WATER ON SITE AT THE TIME OF PLANTING AS DEFINED IN SPECIFICATION SECTION 329300, OR PLANTING SHALL NOT COMMENCE.
- 2. PLANTS TO BE LAID OUT IN THE FIELD BY THE CONTRACTOR FOR APPROVAL BY THE OWNER'S REPRESENTATIVE PRIOR TO INSTALLATION.
- 3. CONTRACTOR SHALL BUTTERFLY CUT AND LOOSEN ROOTBOUND PLANT MATERIAL PRIOR TO PLANTING.
- 4. CONTRACTOR SHALL HAVE ALL APPROVED FENCING MATERIALS ON SITE AND READY FOR INSTALLATION IMMEDIATELY FOLLOWING COMPLETION (SAME DAY) OF PLANTING.


HERBACEOUS PERENNIAL / **GROUNDCOVER PLANTING**

SCALE: NTS

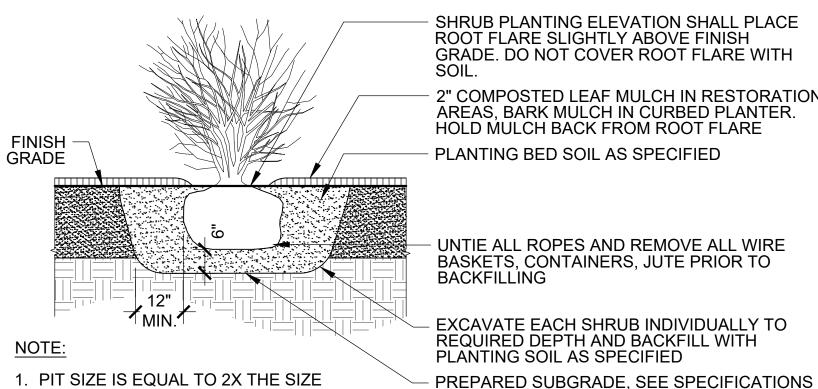


SHRUB PLANTING **SCALE: NTS**

OF THE ROOT BALL DIAMETER

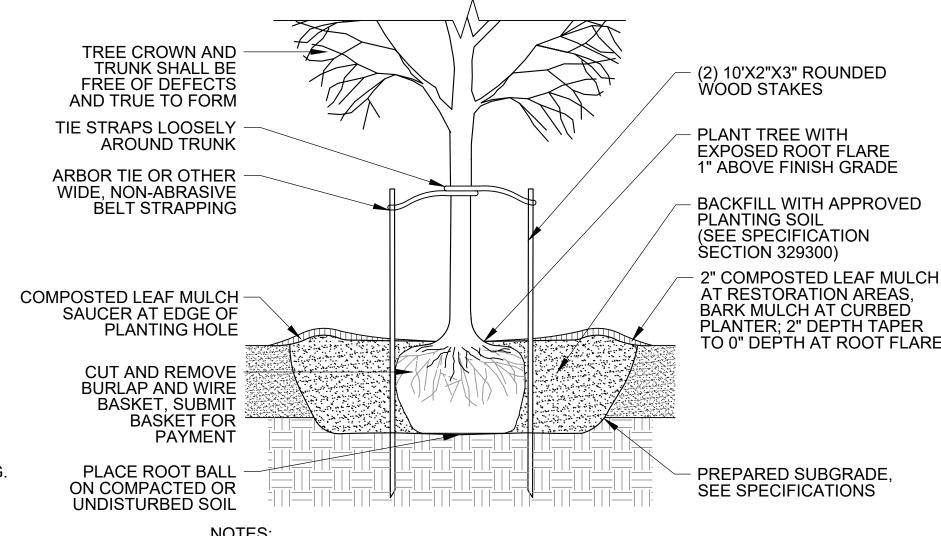

PIT SIZE IS EQUAL TO 3X THE SIZE OF THE ROOTBALL DIAMETER. CONTRACTOR SHALL STAKE TREE LOCATIONS IN THE FIELD FOR APPROVAL BY THE OWNER'S REPRESENTATIVE PRIOR TO COMMENCING ANY PLANTING OPERATIONS

TREE PLANTING

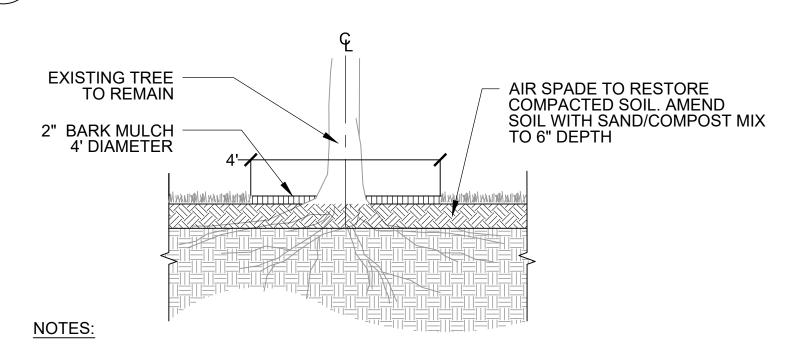

- REMOVE ALL WEEDS AND TRIM ALL SUCKERS FLUSH PRIOR TO TREATMENT.
 PREPARE AND AIRSPADE SOIL TO LOOSEN SOIL AROUND EXISTING ROOTS PER SPECIFICATION SECTION, 024100 SITE PREPARATION, AMEND EXISTING SOIL WITH SAND/COMPOST MIX PER SPECIFICATION SECTION 32 91 13 PLANTING SOILS.
 3. THIS TREATMENT APPLIES TO EXISTING TREES AS SHOWN ON SHEET L-2, SITE
- PREPARATION PLAN. 4. SEE PLANTING PLAN SHEET L-5 FOR SEED MIX.

EX. TREE SOIL DECOMPACTION & AMENDMENT (6" DEPTH, FULL ROOT ZONE TO DRIPLINE) SCALE: NTS

2" COMPOSTED LEAF MULCH IN RESTORATION

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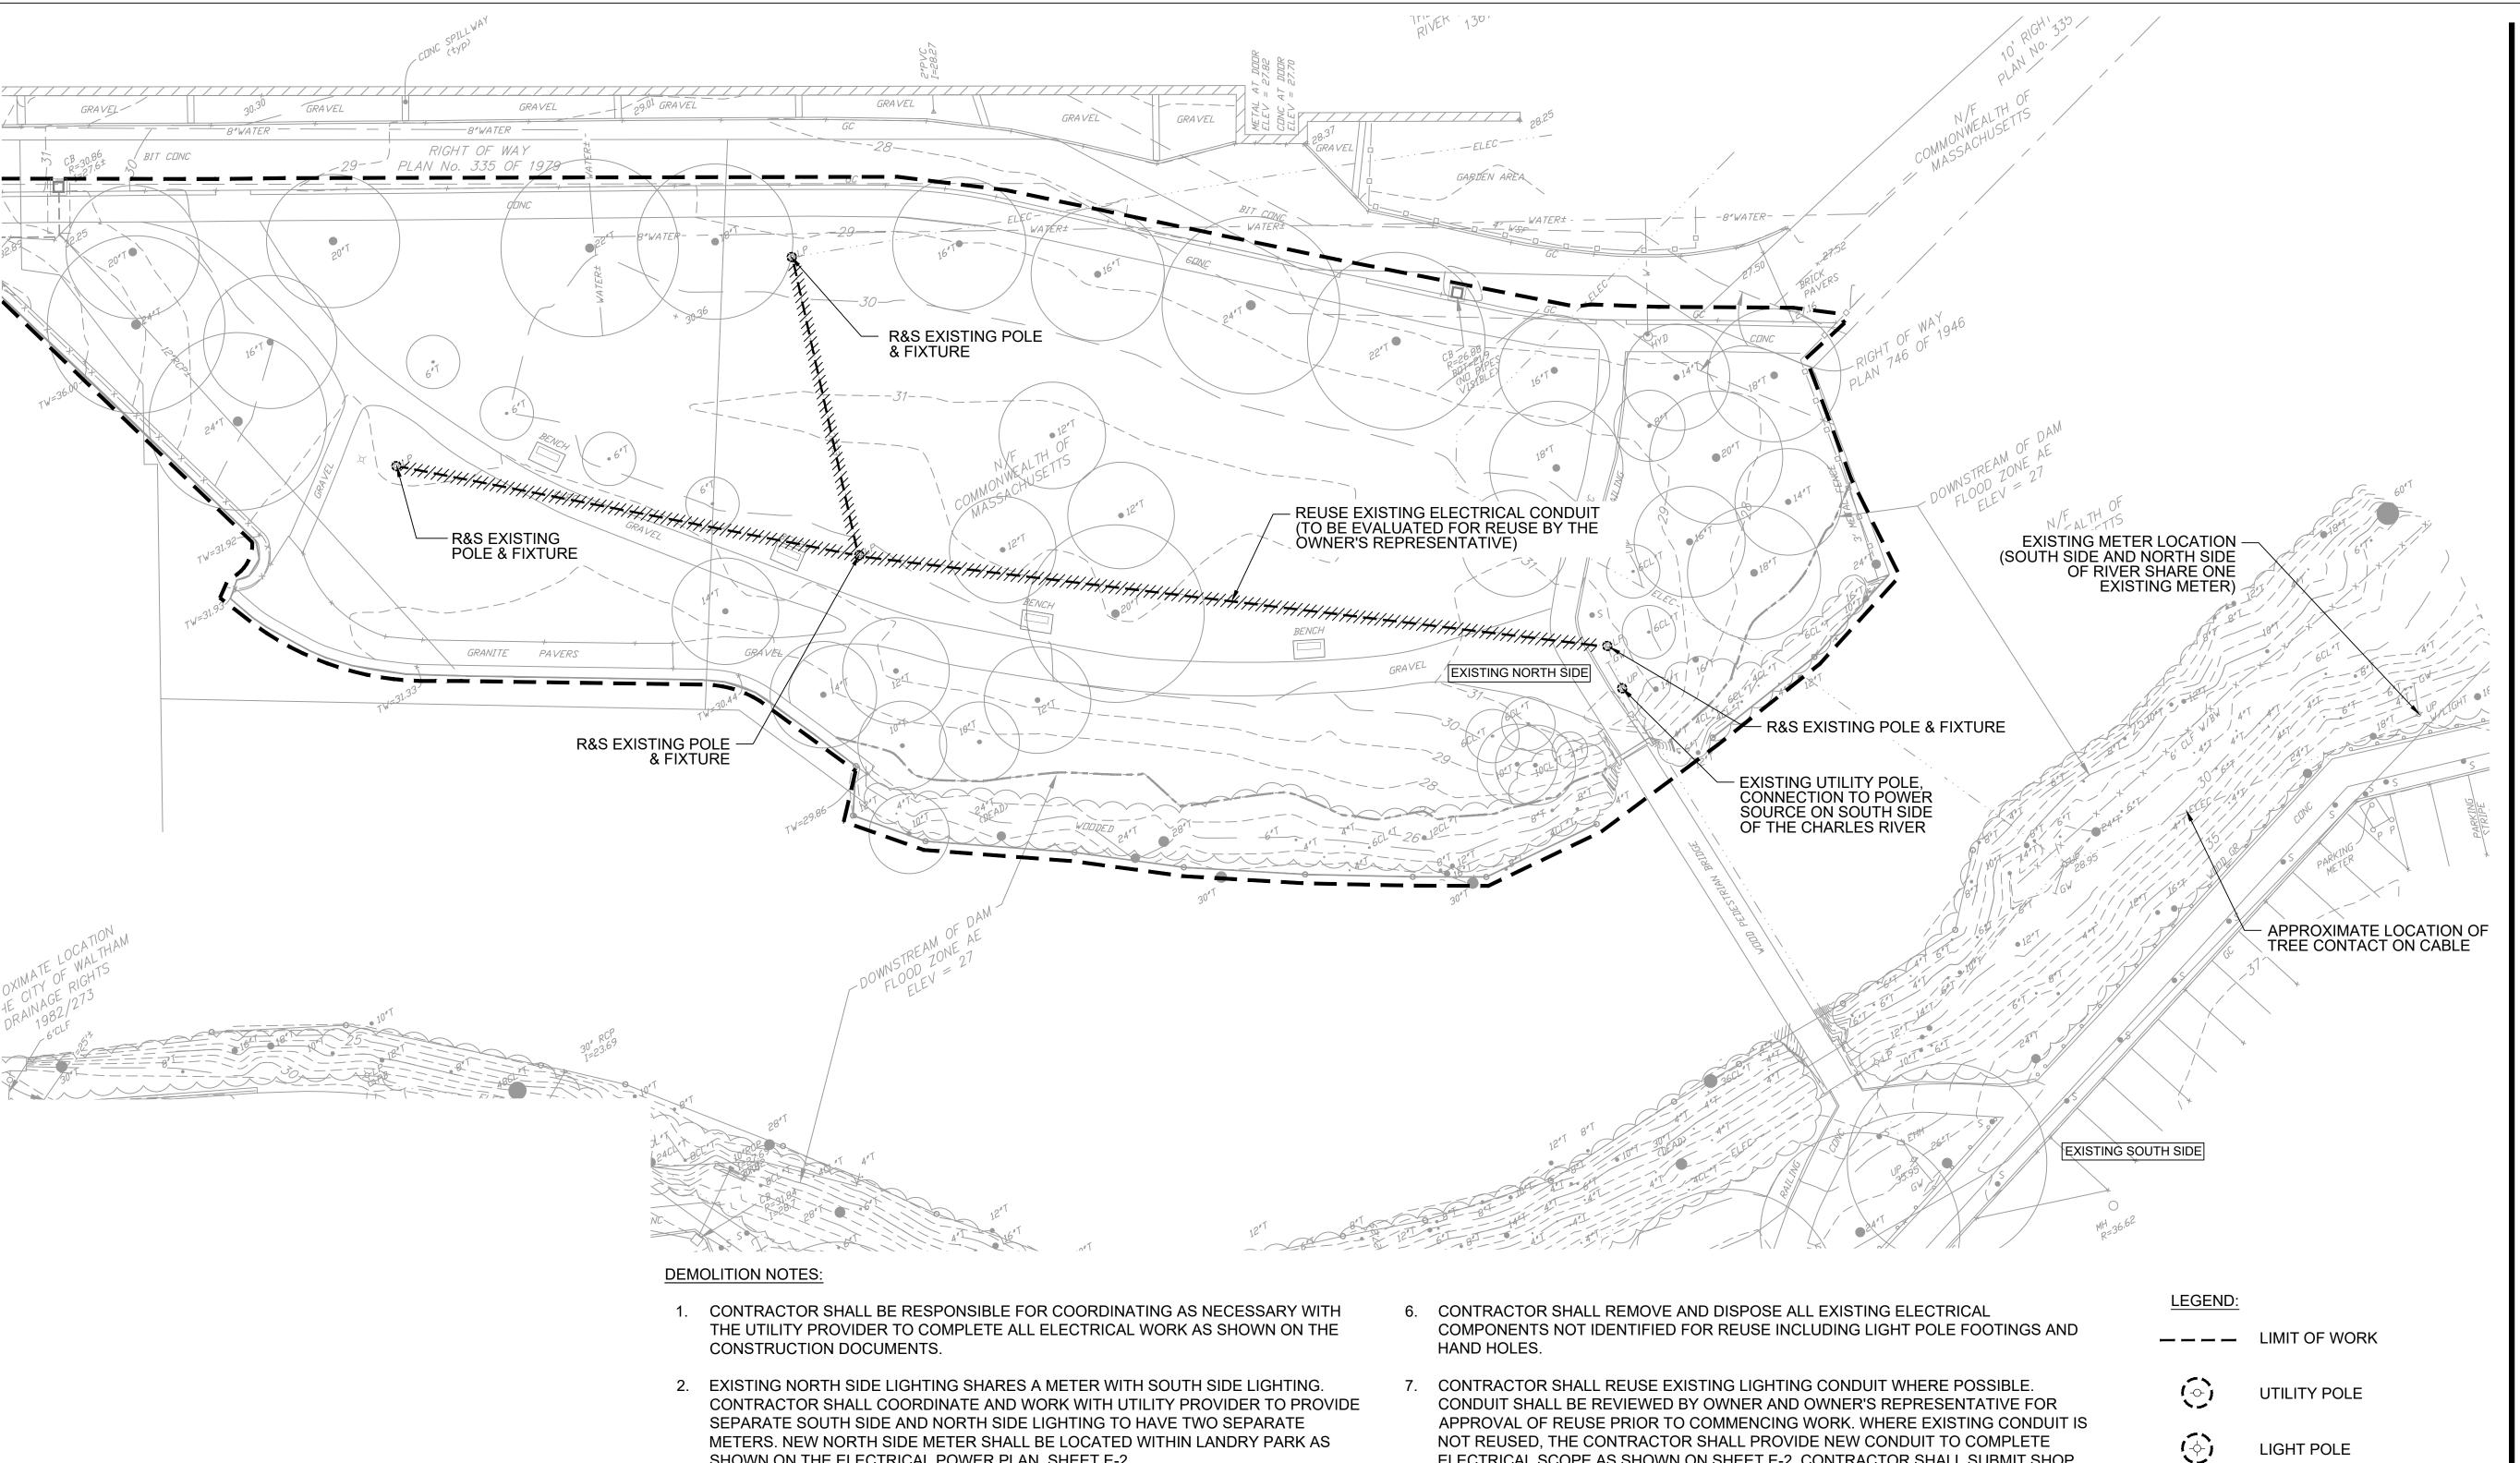
Contract Number: P25-3586-C11A Hatch Project Number: H-371610 Date: JUNE 30, 2025 Drawn By: JN Designed By: AK Reviewed By: JMB Scale: AS NOTED Revisions Description: Number:

> **PLANTING DETAILS**

Sheet Title:

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- SHOWN ON THE ELECTRICAL POWER PLAN, SHEET E-2.
- 3. IT IS ASSUMED THE EXISTING LIGHT FIXTURES ON THE NORTH SIDE ARE FED FROM A PANEL MOUNTED ON A UTILITY POLE LOCATED ON THE SOUTH SIDE OF THE RIVER AS SHOWN. CONTRACTOR SHALL FIELD VERIFY CIRCUITS AND DEMOLISH CABLES BACK TO THE NORTH SIDE UTILITY POLE AS SHOWN.
- 4. CONTRACTOR SHALL COORDINATE AND WORK WITH UTILITY COMPANY TO ADDRESS AND CORRECT NOTED TREE CONTACT ISSUE WHILE THE IMPROVEMENTS TO TWO METER REWIRING TAKE PLACE.
- 5. EXISTING LIGHT POLES AND FIXTURES SHALL REMAIN PROPERTY OF THE OWNER. THE CONTRACTOR SHALL TAKE CARE IN REMOVING EXISTING LIGHT POLES AND FIXTURES. CONTRACTOR SHALL DELIVER LIGHT POLES AND FIXTURES TO REGIONAL LOCATION DETERMINED BY DCR. CONTRACTOR SHALL TAKE CARE TO PROTECT ALL STOCKPILED ITEMS DURING REMOVAL, LOADING AND TRANSPORTING. THE CONTRACTOR SHALL BE RESPONSIBLE FOR UNLOADING AND STOCKPILING AT THE DCR DIRECTED LOCATION. CONTRACTOR SHALL SEND WRITTEN NOTIFICATION OF SCHEDULE FOR TRANSPORTATION AND DELIVERY TO DCR AND THE OWNER'S REPRESENTATIVE AT LEAST 2-WEEKS PRIOR TO COMMENCING ELECTRICAL DEMOLITION.
- ELECTRICAL SCOPE AS SHOWN ON SHEET E-2. CONTRACTOR SHALL SUBMIT SHOP DRAWINGS SHOWING LAYOUT OF ANY NEW CONDUIT FOR APPROVAL BY THE OWNER'S REPRESENTATIVE PRIOR TO EXCAVATION. CONTRACTOR SHALL MAKE ALL EFFORTS TO AVOID EXISTING TREE ROOT ZONES/DRIPLINES WITH LAYOUT OF NEW CONDUIT.
- 8. ALL EXISTING LIGHT FIXTURES, POLE LOCATIONS AND UNDERGROUND CABLE RUNS, ARE APPROXIMATE, IT IS THE CONTRACTORS RESPONSIBILITY TO DETERMINE EXACT LOCATIONS AND REPORT ANY DISCREPANCIES TO THE OWNER'S REPRESENTATIVE PRIOR TO COMMENCING DEMOLITION ACTIVITIES.

+++/++/++ REUSE EXISTING CONDUIT

SCALE: 1" = 20'

Acc No: 104904x

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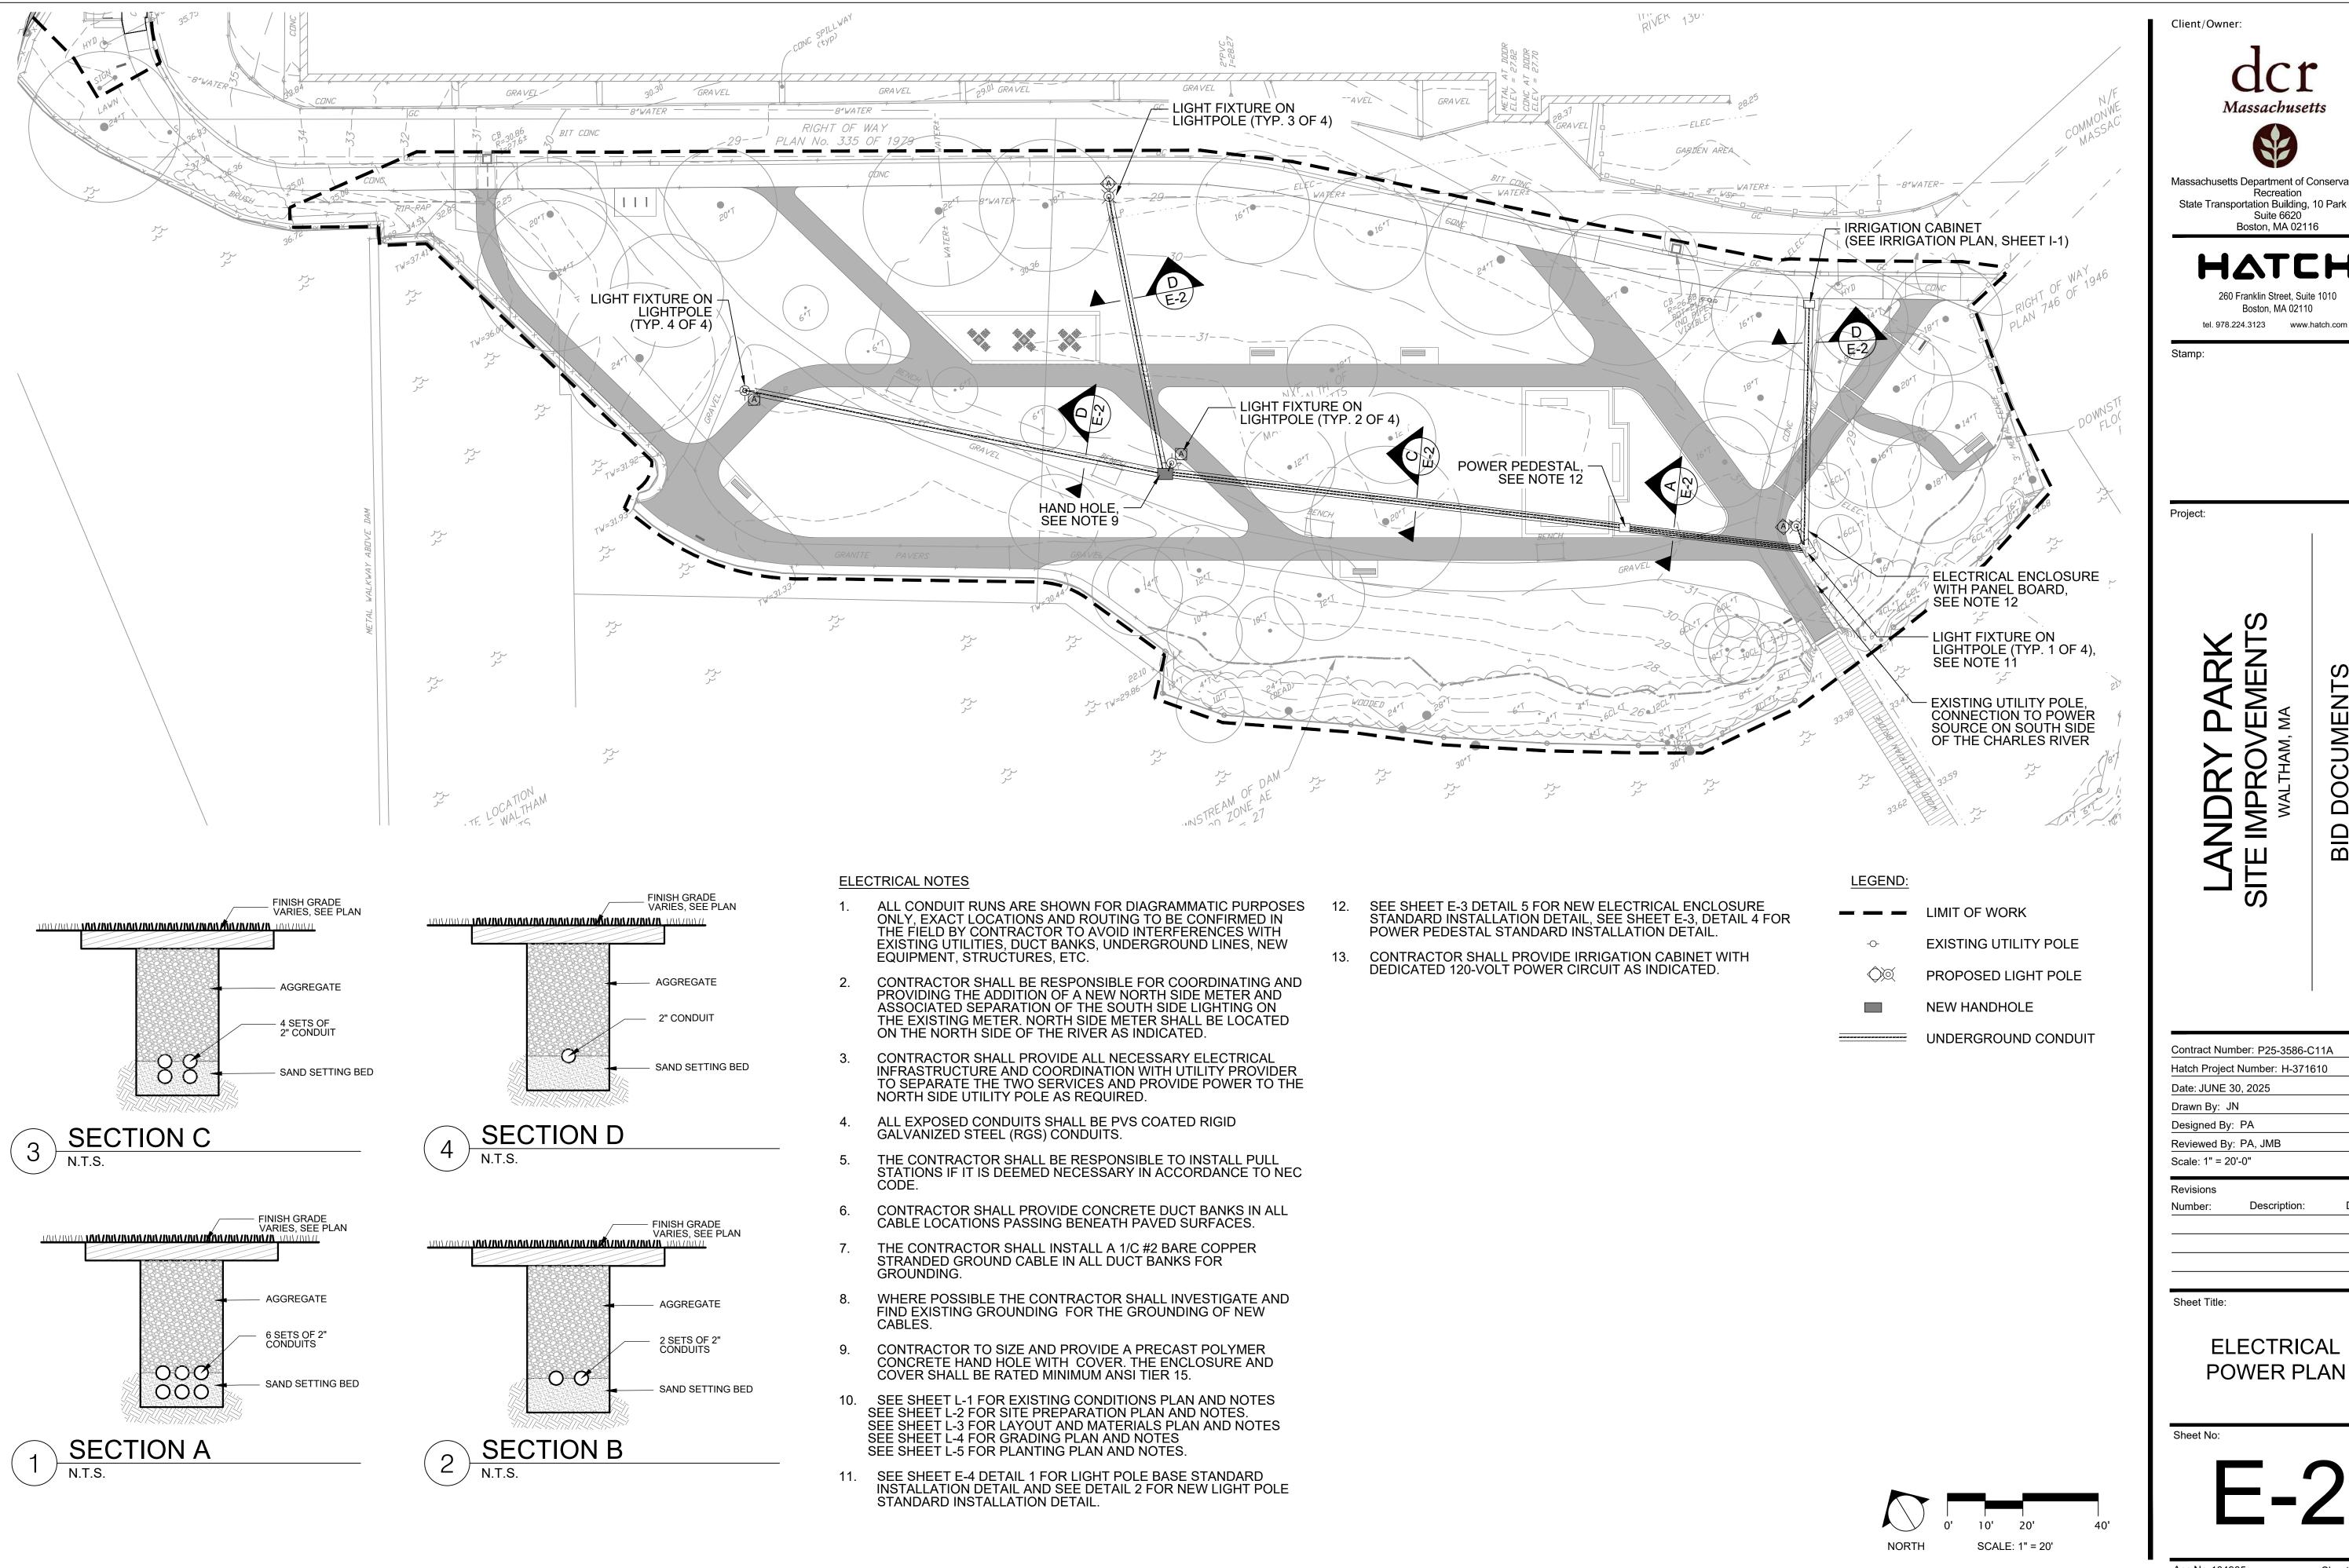
Designed By: PA Reviewed By: PA, JMB Scale: 1" = 20'-0"

Revisions

Description: Number:

Sheet Title:

ELECTRICAL DEMOLITION PLAN



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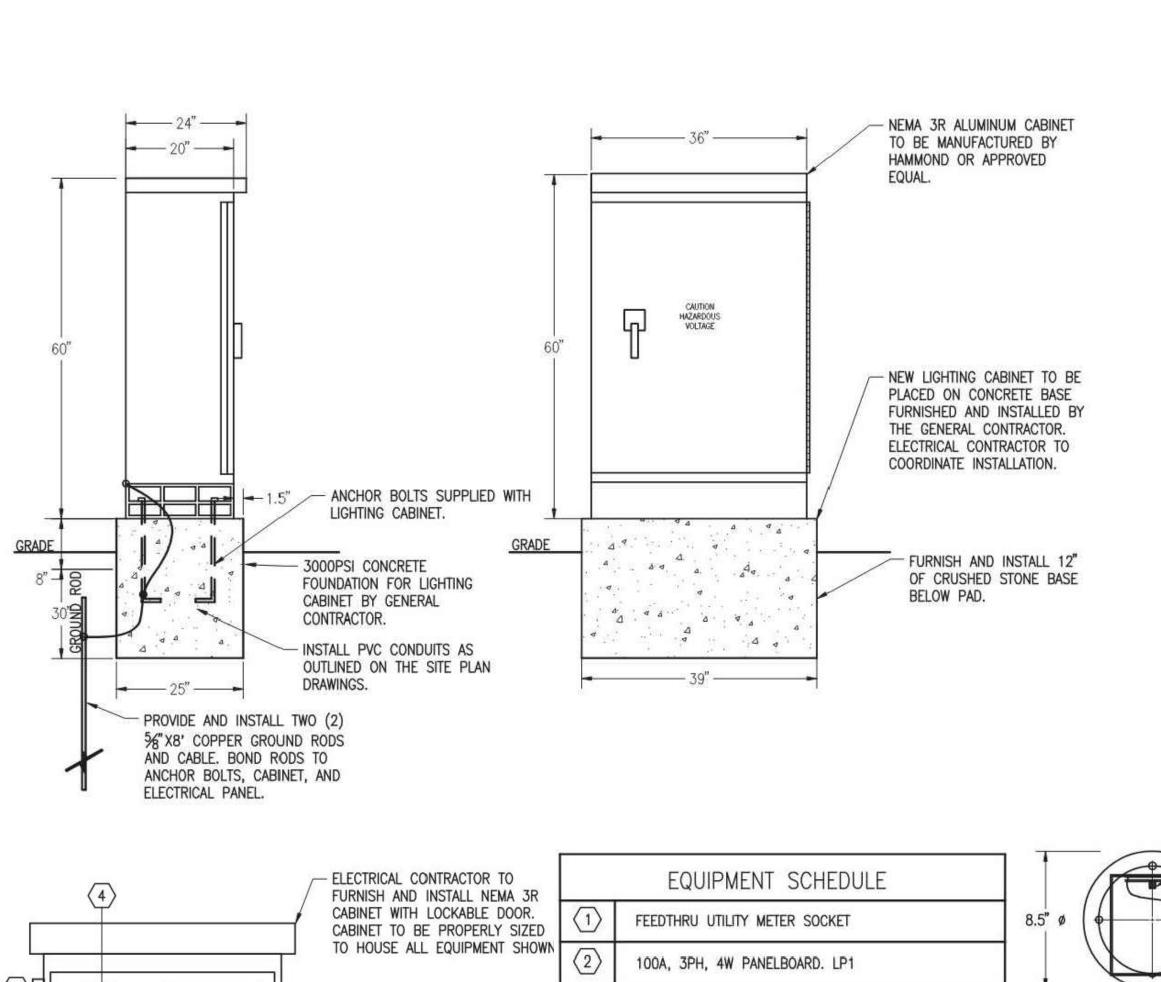
Contract Number: P25-3586-C11A


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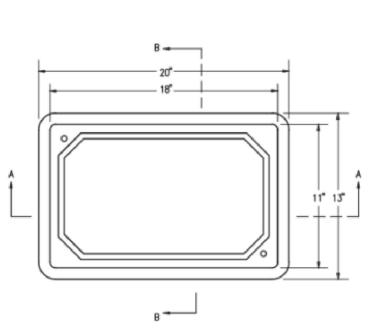
ELECTRICAL POWER PLAN


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ELECTRIC HANDHOLE DETAIL

HANDHOLE NOTES

EXIST. GRASS

REPLACE DISTURBED AREA —

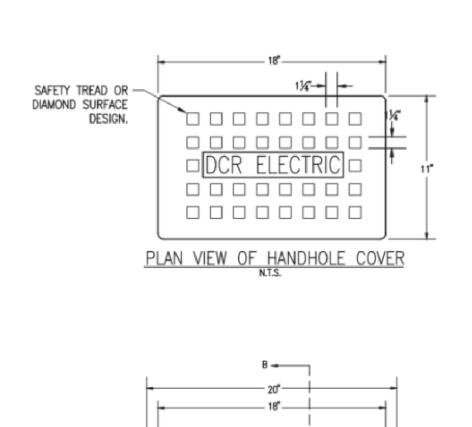WITH 4" LOAM & SEED

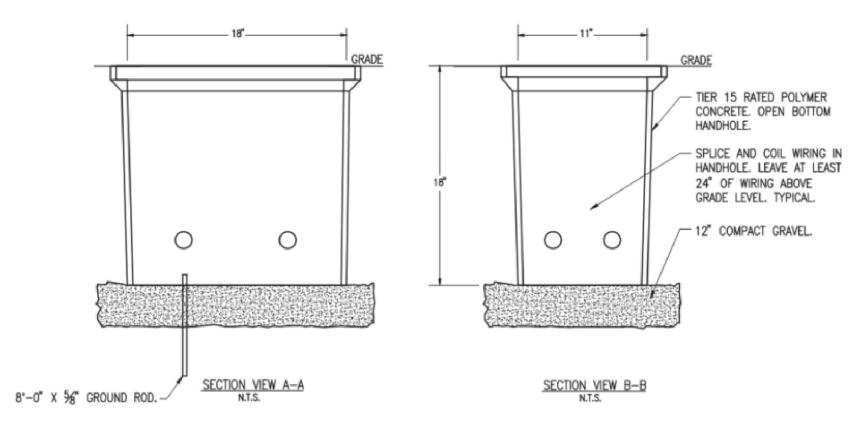CONCRETE -

PVC COATED RIGID GALVANIZED

STEEL CONDUIT ELBOW


ORDINARY BORROW

SURFACE

- 1 HANDHOLES TO BE SIZED PER CODE FOR CONDUITS ENTERING AND LEAVING EACH HANDHOLE. MINIMUM SIZE 11" X 18" X 18" DEEP UNLESS OTHERWISE NOTED. HANDHOLES SHALL BE TIER 15 RATED, POLYMER CONCRETE, OPEN BOTTOM, AND SHALL BE QUAZITE GP SERIES OR APPROVED EQUAL. COVERS TO BE FURNISHED WITH "ELECTRIC" ON THE COVER. FURNISH AND INSTALL 12" OF CRUSHED STONE BELOW HANDHOLES. FURNISH AND INSTALL MAGNETIC WARNING TAPE ABOVE ALL CONDUITS. COORDINATE EXACT LOCATION WITH GENERAL CONTRACTOR.
- 2 THE ELECTRICAL CONTRACTOR SHALL FURNISH AND INSTALL HANDHOLE AND COORDINATE INSTALLATION WITH LANDSCAPE ARCHITECT.


ELECTRICAL HAND HOLE N.T.S.

PLAN VIEW OF HANDHOLE

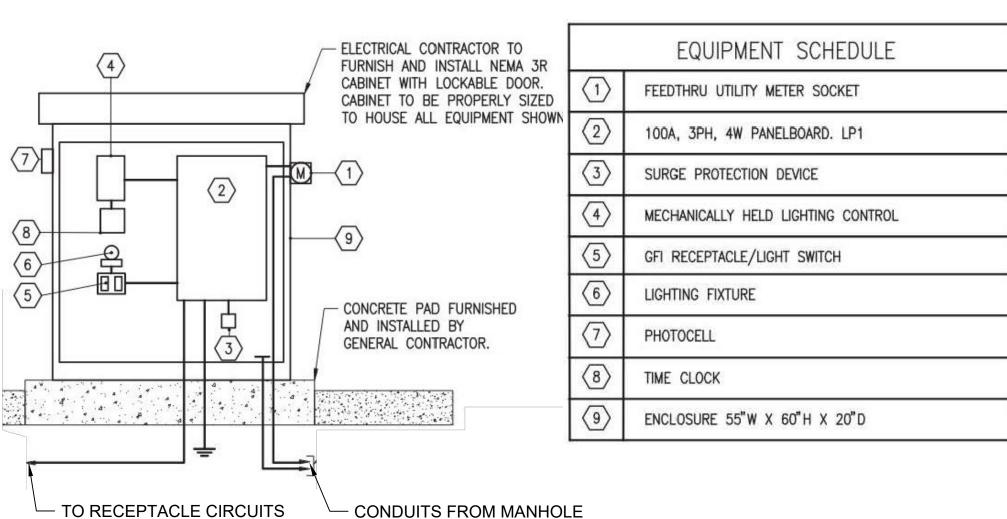

ELECTRICAL ENCLOSURE NOTES

- 1 THE ELECTRICAL CONTRACTOR SHALL FURNISH AND INSTALL THE ELECTRICAL ENCLOSURE AND ALL ACCESSORIES. ENCLOSURE SHALL BE CAST ALUMINUM OR SHEET ALUMINUM NEMA 3R ELECTRICAL ENCLOSURE - 36" X 60" X 20" WITH PAD LOCK LOCKABLE, HINGED DOORS, DARK GREEN COLOR, PER DCR ELECTRIC STANDARDS.
- 2 THE ELECTRICAL CONTRACTOR SHALL FURNISH AND INSTALL 100A, 120/240V, 1-PHASE, 3-WIRE SERVICE ENTRANCE RATED PANEL WITH CIRCUIT BREAKERS AS SHOWN. ELECTRICAL CONTRACTOR TO FURNISH AND INSTALL METER SOCKET AND 100A FEEDER FROM SOURCE. REFER TO SECONDARY ELECTRIC SERVICE NOTES, DWG E4.20.
- 3 ELECTRICAL CONTRACTOR SHALL FURNISH AND INSTALL TIME CLOCK, CONTACTOR, AND PHOTOCELL IN THE CABINET TO CONTROL LIGHTING CIRCUITS.
- 4 ELECTRICAL CONTRACTOR SHALL FURNISH AND INSTALL GFCI RECEPTACLE IN CABINET INCLUDING BRANCH CIRCUIT TO PANEL. FURNISH AND INSTALL A 24" LED LENSED STRIP TYPE LIGHTING FIXTURE INCLUDING SWITCH AND WIRING.
- 5 GENERAL CONTRACTOR TO PROVIDE CONCRETE PAD. TOP OF PAD MINIMUM OF 8" ABOVE GRADE, PROVIDE TWO GROUND ROD AND BOND TO CABINET AND PANEL ELECTRICAL CONTRACTOR TO COORDINATE INSTALLATION ON PAD.
- 6 FURNISH AND INSTALL ALL EQUIPMENT SHOWN IN DETAIL AND ALL ACCESSORIES AS REQUIRED.
- 7 COORDINATE WITH IRRIGATION FOR ALL IRRIGATION CONTROLLER CIRCUIT AND CONDUIT REQUIREMENTS.
- 8 ELECTRICAL CONTRACTOR TO VERIFY CABINET TO BE PROPERLY SIZED TO HOUSE ALL EQUIPMENT SHOWN.

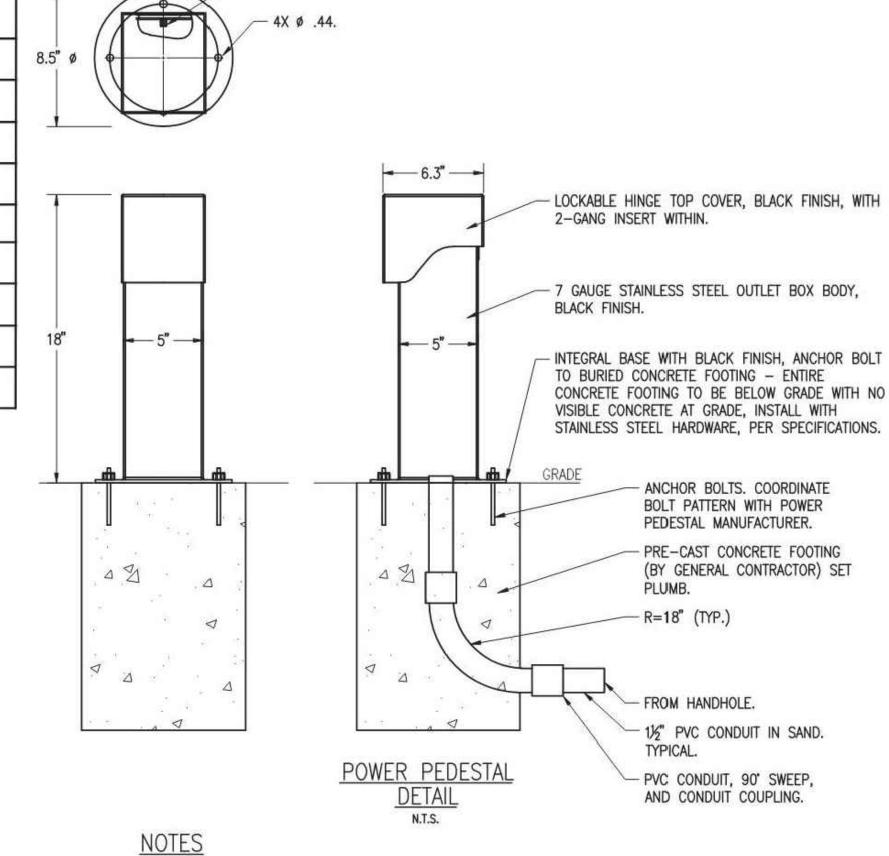

GROUND STUD.

- 1 POWER PEDESTAL SHALL BE 5"x5" STAINLESS STEEL OUTLET BOX PEDESTAL WITH LOCKABLE HINGE TOP IN-USE COVER AND INTEGRAL BASE. PEDOC #518HT-1 OR APPROVED EQUAL.
- 2 ELECTRICAL CONTRACTOR TO FURNISH AND INSTALL TWO DEDICATED 20A-1P WEATHER RESISTANT GFCI RECEPTACLES IN PEDESTAL ENCLOSURE PER MANUFACTURER'S REQUIREMENTS.

POWER PEDESTAL

(ALL STONES TO BE LESS THAN 3") 6" DETECTABLE METALLIC WARNING TAPE (SEE NOTE 3) CONDUIT SAND BEDDING **CONDUIT UNDER GRASS AREA** SPARE CONDUITS TO BE -STUBBED AND CAPPED PVC COATED RGS CONDUITS -QUANTITY AND SIZE OF CONDUITS PER PLAN DRAWING GRADE

CONDUIT TRANSITIONS AND STUB-UP

PVC COATED RIGID GALVANIZED STEEL CONDUIT

PVC SCHEDULE 80 CONDUIT

-PVC COATED RIGID GALVANIZED STEEL

CONDUIT COUPLING

Client/Owner:

Massachusetts



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Contract Number: P25-3586-C11A Hatch Project Number: H-371610 Date: JUNE 30, 2025 Drawn By: JN Designed By: PA

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Reviewed By: PA, JMB Scale: AS SHOWN

Revisions Number:

Description: Date:

Sheet Title:

ELECTRICAL

DETAILS

Sheet No:

Acc No: 104906x Sheet 14 of 21

ELECTRICAL ENCLOSURE

ELECTRICAL BILL OF MATERIALS						
TYPE	QTY.	DESCRIPTION				
A	4	KING LUMINAIRE - K728 MODERNE JR- LED TYE CAT NUMBER: K728-p4fl-III-40-7030-120				
В	4	LUMINAIRE "CROOK" STYLE ARM - KA15 POST TOP PENDANT MOUNT				
С	4	POLE - HAPCO, STAFFORD15 MOD				
D	1	ELECTRICAL PRECAST POLYMER CONCRETE HANDHOLE WITH MINIMUM RATED ANSI TIER 15 COVER. TO BE SIZED BY ELECTRICAL CONTRACTOR.				
E	1	POWER PEDESTAL				
F	1	ELECTRICAL ENCLOSURE				


CON	DUIT AND CABLE SCHEDULE	DESTINATION
1	2#10, & 1#10 GND2"C	TO VARIOUS LIGHT FIXTURES ON LIGHT POLES
2	2#12 &1#12	TO POWER PEDESTAL
3	2#12 &1#12	TO IRRIGATION CABINET

ELECTRICAL BILL OF MATERIALS / CONDUIT AND CABLE SCHEDULE

WATTS		PANELBOARD SCHEDULE 120/240 VOLT/1 PHASE/3 WIRE/MAIN BREAKER 100A/MAIN BUS 100A				WATTS					
PH	PH	DESCRIPTION	POLE	скт	0	0	СКТ	POLE	DESCRIPTION	PH	PH
0A	0B	DESCRIPTION	OLI	NO	9	$\overline{\gamma}$	NO	I OLL	DESCRIPTION	0A	0B
*		POLE 1 FIXTURE	1	1		00	2	1	POLE 2 FIXTURE	*	
	*	POLE 3 FIXTURE	1	3			4	1	POLE 4 FIXTURE		*
*		IRRIGATION CABINET	1	5		00	6	1	RECPTACLE PEDESTAL	*	
	*	SPARE	1	7			8	1	SPARE		*
*		SPARE	1	9			10	1	SPARE	*	
	*	SPARE	1	11			12	1	SPARE		*
	*	SUB TOTAL	•	•			•	•	SUB TOTAL	*	*
*	*	TOTAL	NOTES:								

- 1. ALL BRANCH CIRCUIT BREAKERS SHALL BE RATED 20AMP. UNLESS OTHERWISE NOTED.
- 2. GFCI-DENOTES GROUND FAULT CIRCUIT INTERRUPTER TYPE BRANCH CIRCUIT BREAKER

DISTRIBUTION PANEL-DP1

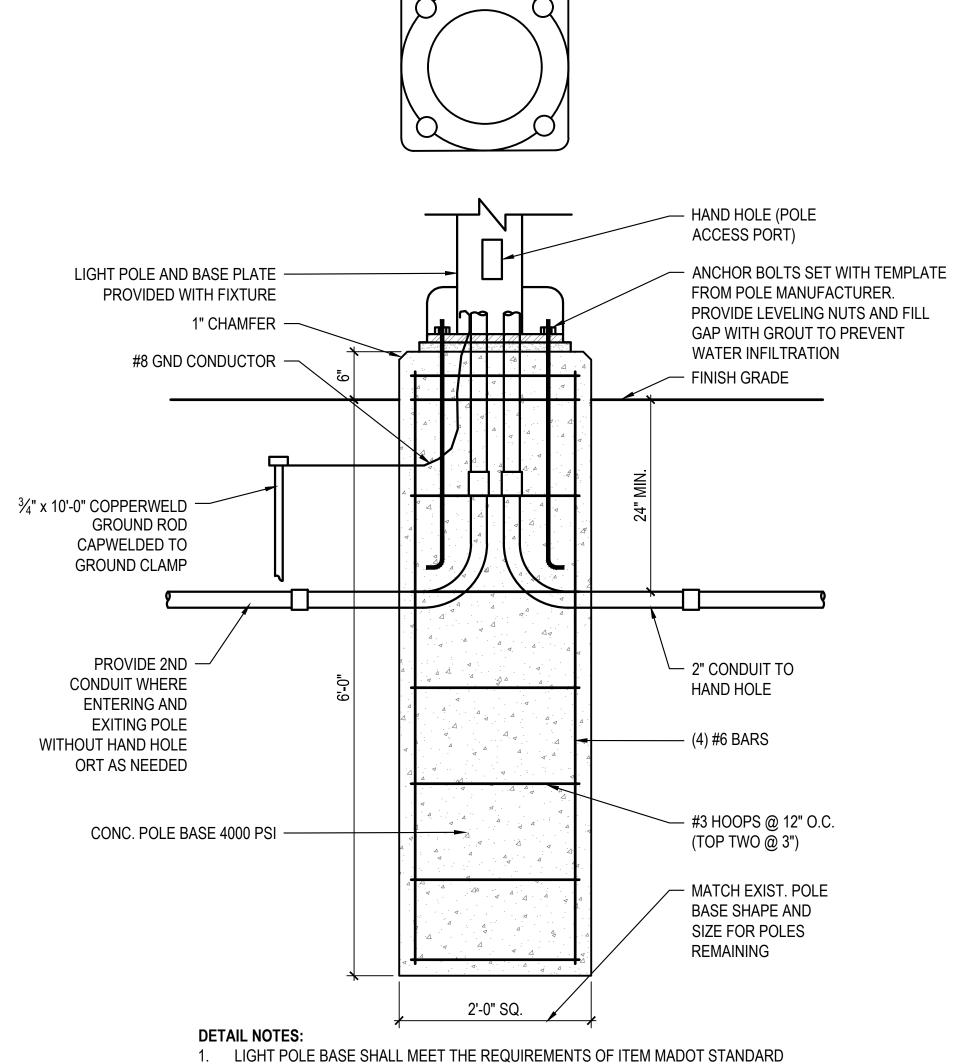

- SPECIFICATIONS FOR HIGHWAYS AND BRIDGES.
- 2. TYPICAL DIMENSIONS FOR REINFORCING PROVIDED FOR DESIGN INTENT. CONTRACTOR SHALL SUBMIT SHOP DRAWINGS STAMPED BY A MA LICENSED STRUCTURAL ENGINEER BASED UPON SOIL CONDITIONS, POLE HEIGHT, FIXTURE STYLE, AND 2020 LOAD CRITERIA.
- 3. INCLUDE COPPER CLAD GROUND ROD, A GROUNDING CLAMP, AND #8 RIBBON BRAID GROUND CONDUCTOR.



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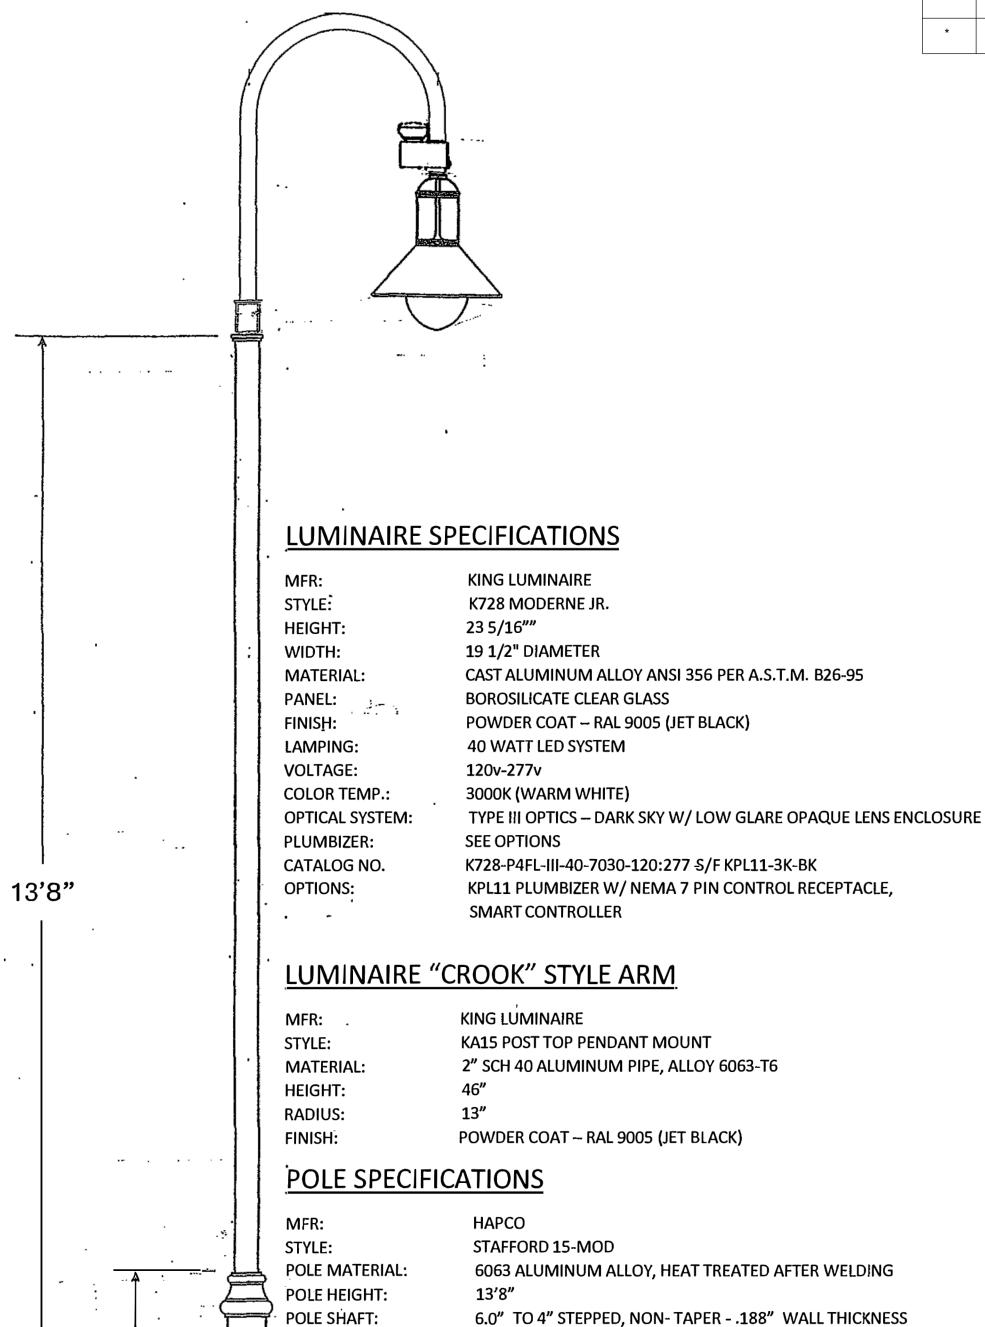
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ELECTRICAL DETAILS AND SCHEDULE

Acc No:104907x

Sheet 15 of 21



MOUNTING METHOD:

ACCESS DOOR:

ANCHOR BOLTS:

FINISH:

15"


LIGHT POLE TYPE B

ANCHOR BASE -- 9"-10" SLOTTED BOLT CIRCLE

3/4" X 30" X 3" HD GALV. F1554 GR55 STEEL

POWDERCOAT – RAL 9005 (JET BLACK)

3" X 5" W/ COVERANDINTERNAL GROUNDING PROVISION

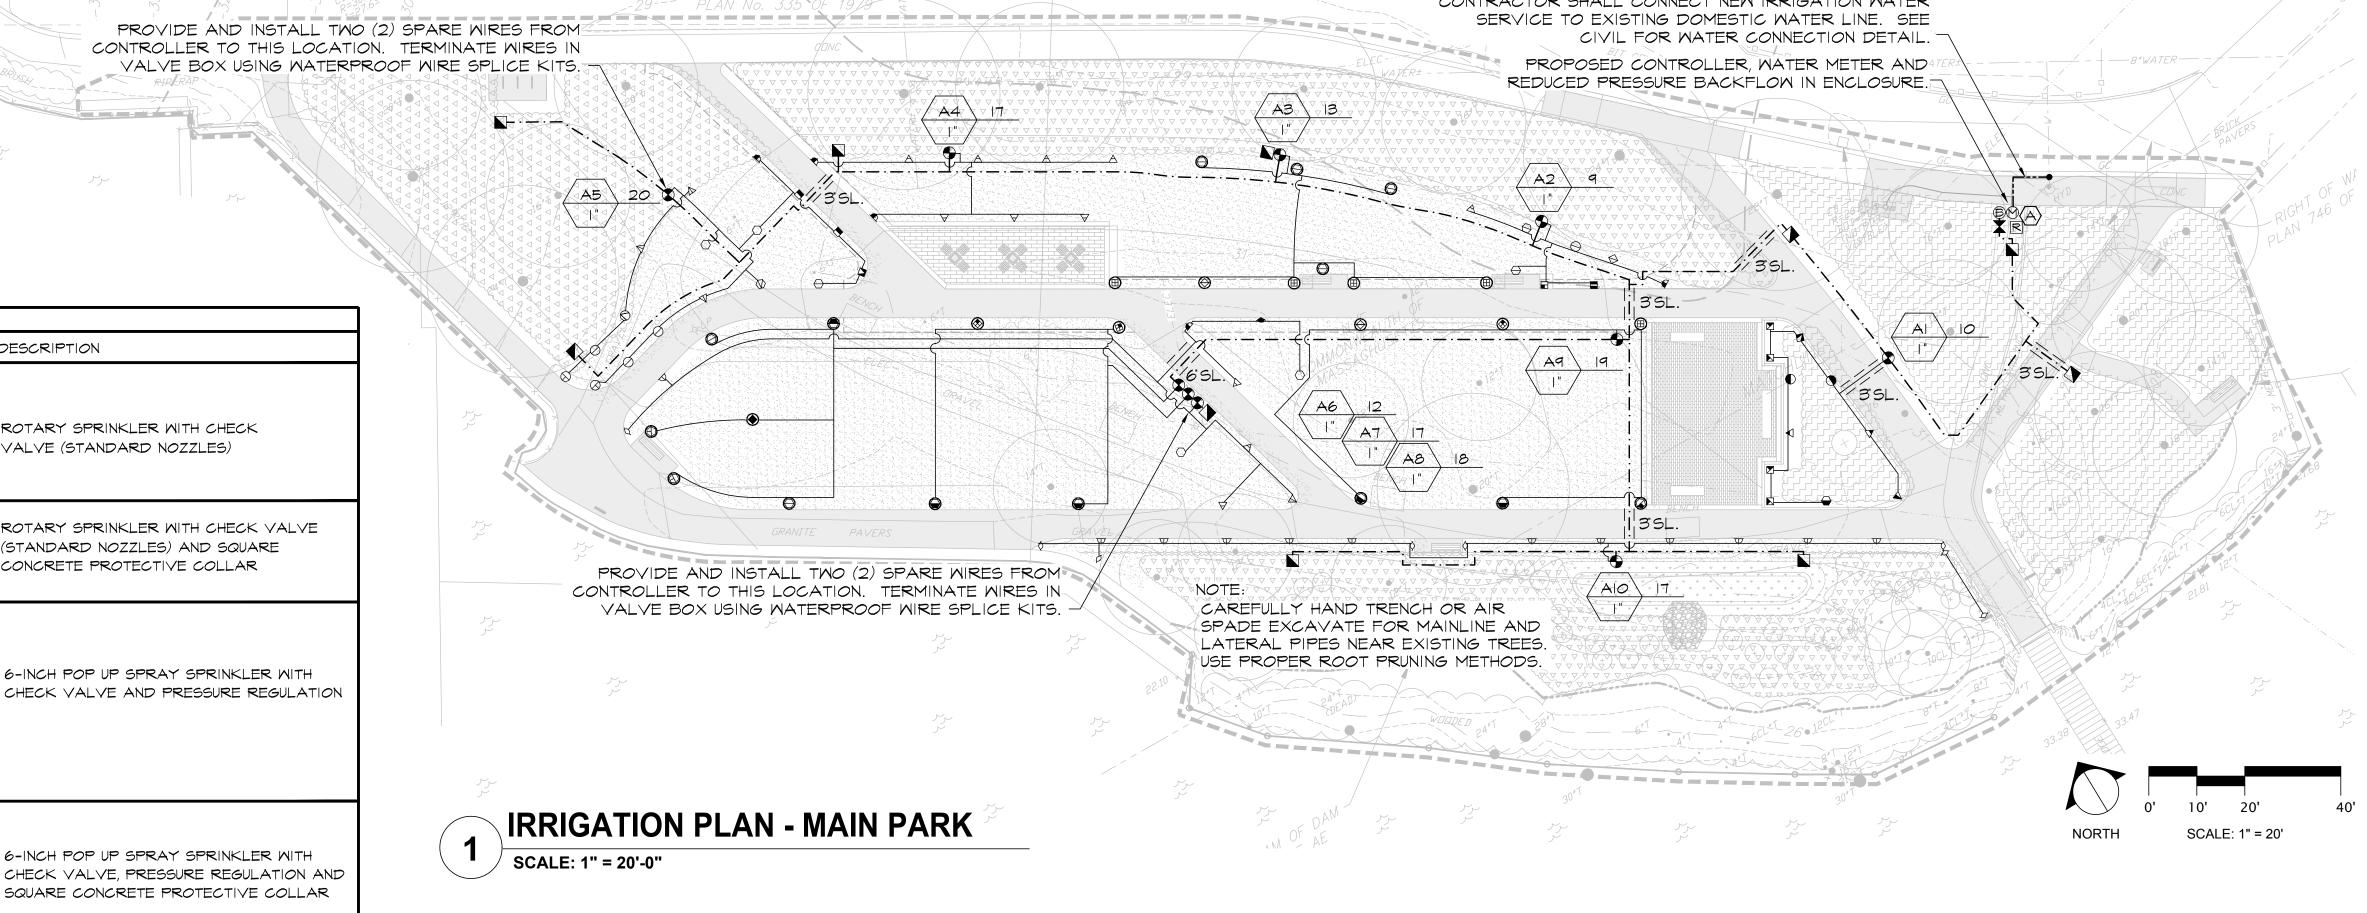

IRRIGATION NOTES

IRRIGATION LEGEND

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Q H V F

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A \

VALVE DESIGNATION:

--- STATION NO.

VALVE SIZE

DESCRIPTION

25'

25'

10'

4'x30'

4'×15'

10'

12'

10'

' 24 VOLT ELECTRIC ZONE VALVE

1-1/2" ISOLATION GATE VALVE

CLASS-200 PVC LATERAL PIPING

1-1/2" CLASS-200 PVC MAINLINE PIPING

CLASS-200 PVC PIPE SLEEVE (SIZE AS INDICATED)

INSTALL SCH-40 PVC WIRE CONDUIT ADJACENT TO

MAINLINE PIPE SLEEVES, MINIMUM WIRE CONDUIT

SIZE TO BE 2-INCH. SEE SLEEVING DETAIL.

(SEE LATERAL PIPE SCHEDULE)

1-1/2" TYPE K COPPER PIPING

AUTOMATIC CONTROLLER

IRRIGATION WATER METER

AUTOMATIC WEATHER SENSOR

BACK FLOW PREVENTION DEVICE

' QUICK COUPLING VALVE

(SEE VALVE DESIGNATOR FOR FLOWS)

ROTARY SPRINKLER WITH CHECK

(STANDARD NOZZLES) AND SQUARE

6-INCH POP UP SPRAY SPRINKLER WITH

6-INCH POP UP SPRAY SPRINKLER WITH

12-INCH POP UP SPRAY SPRINKLER WITH

CHECK VALVE AND PRESSURE REGULATION

CONCRETE PROTECTIVE COLLAR

VALVE (STANDARD NOZZLES)

. COORDINATE FINAL LOCATION OF SPRINKLERS AND NOZZLE SELECTION WITH FINAL APPROVED LANDSCAPE.

2. PIPE AND VALVE LOCATIONS ARE DIAGRAMMATIC, CONTRACTOR SHALL FIELD VERIFY.

3. VALVES AND VALVE BOXES SHALL BE PLACED, WHERE POSSIBLE, IN PLANTED AREAS UNDER MULCH.

4. INSTALL PIPING AS FAR FROM TREES AND ROOT BALLS AS POSSIBLE WHILE MAINTAINING SPRINKLER SPACING.

5. ALL CONTROL WIRE SHALL BE #14 GAUGE SINGLE STRAND, RED FOR TURF ZONES AND ORANGE FOR DRIP, ALL COMMON WIRE SHALL BE #14 GAUGE SINGLE STRAND WHITE AND ALL SPARE WIRES, INSTALLED WHERE SHOWN, SHALL BE #14 GAUGE SINGLE STRAND BLUE.

6. QUICK COUPLING VALVES SHALL BE INSTALLED ON I INCH PVC SMING JOINTS MITH BRASS INSERTS AND STABILIZERS. (SEE DETAIL)

7. SPRAY AND ROTARY SPRINKLERS SHALL BE INSTALLED ON SWING PIPE ASSEMBLIES, MINIMUM LENGTH TO BE 6 INCHES, 18 INCH MAXIMUM.

8. IRRIGATION SYSTEM IS DESIGNED FOR SEPARATE WATER SUPPLY TO PROVIDE 25 GPM MAX FROM POTABLE SERVICE. SYSTEM TO PRODUCE 65-PSI DYNAMIC PRESSURE AT IRRIGATION CONTRACTOR'S POINT OF CONNECTION IN LANDSCAPED AREA.

9. CONTRACTOR SHALL TEST DYNAMIC PRESSURE BEFORE STARTING WORK, REPORT ANY DEVIATION FROM PRESSURE REQUIRED TO OWNER'S REPRESENTATIVE BEFORE CONTINUING.

LATERAL PIPE SCHEDULE		
FLOW	PIPE SIZE / TYPE	
0-12 GPM	I INCH 100 PSI POLYETHYLENE OR CLASS-200 PVC	
12-22 GPM	I-1/4 INCH 100 PSI POLYETHYLENE OR CLASS-200 PVC	
23-35 <i>G</i> PM	I-I/2 INCH CLASS-200 PVC	

IRRIGATION NOTES

IO. INSTALL CONTROLLER IN METER AND BACKFLOW ENCLOSURE, GENERALLY WHERE SHOWN ON THE DRAWINGS, HARD WIRE TO 120 VOLT, DEDICATED 15 AMP CIRCUIT, POWER SUPPLY USING LICENSED ELECTRICIAN. ROUTE ZONE AND SPARE WIRES TO CONTROLLER VIA CONDUIT THROUGH ENCLOSURE BASE.

. INSTALL WEATHER SENSOR ON OUTSIDE OF METER AND BACKFLOW ENCLOSURE. ROUTE WEATHER SENSOR WIRING TO CONTROLLER THROUGH ENCLOSURE WALL.

12. ABOYE GROUND WIRING, INSIDE AND OUTSIDE OF ENCLOSURE, SHALL BE INSTALLED IN RIGID, METALLIC CONDUIT FOR VANDALISM PROTECTION.

13. COORDINATE LOCATION OF EXISTING AND FUTURE UTILITIES ON SITE AND CONTACT PROPER AUTHORITIES AND UTILITY COMPANIES BEFORE THE START OF MORK.

12. SPRAY SPRINKLERS FOR TURF SHALL HAVE 6 INCH POP UP HEIGHT. SHRUB SPRINKLERS SHALL HAVE 12 INCH POP UP HEIGHT.

13. CONTRACTOR MUST SUBMIT SHOP PRODUCT DRAWINGS AS PER THE WRITTEN SPECIFICATIONS TO THE IRRIGATION CONSULTANT FOR APPROVAL PRIOR TO ORDERING MATERIAL AND BEGINNING WORK.

14. ANY AND ALL MATERIAL SUBSTITUTIONS WHICH VARY FROM THE SPECIFIED PRODUCTS MUST BE SUBMITTED TO THE IRRIGATION CONSULTANT FOR APPROVAL AS PART OF THE SUBMITTAL PROCESS.

15. ONCE APPROVED SUBMITTALS HAVE BEEN RETURNED TO THE CONTRACTOR, WORK MAY BEGIN. THE IRRIGATION CONSULTANT MUST BE NOTIFIED A MINIMUM OF 7-DAYS IN ADVANCE OF THE START OF WORK TO COORDINATE ON-SITE SUPERVISION AND ADMINISTRATION.

16. SEE IRRIGATION DETAILS AND SPECIFICATIONS SECTION FOR ADDITIONAL NECESSARY INFORMATION.

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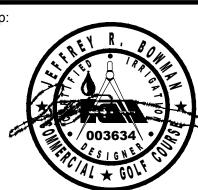




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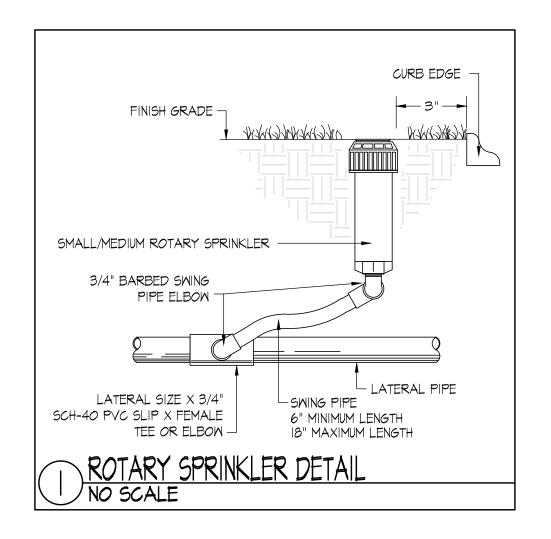
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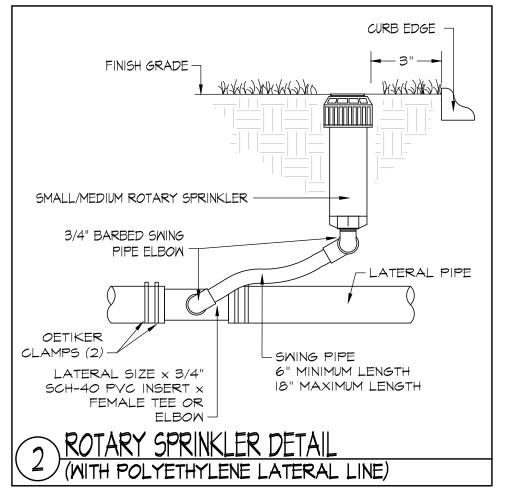
IRRIGATION PLAN


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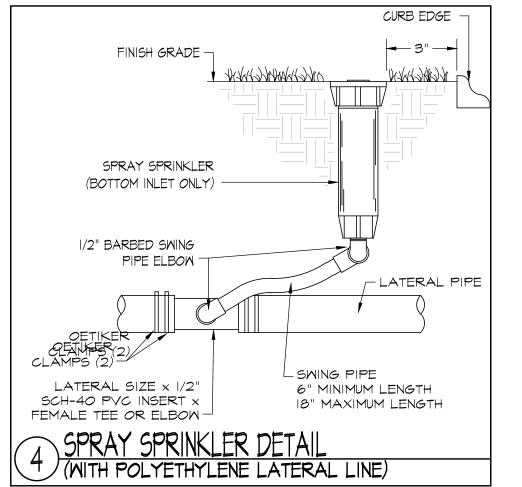
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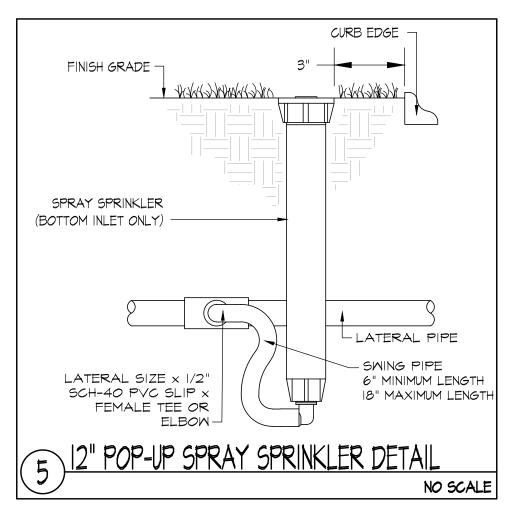
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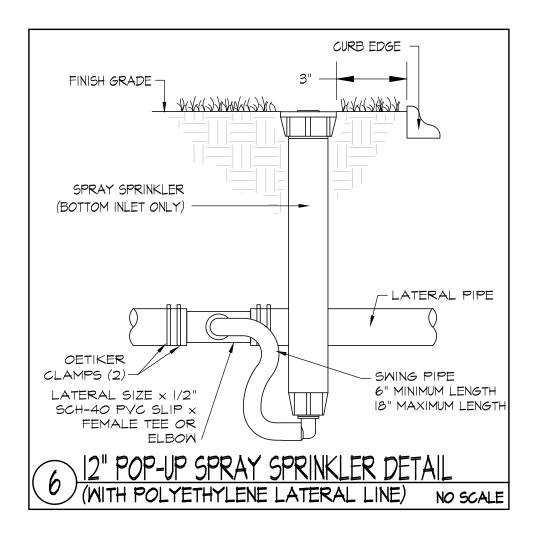














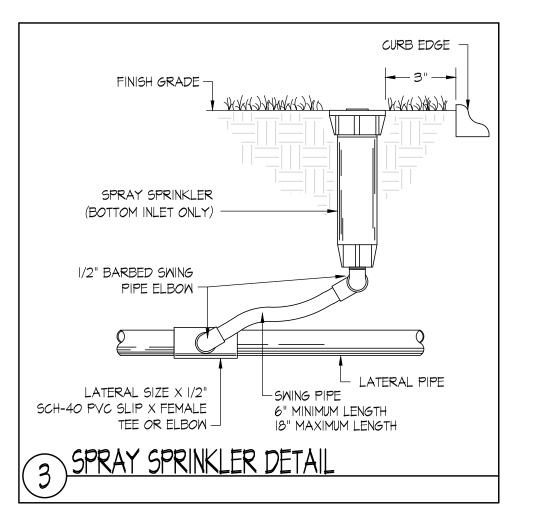


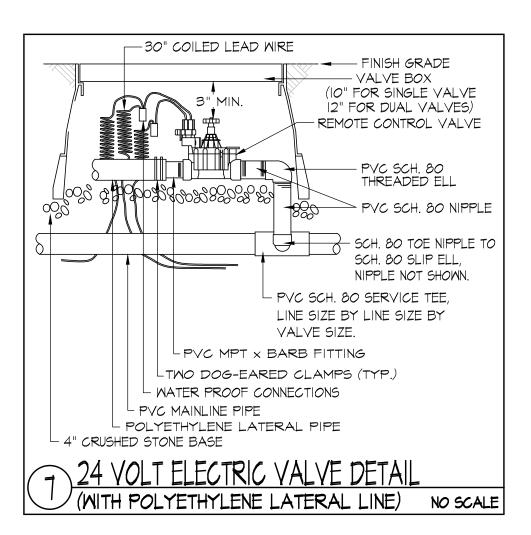


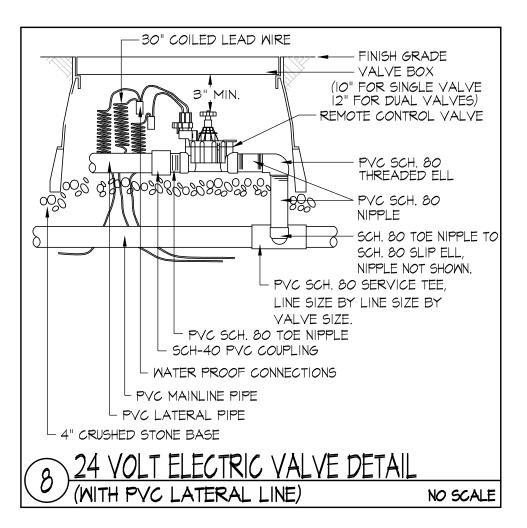


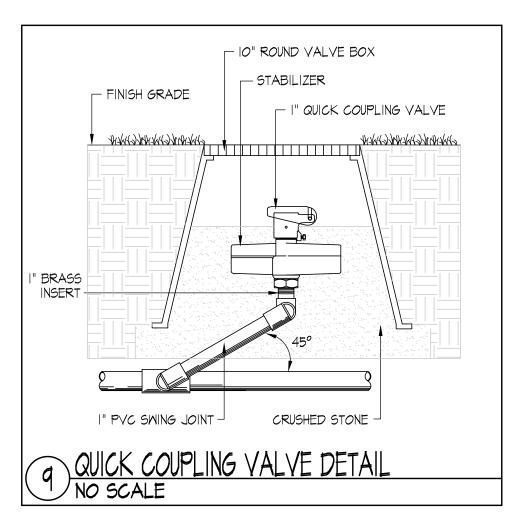


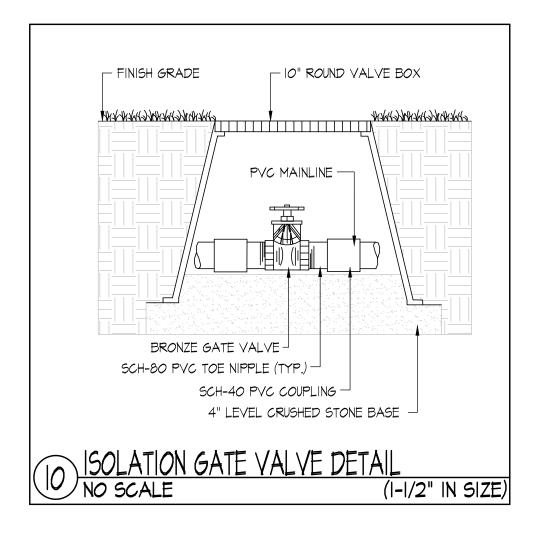

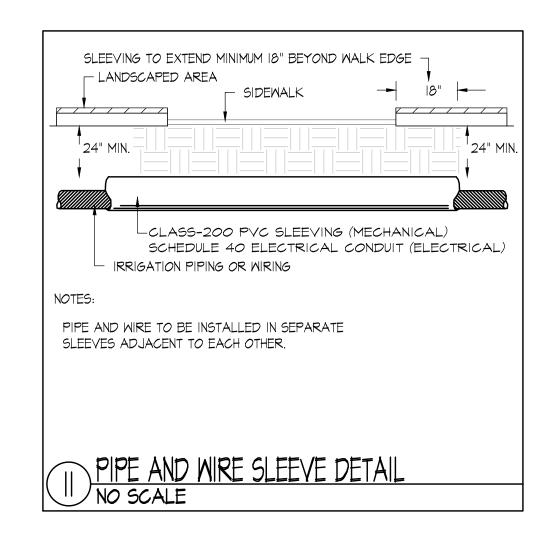

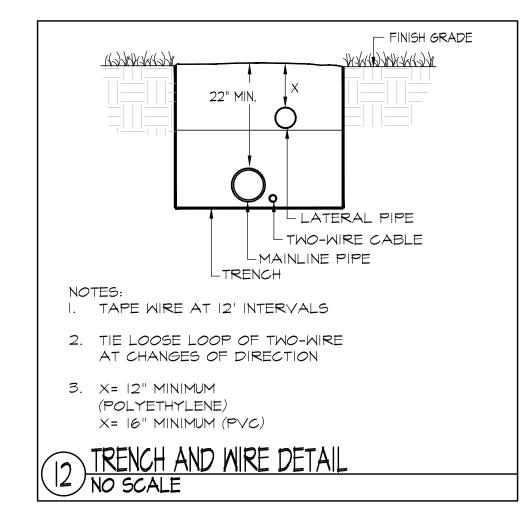

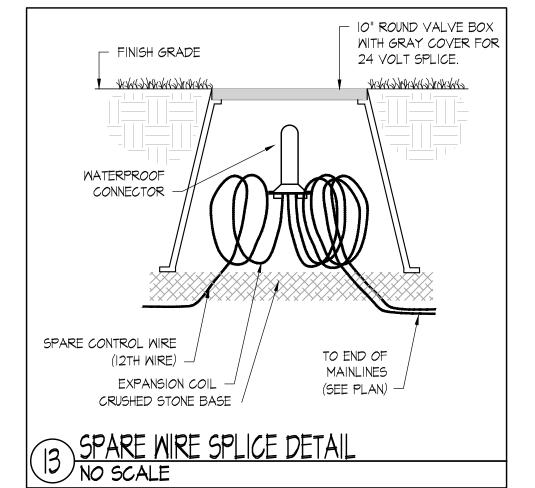

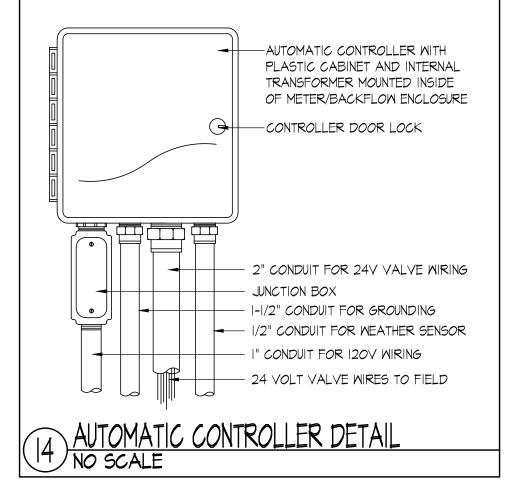






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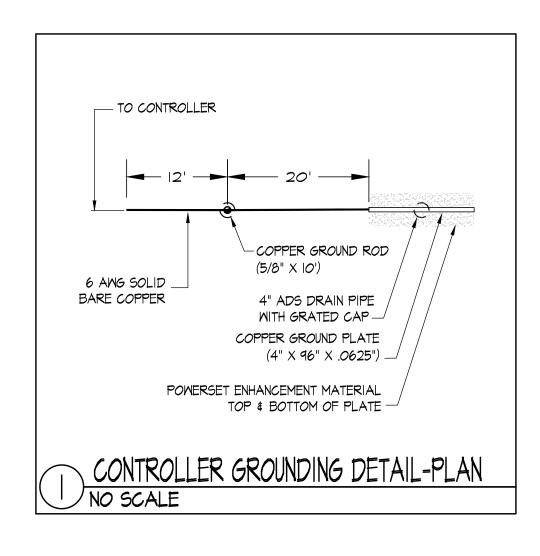
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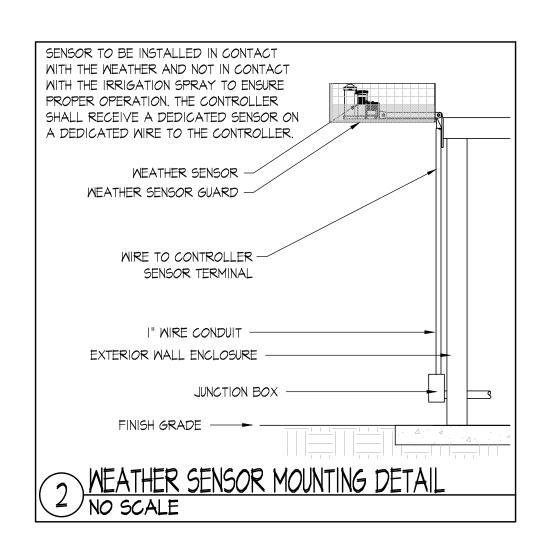
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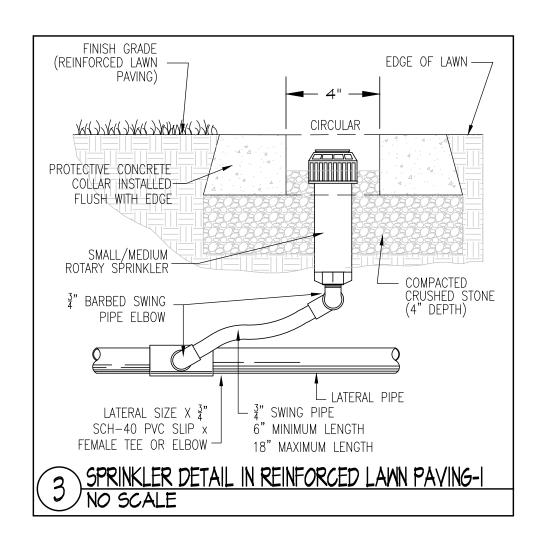
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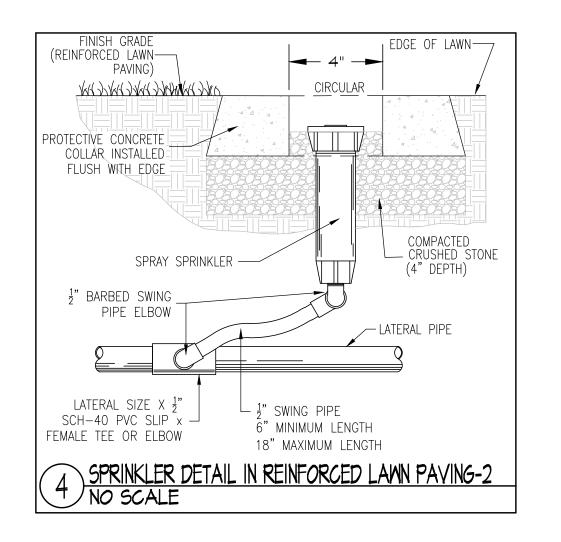
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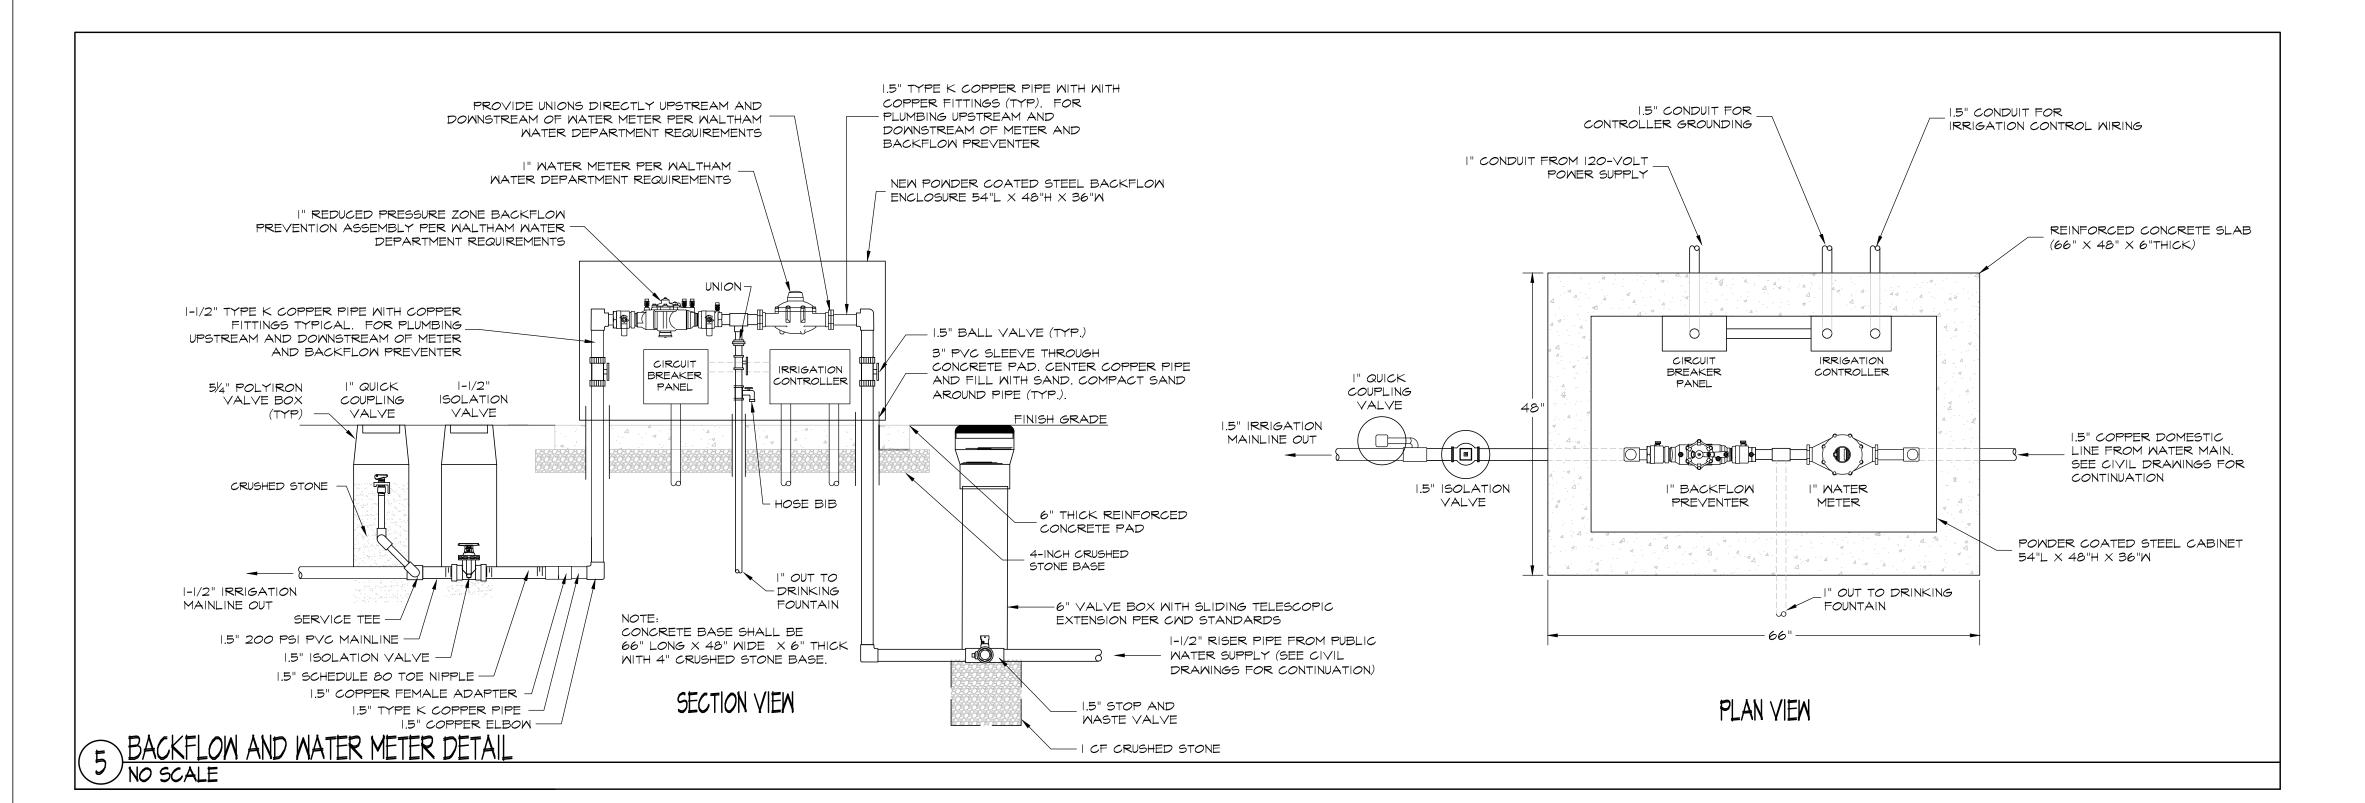





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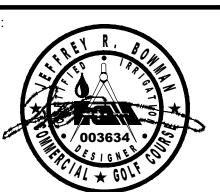
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Contract Number: P25-3586-C11A			
Hatch Project Number	:		
Date: JUNE 30, 2025	H-371610		

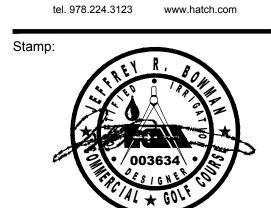Drawn By: GD Designed By: GD

Reviewed By: JB Scale: N.T.S.

Revisions
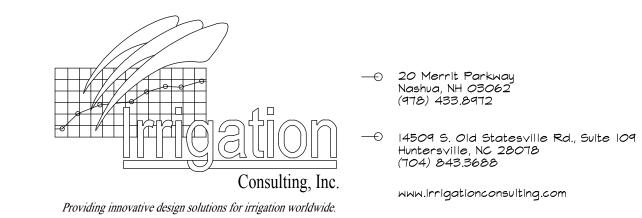
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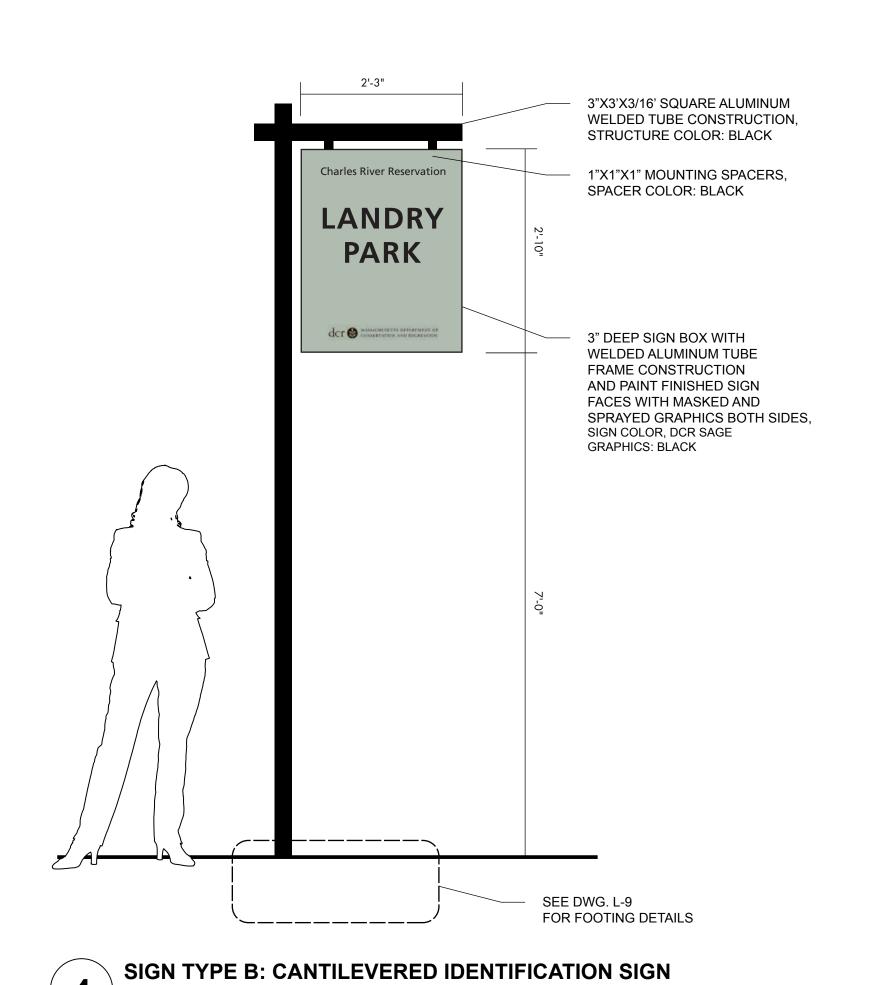
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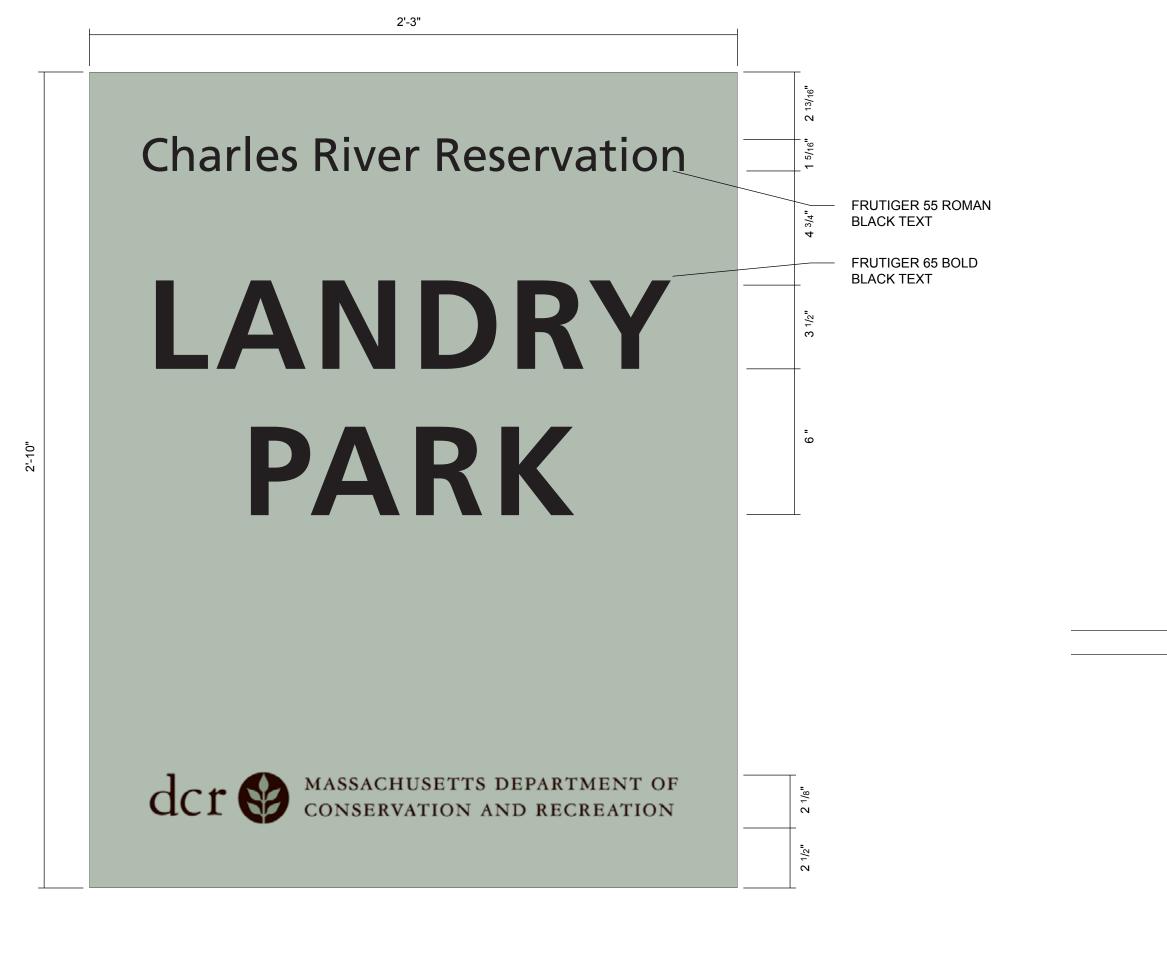
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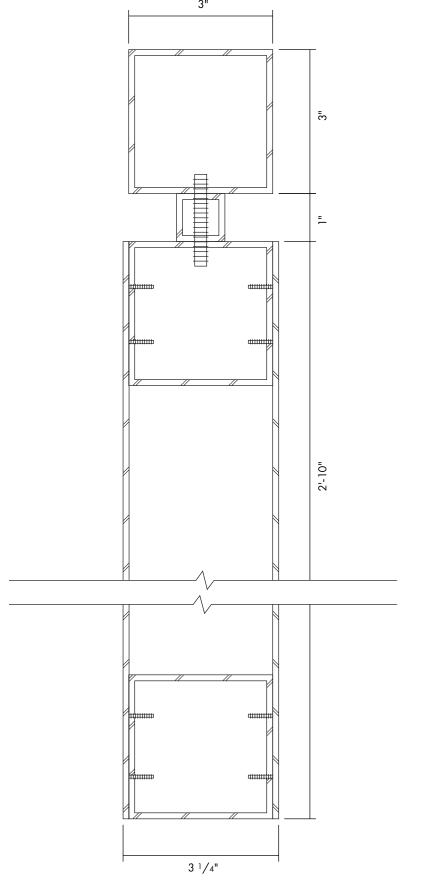
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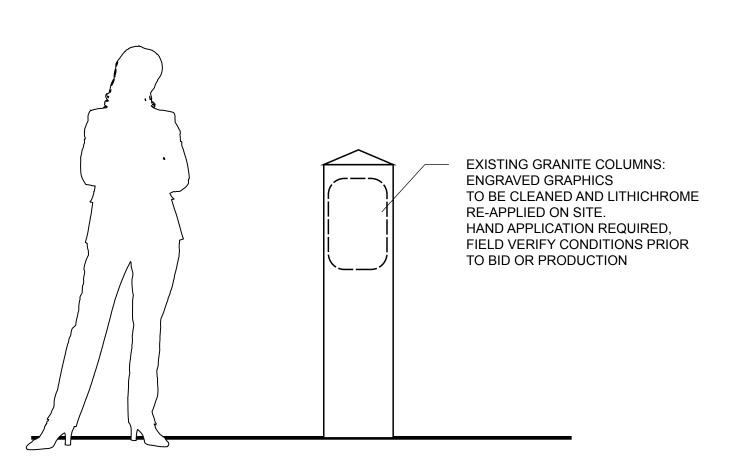
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SIGN TYPE B: SECTION DETAIL SCALE: HALF FULL SCALE






SCALE: 3/4" = 1'-0"



SIGN TYPE B: LAYOUT DETAILS

SCALE: 3" = 1'-0"



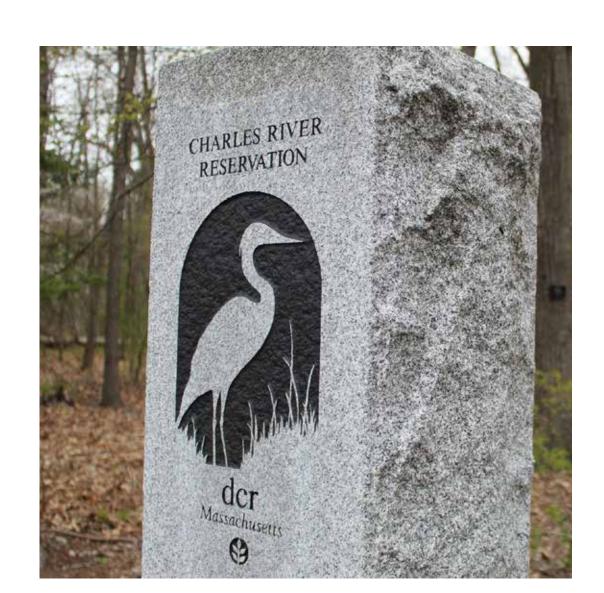

SIGN TYPE A: LITHICHROME FINISH REFERENCE IMAGE NOT TO SCALE

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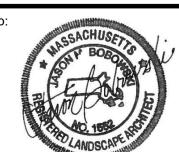
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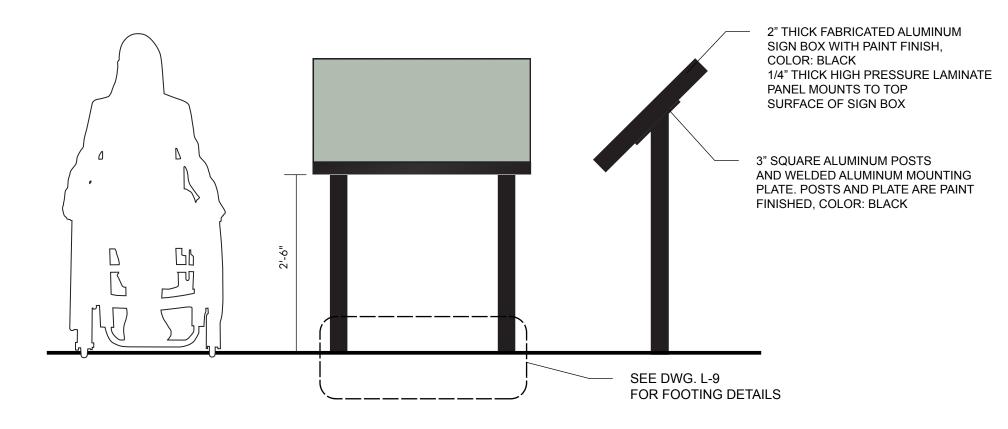
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Number:

SIGNAGE AND **GRAPHICS DETAILS**



SIGN TYPE D: INTERPRETATION SIGN SCALE: 3/4" = 1'-0"

1'-6" 1/4" THICK PAINT FINISHED ALUMINUM SIGN PANEL WITH DIRECT TO SUBSTRATE LANDRY PARK PRINTED GRAPHICS, SIGN COLOR, DCR SAGE SIGN POST & BACK: BLACK **88888** 3" SQUARE ALUMINUM POST, POST AND BACK OF SIGN ARE PAINT FINISHED, COLOR: BLACK SEE DWG. L-9

FOR FOOTING DETAILS

SIGN TYPE C: RULES AND REGULATIONS SIGN SCALE: 3/4" = 1'-0"

LOCATION 05

CHARLES RIVER ECOLOGY AND WILDLIFE

Charles River Ecology Fish of the Charles River & Fish Ladder Birds of the Charles River

LOCATION 10

NATIVE AMERICAN LAND USE (TBD)

Native American Tribes Indian Paths (Connecticut Path) The link between the land and the people Land is a source of sustenance, spirituality, and heritage Land belongs to the community, not to individuals

LOCATION 09

BOSTON MANUFACTURING COMPANY Boston Manufacturing Company 1813 – 1929 Boston Manufacturing Company Expansion 1847-1900 Company Closure and Park Development 1929-1978 ALL INTERPRETIVE GRAPHIC PANEL LAYOUTS TO BE PROVIDED

SIGN TYPE D: LAYOUT DETAILS (LAYOUTS TBD) SCALE: 1 1/2" = 1'-0"





Massachusetts



Massachusetts Department of Conservation and Recreation State Transportation Building, 10 Park Plaza, Suite 6620 Boston, MA 02116

HATCH

Boston, MA 02110

tel. 978.224.3123 www.hatch.com

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> North Adams, MA 01247 anna@annafarrington.com www.annafarrington.com



Project:

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DOCUMENTS

BID

Contract Number: P25-3586-C11A Hatch Project Number: H-371610 Date: JUNE 30, 2025 Drawn By: AF

Designed By: AF

Reviewed By: AF Scale: AS SHOWN

Revisions Description: Number:


Sheet Title:

SIGNAGE AND

GRAPHICS DETAILS

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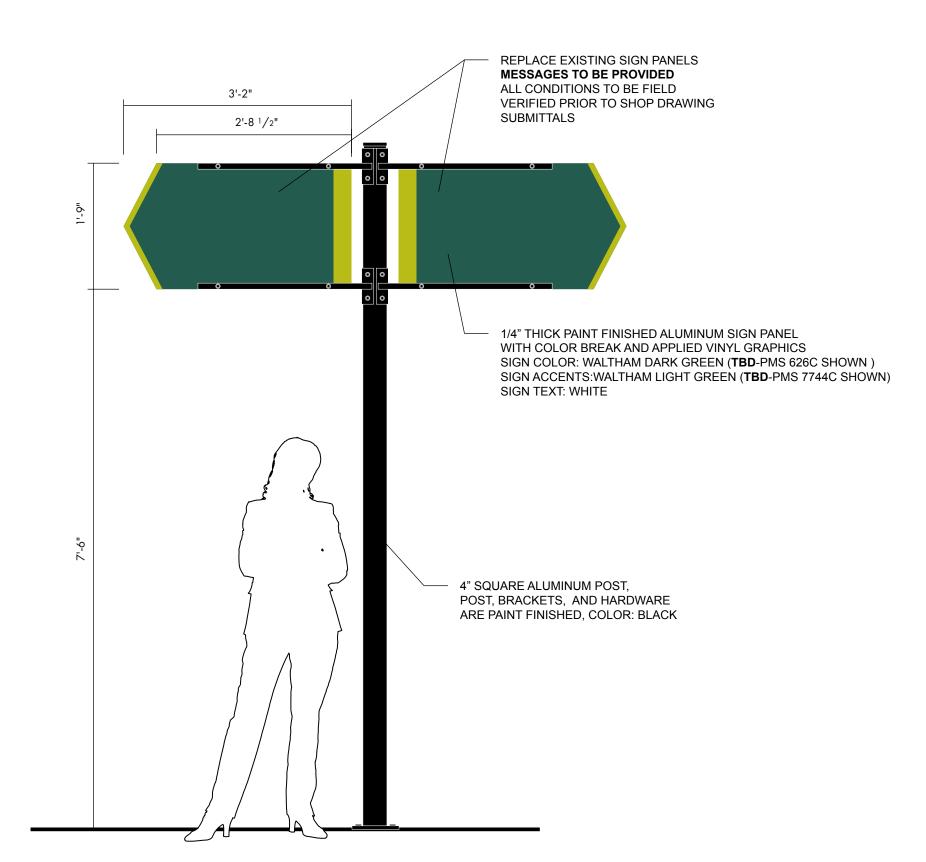





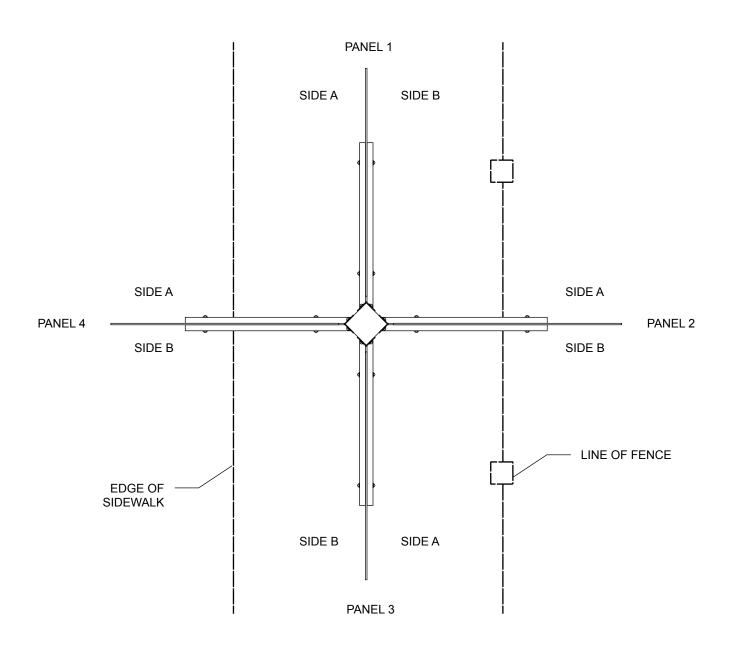

SIGN TYPE E: PLAN VIEW SCALE: 3/4" = 1'-0"

SIGN TYPE E: EXISTING CONDITIONS REFERENCE IMAGES **NOT TO SCALE**



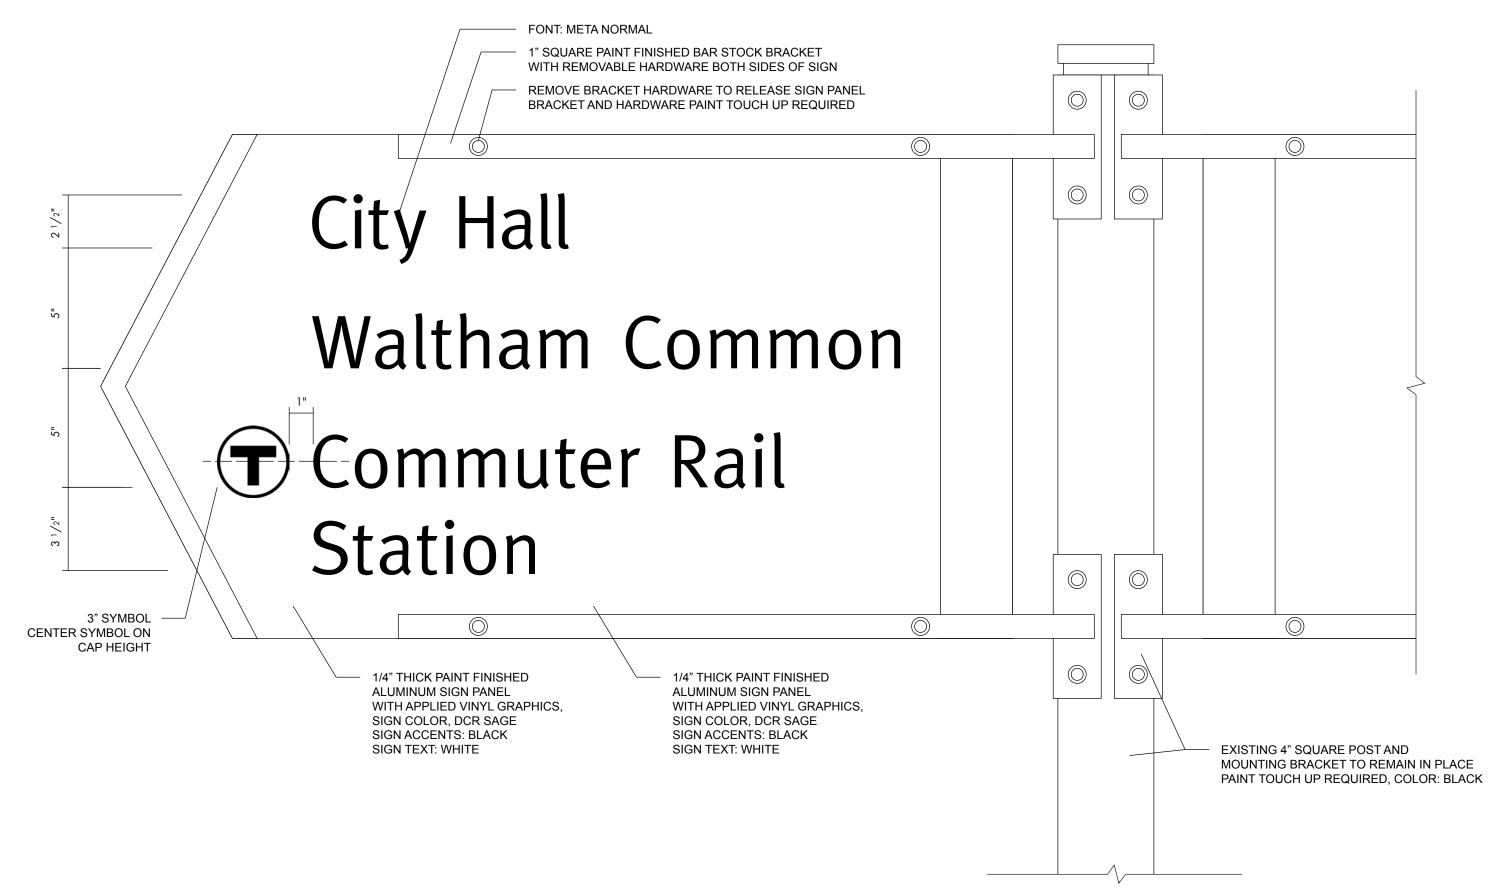

SIGN TYPE E: EXISTING WAYFINDING TO BE UPDATED SCALE: 3/4" = 1'-0"



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