
03 - HIGHWAY INDEX OF DRAWINGS					
DRAWING NUMBER	DRAWING TITLE	DRAWING NUMBER	DRAWING TITLE		
INX-03	INDEX OF DRAWINGS				
TYP-01	TYPICAL SECTIONS				
ALN-01	ALIGNMENT PLAN				
PLN-01	HIGHWAY PLAN				
PRO-1	PROFILE				
SGP-01	SITE GRADING PLAN				
XSC-01 - XSC-06	CROSS SECTIONS				
MDS-01 - MDS-02	MISCELLANEOUS DETAIL SHEET				
PMT-02	PLANTING PLAN				




SIGNATURE BLOCK: benesch

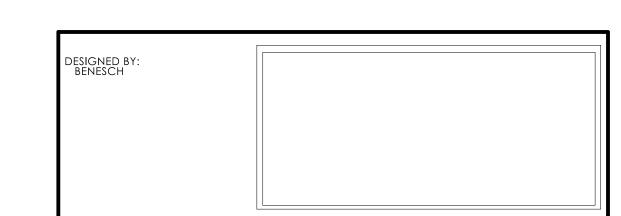

CONNECTICUT DEPARTMENT OF TRANSPORTATION

REPLACEMENT OF BRIDGE NO. 05664; TAFT POND ROAD OVER MASHAMOQUET BROOK

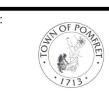


POMFRET


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DRAWING NO.:


INX-03 0111-0125 SHEET NO.: 03.01

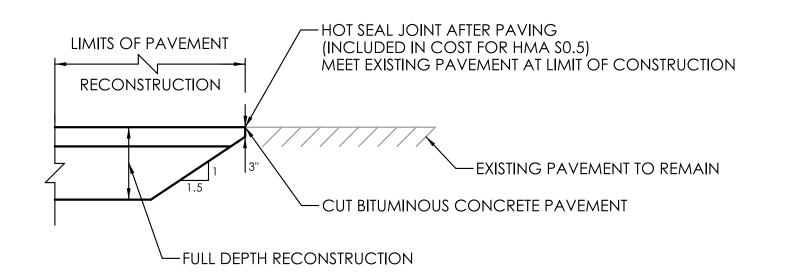

ROADWAY PAVEMENT TRANSITION DETAIL FULL DEPTH CONSTRUCTION LIMIT

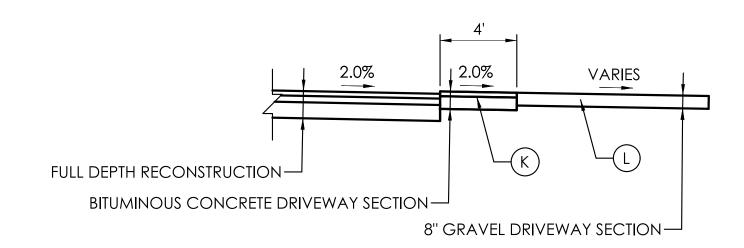

GRAVEL DRIVEWAY SECTION

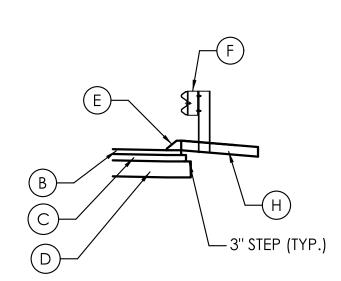

CURBING DETAIL

STA. 4+68.00 TO STA. 4+78.00 LT & RT STA. 5+52.00 TO STA. 5+62.00 LT & RT



3" HMA S0.5 TRAFFIC LEVEL 2 (PLACED IN ONE LIFT)

4" HMA \$1 TRAFFIC LEVEL 2 (PLACED IN ONE LIFT)

10" PROCESSED AGGREGATE BASE

BITUMINOUS CONCRETE PARK CURBING

ROADSIDE SAFETY

8" PROCESSED AGGREGATE BASE

6" PROCESSED AGGREGATE

FORMATION OF SUBGRADE

4" FURNISH AND PLACE TOPSOIL WITH CONSERVATION SEEDING FOR SLOPES OR TURF ESTABLISHMENT - LAWN


BITUMINOUS CONCRETE DRIVEWAY

8" GRAVEL DRIVEWAY


BORROW

DESIGNER/DRAFTER: B. VALENZUELA, N. BROWN


DIRECTION OF TRAVEL

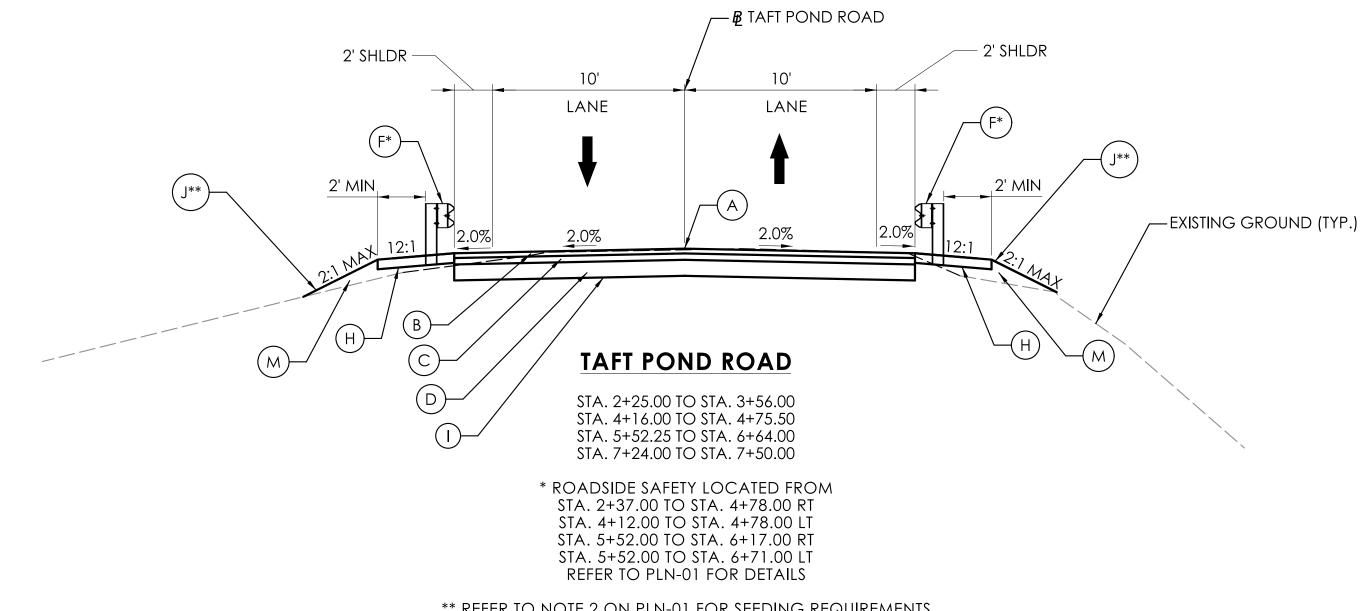

** REFER TO NOTE 2 ON PLN-01 FOR SEEDING REQUIREMENTS REFER TO PLN-01 FOR SLOPE DETAILS

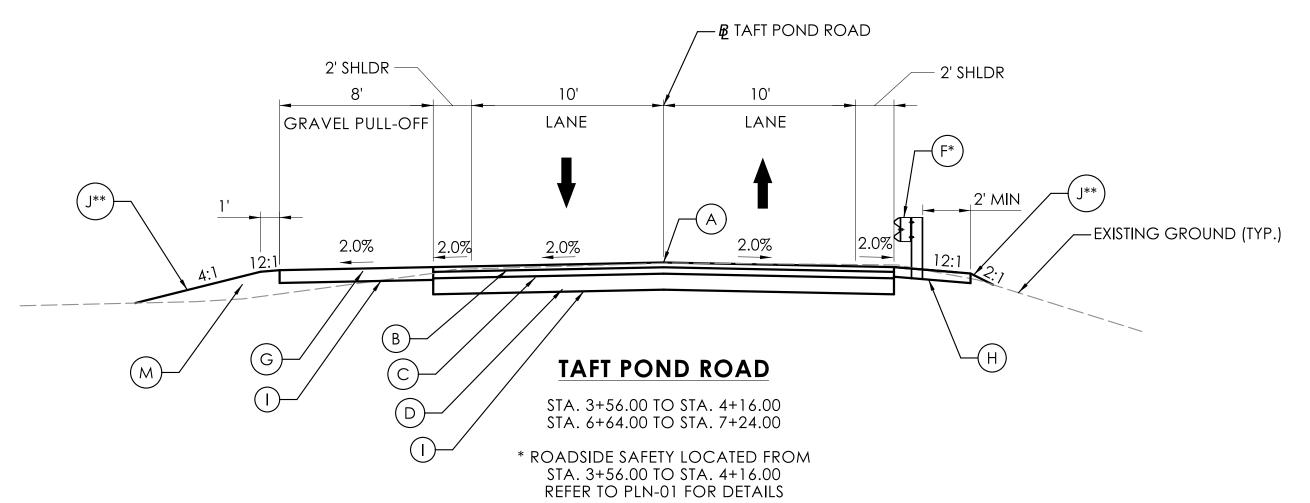

** REFER TO NOTE 2 ON PLN-01 FOR SEEDING REQUIREMENTS REFER TO PLN-01 FOR SLOPE DETAILS

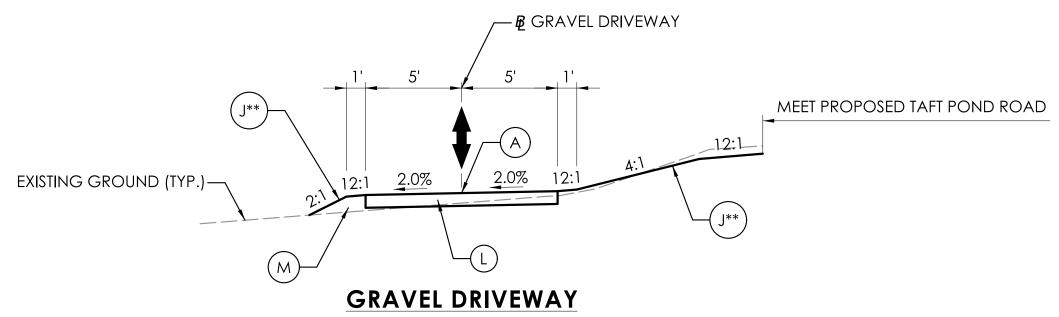

STA. 15+12.00 TO STA. 16+03.00

** REFER TO NOTE 2 ON PLN-01 FOR SEEDING REQUIREMENTS REFER TO PLN-01 FOR SLOPE DETAILS


NOTE

DRAWING TITLE:

EROSION CONTROL MATTING, TYPE "D" SHALL BE INSTALLED ON ALL PERMANENT SLOPES STEEPER THAN 3:1 WITH EXCEPTION TO AREAS OF NATURAL STREAMBED INSTALLATION.

SIGNATURE BLOCK: **benesch**



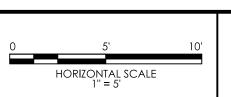

CTDOT CONNECTICUT **DEPARTMENT OF** TRANSPORTATION

REPLACEMENT OF BRIDGE NO. 05664; TAFT POND ROAD OVER MASHAMOQUET BROOK




POMFRET

TYPICAL SECTIONS

TYP-01 0111-0125 SHEET NO.: 03.02


PROJECT NO.:

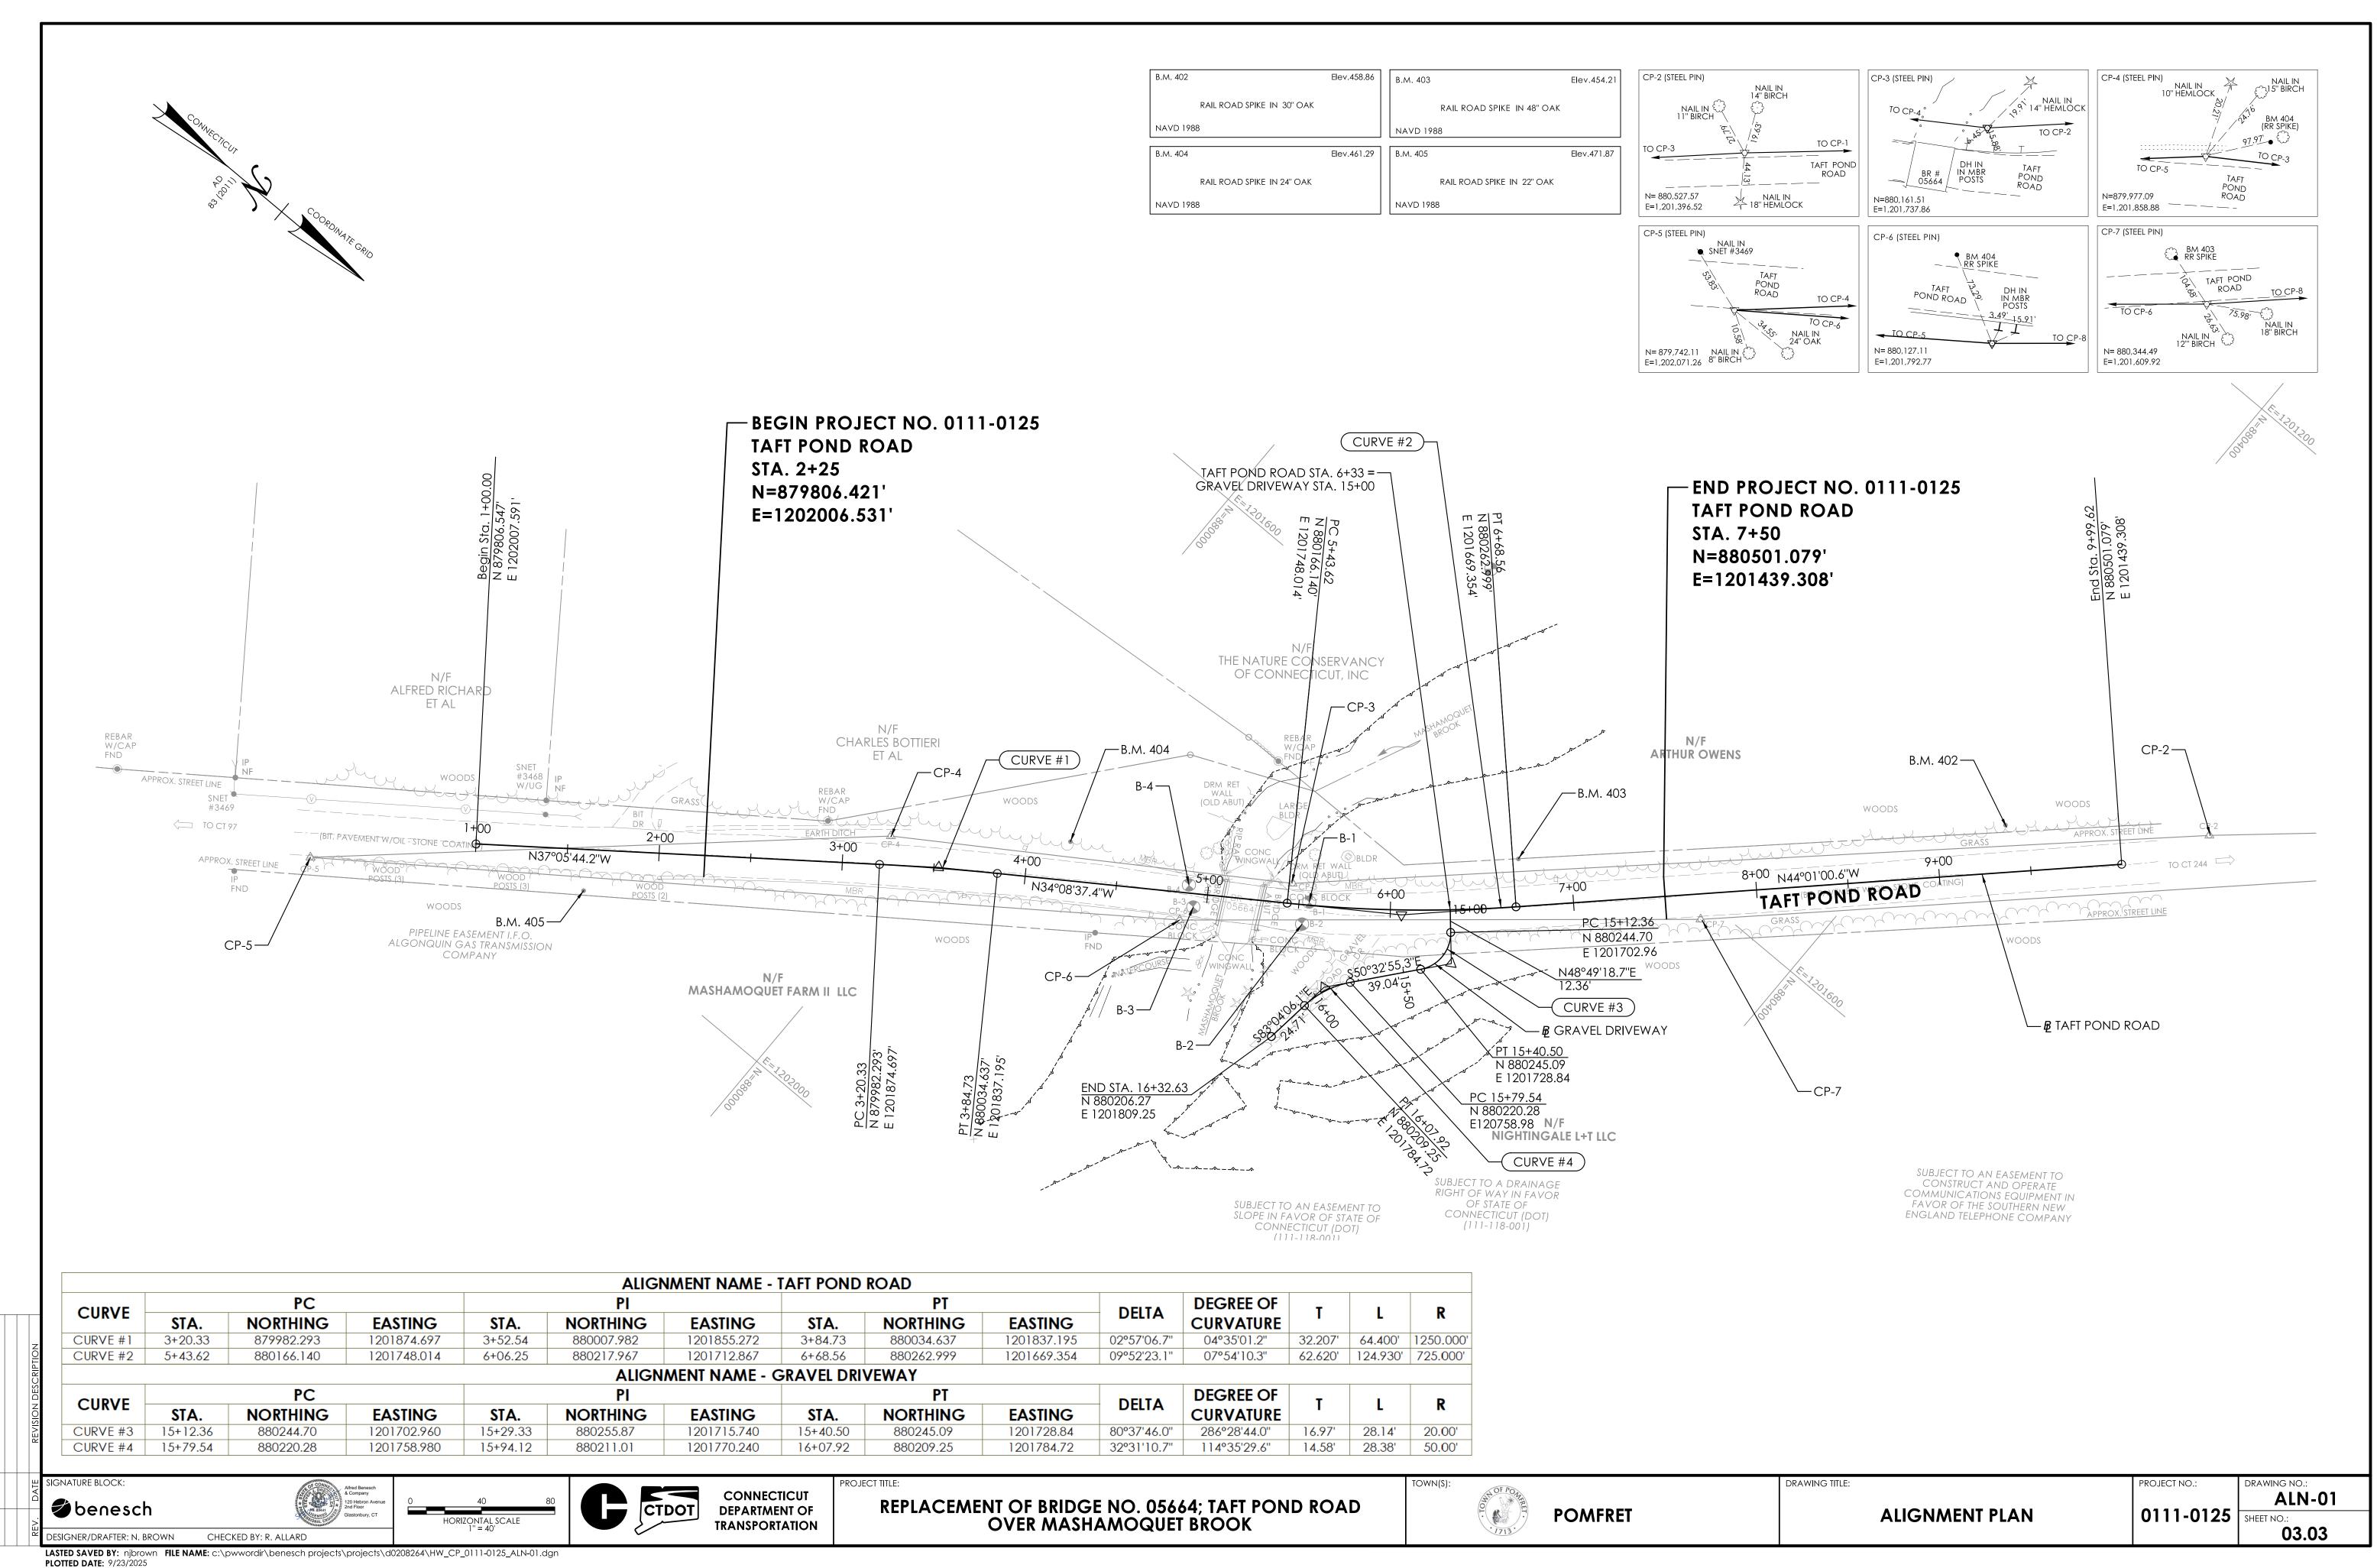



PROPERTY	ACQUISITION	LEGENI
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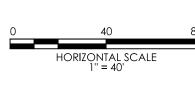
- $\langle A \rangle$ EASEMENT TO SLOPE FOR SUPPORT AND/OR SAFETY OF HIGHWAY, REQUIRED
- (B) TEMPORARY CONSTRUCTION EASEMENT, REQUIRED
- C RIGHT TO REMOVE AND CONSTRUCT DRIVEWAY, REQUIRED
- D RIGHT TO INSTALL TEMPORARY SEDIMENTATION CONTROL SYSTEM, REQUIRED

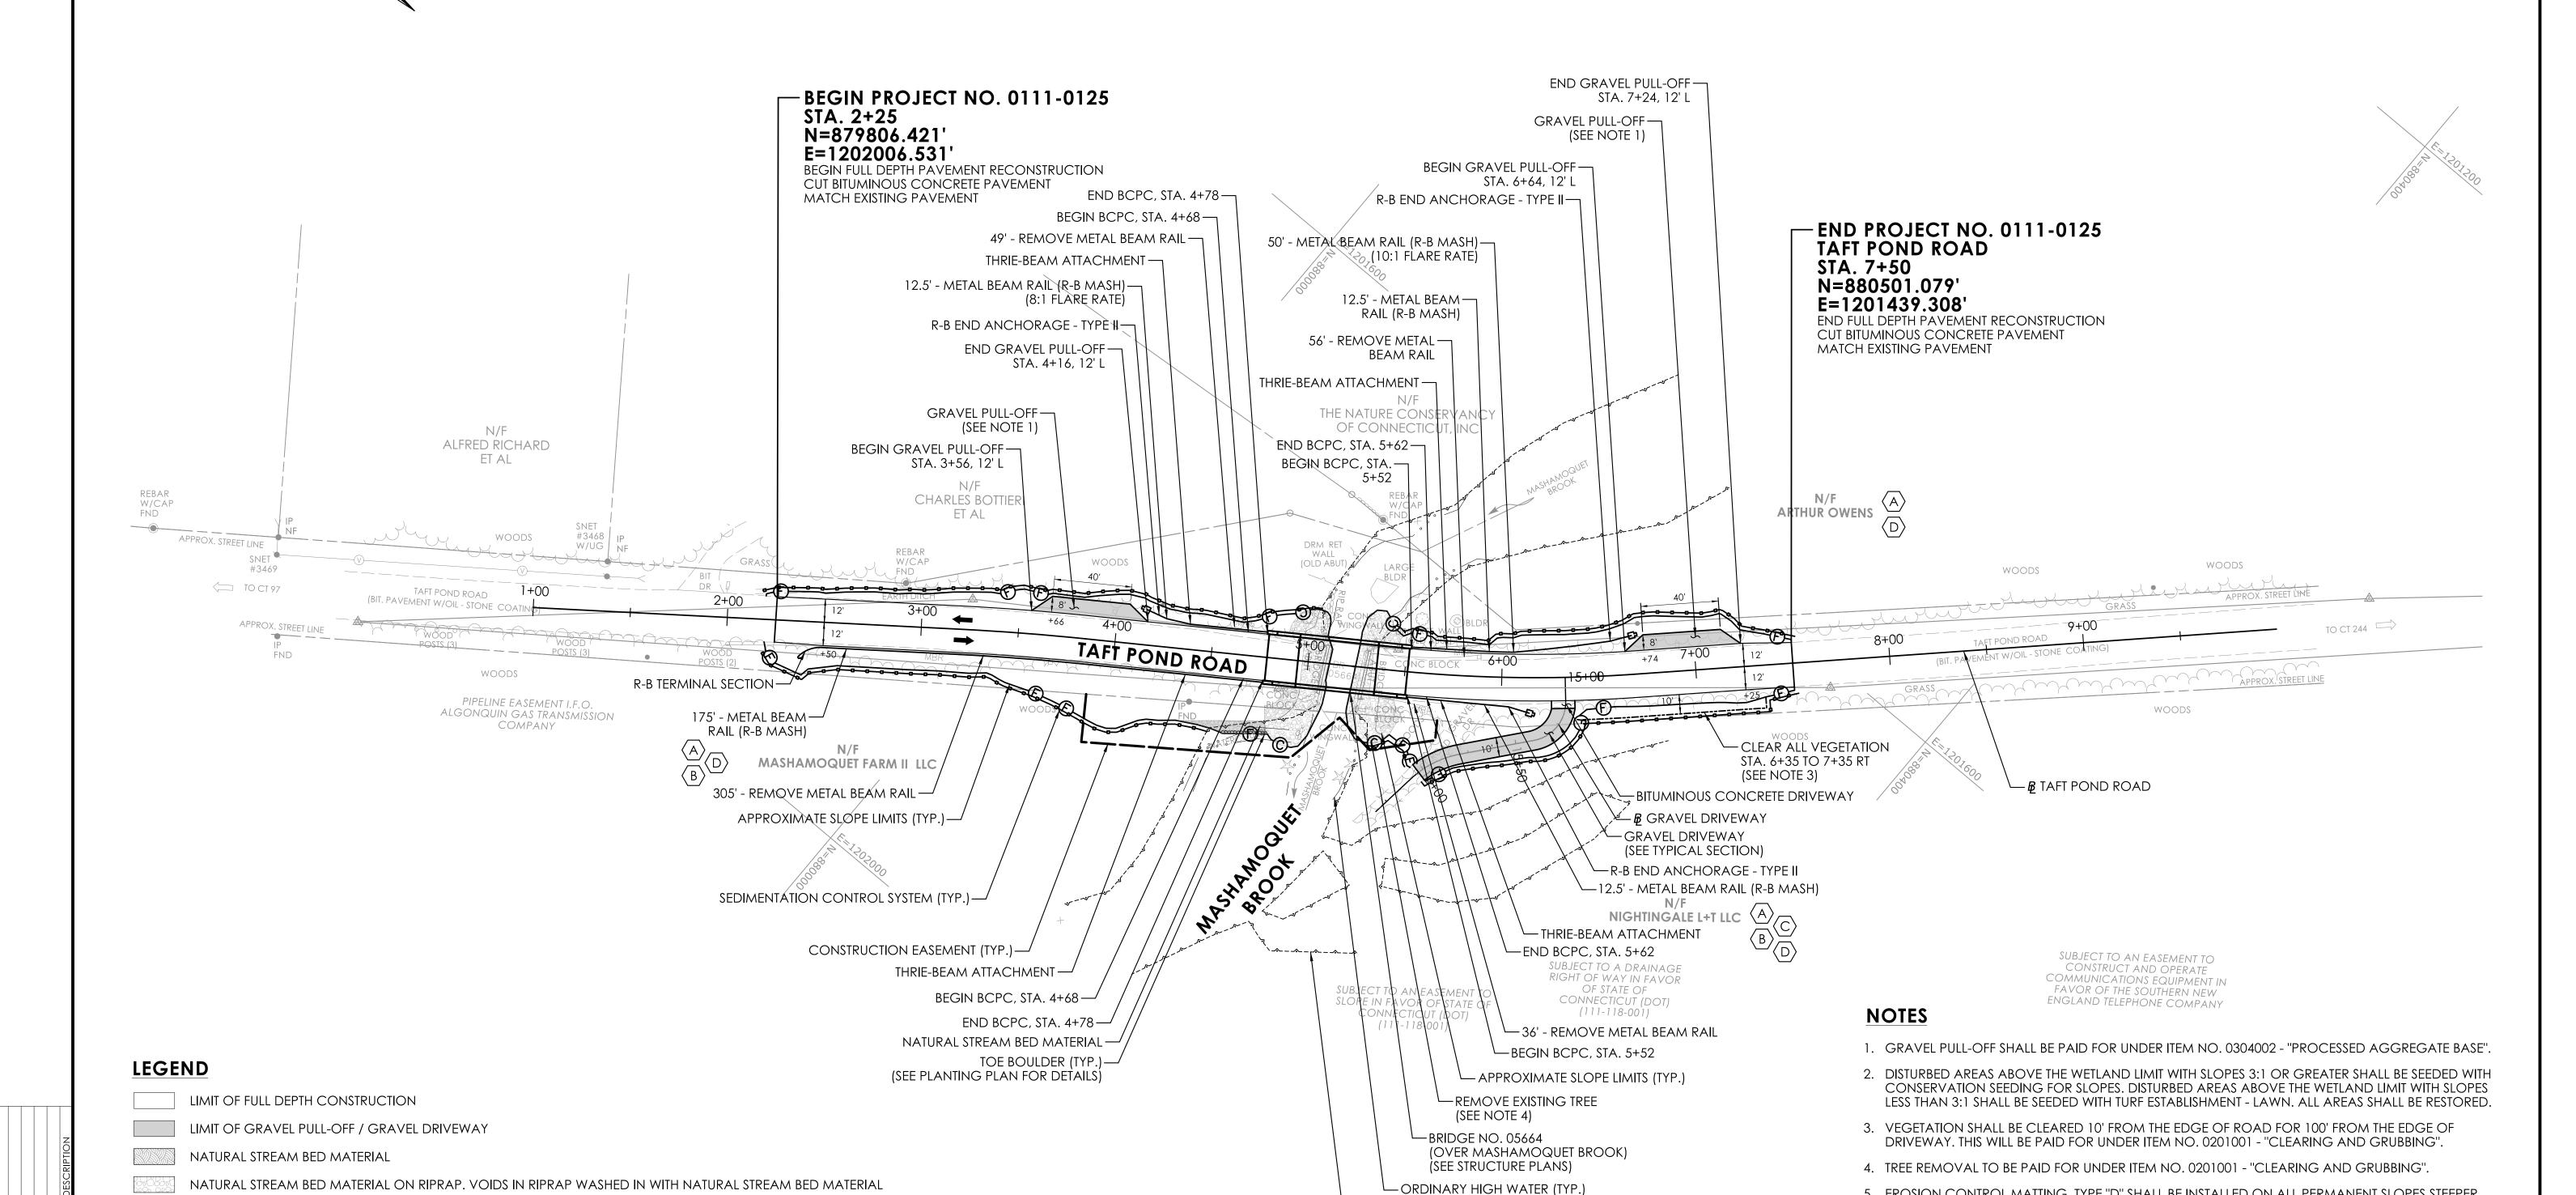

signature block:

benesch







CONNECTICUT
DEPARTMENT OF
TRANSPORTATION

REPLACEMENT OF BRIDGE NO. 05664; TAFT POND ROAD OVER MASHAMOQUET BROOK



STATE/FEDERAL WETLANDS (TYP.)

POMFRET

HIGHWAY PLAN

DRAWING TITLE:

5. EROSION CONTROL MATTING, TYPE "D" SHALL BE INSTALLED ON ALL PERMANENT SLOPES STEEPER THAN 3:1 WITH EXCEPTION TO AREAS OF NATURAL STREAMBED MATERIAL INSTALLATION.

UNDER ITEM NO. 0202218 - "WASHING-IN SUPPLEMENTAL STREAMBED MATERIAL".

6. WASHING-IN OF THE INSTALLED SUPPLEMENTAL STREAMBED CHANNEL MATERIAL SHALL BE PAID FOR

PROJECT NO.:

DRAWING NO.:


PLN-01

SHEET NO.:

SHEET NO.: 03.04

STANDARD RIPRAP

TRAFFIC FLOW

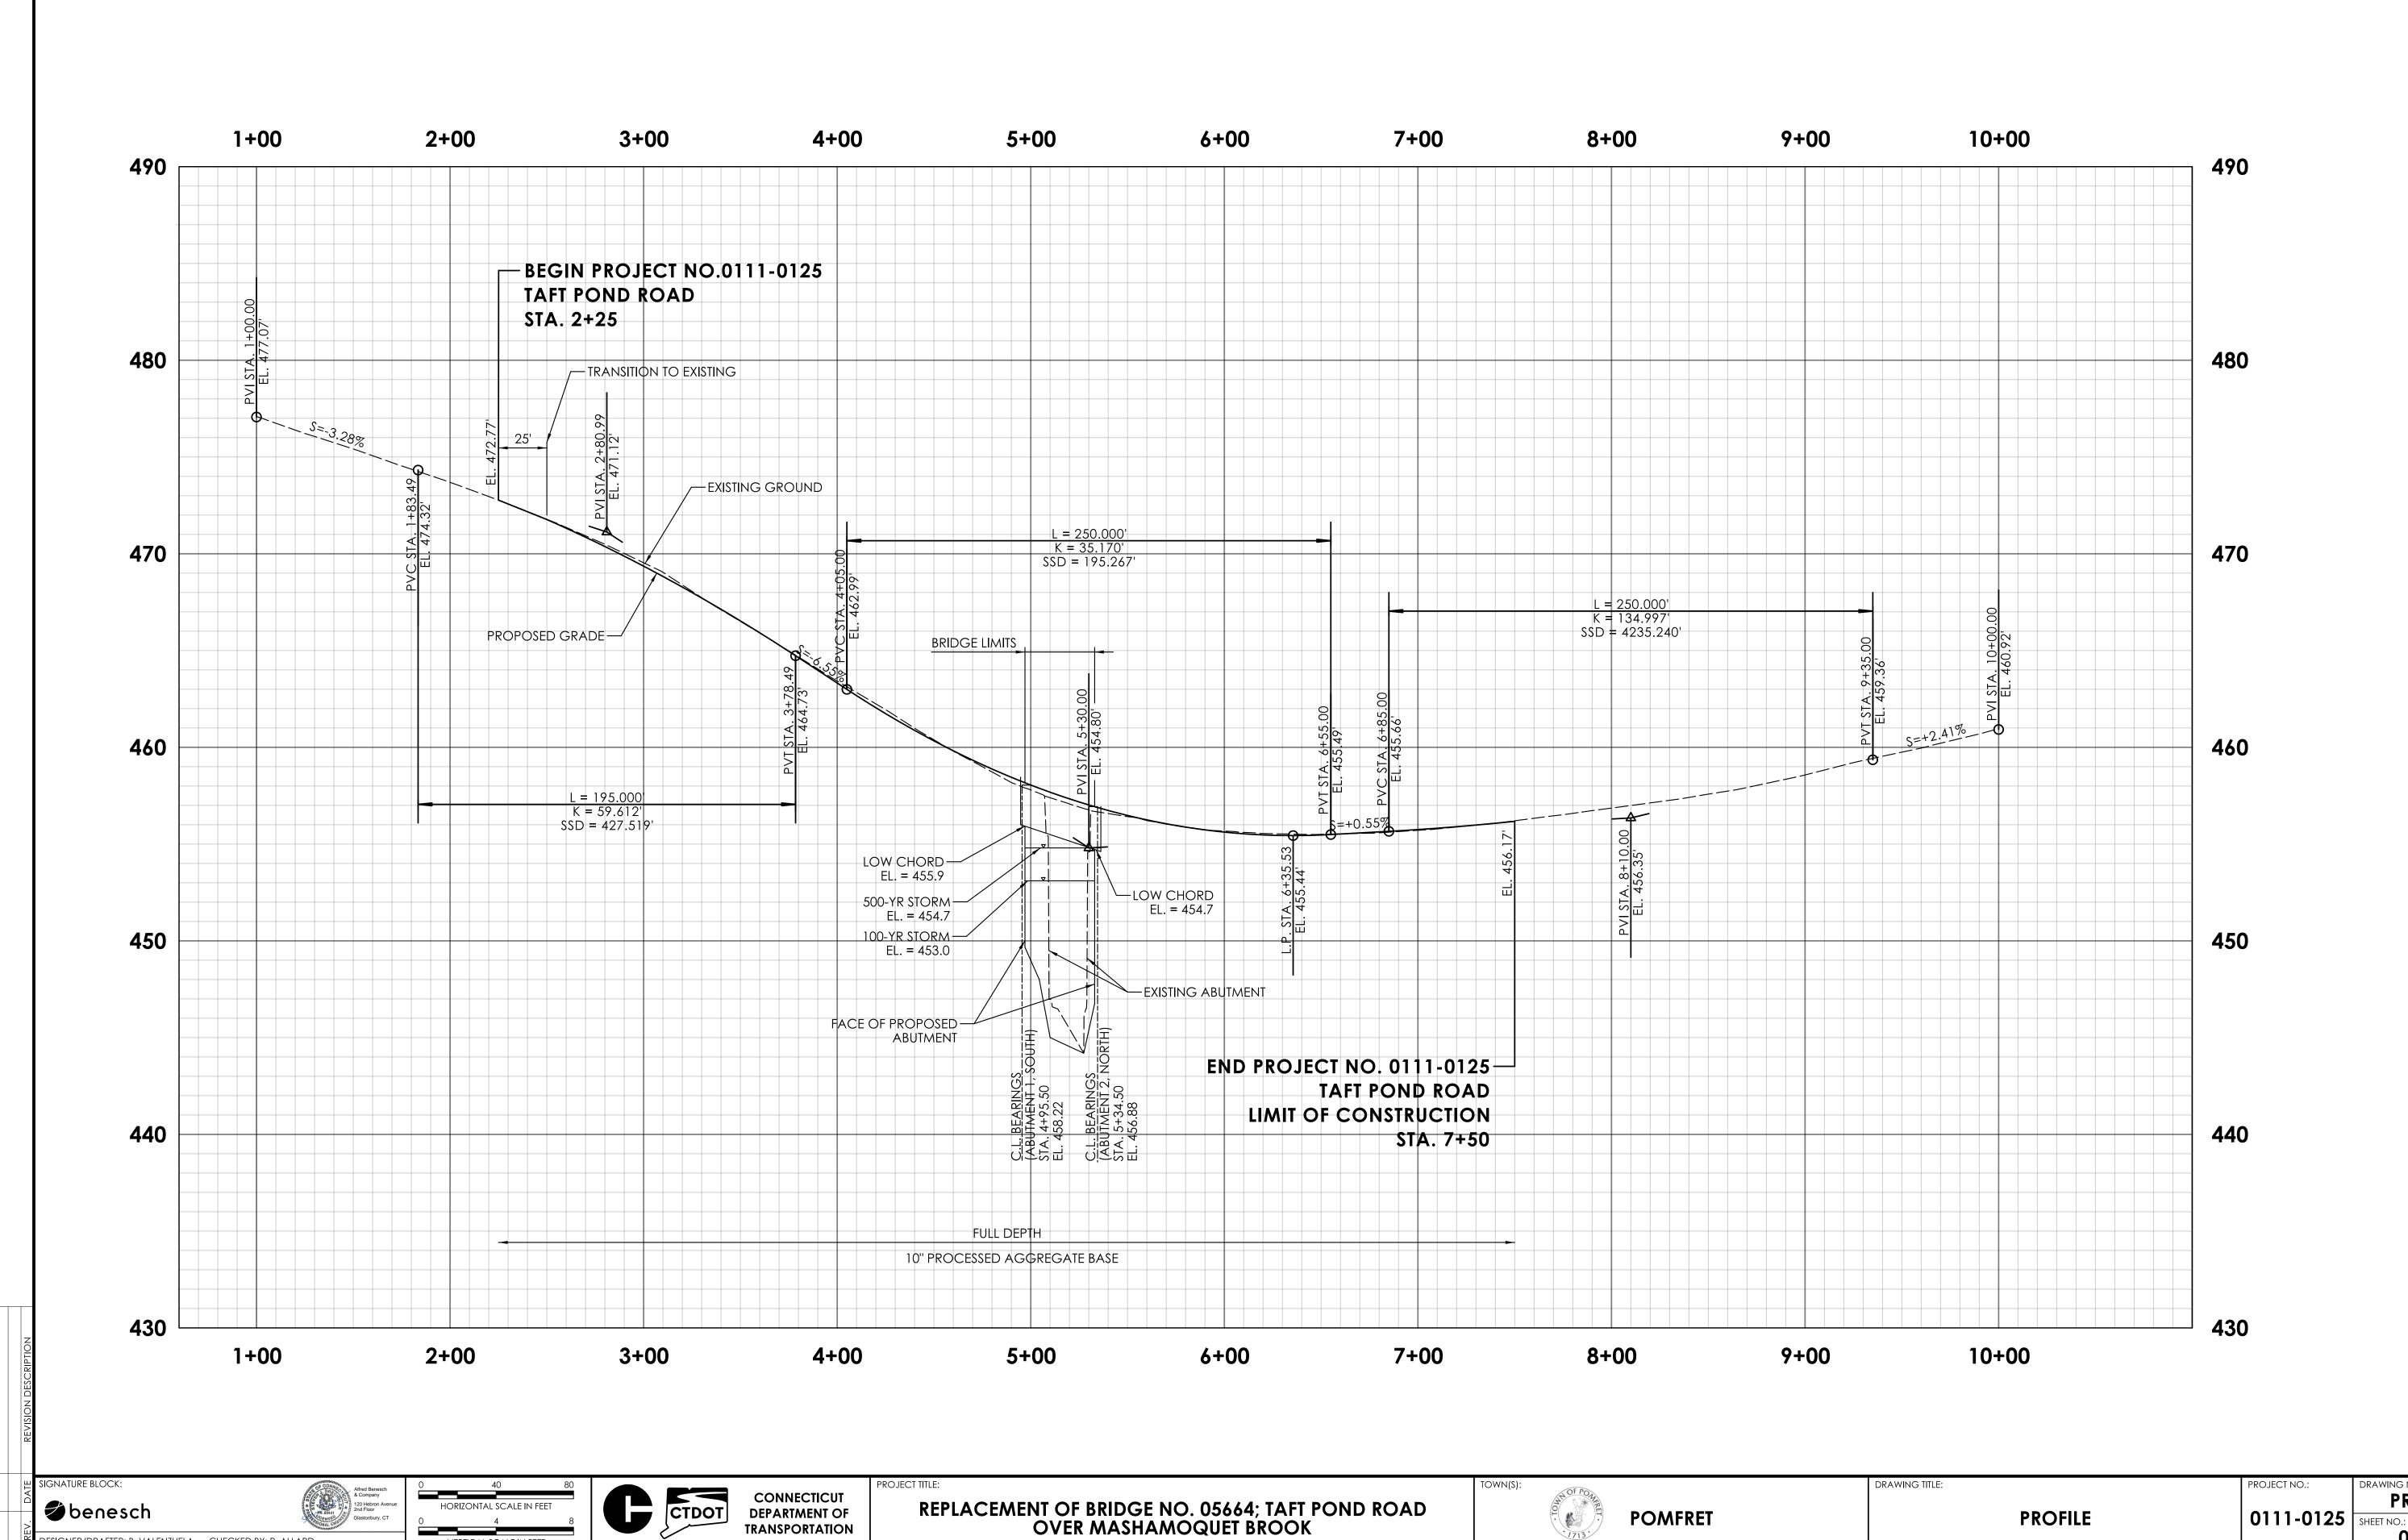



PRO-01


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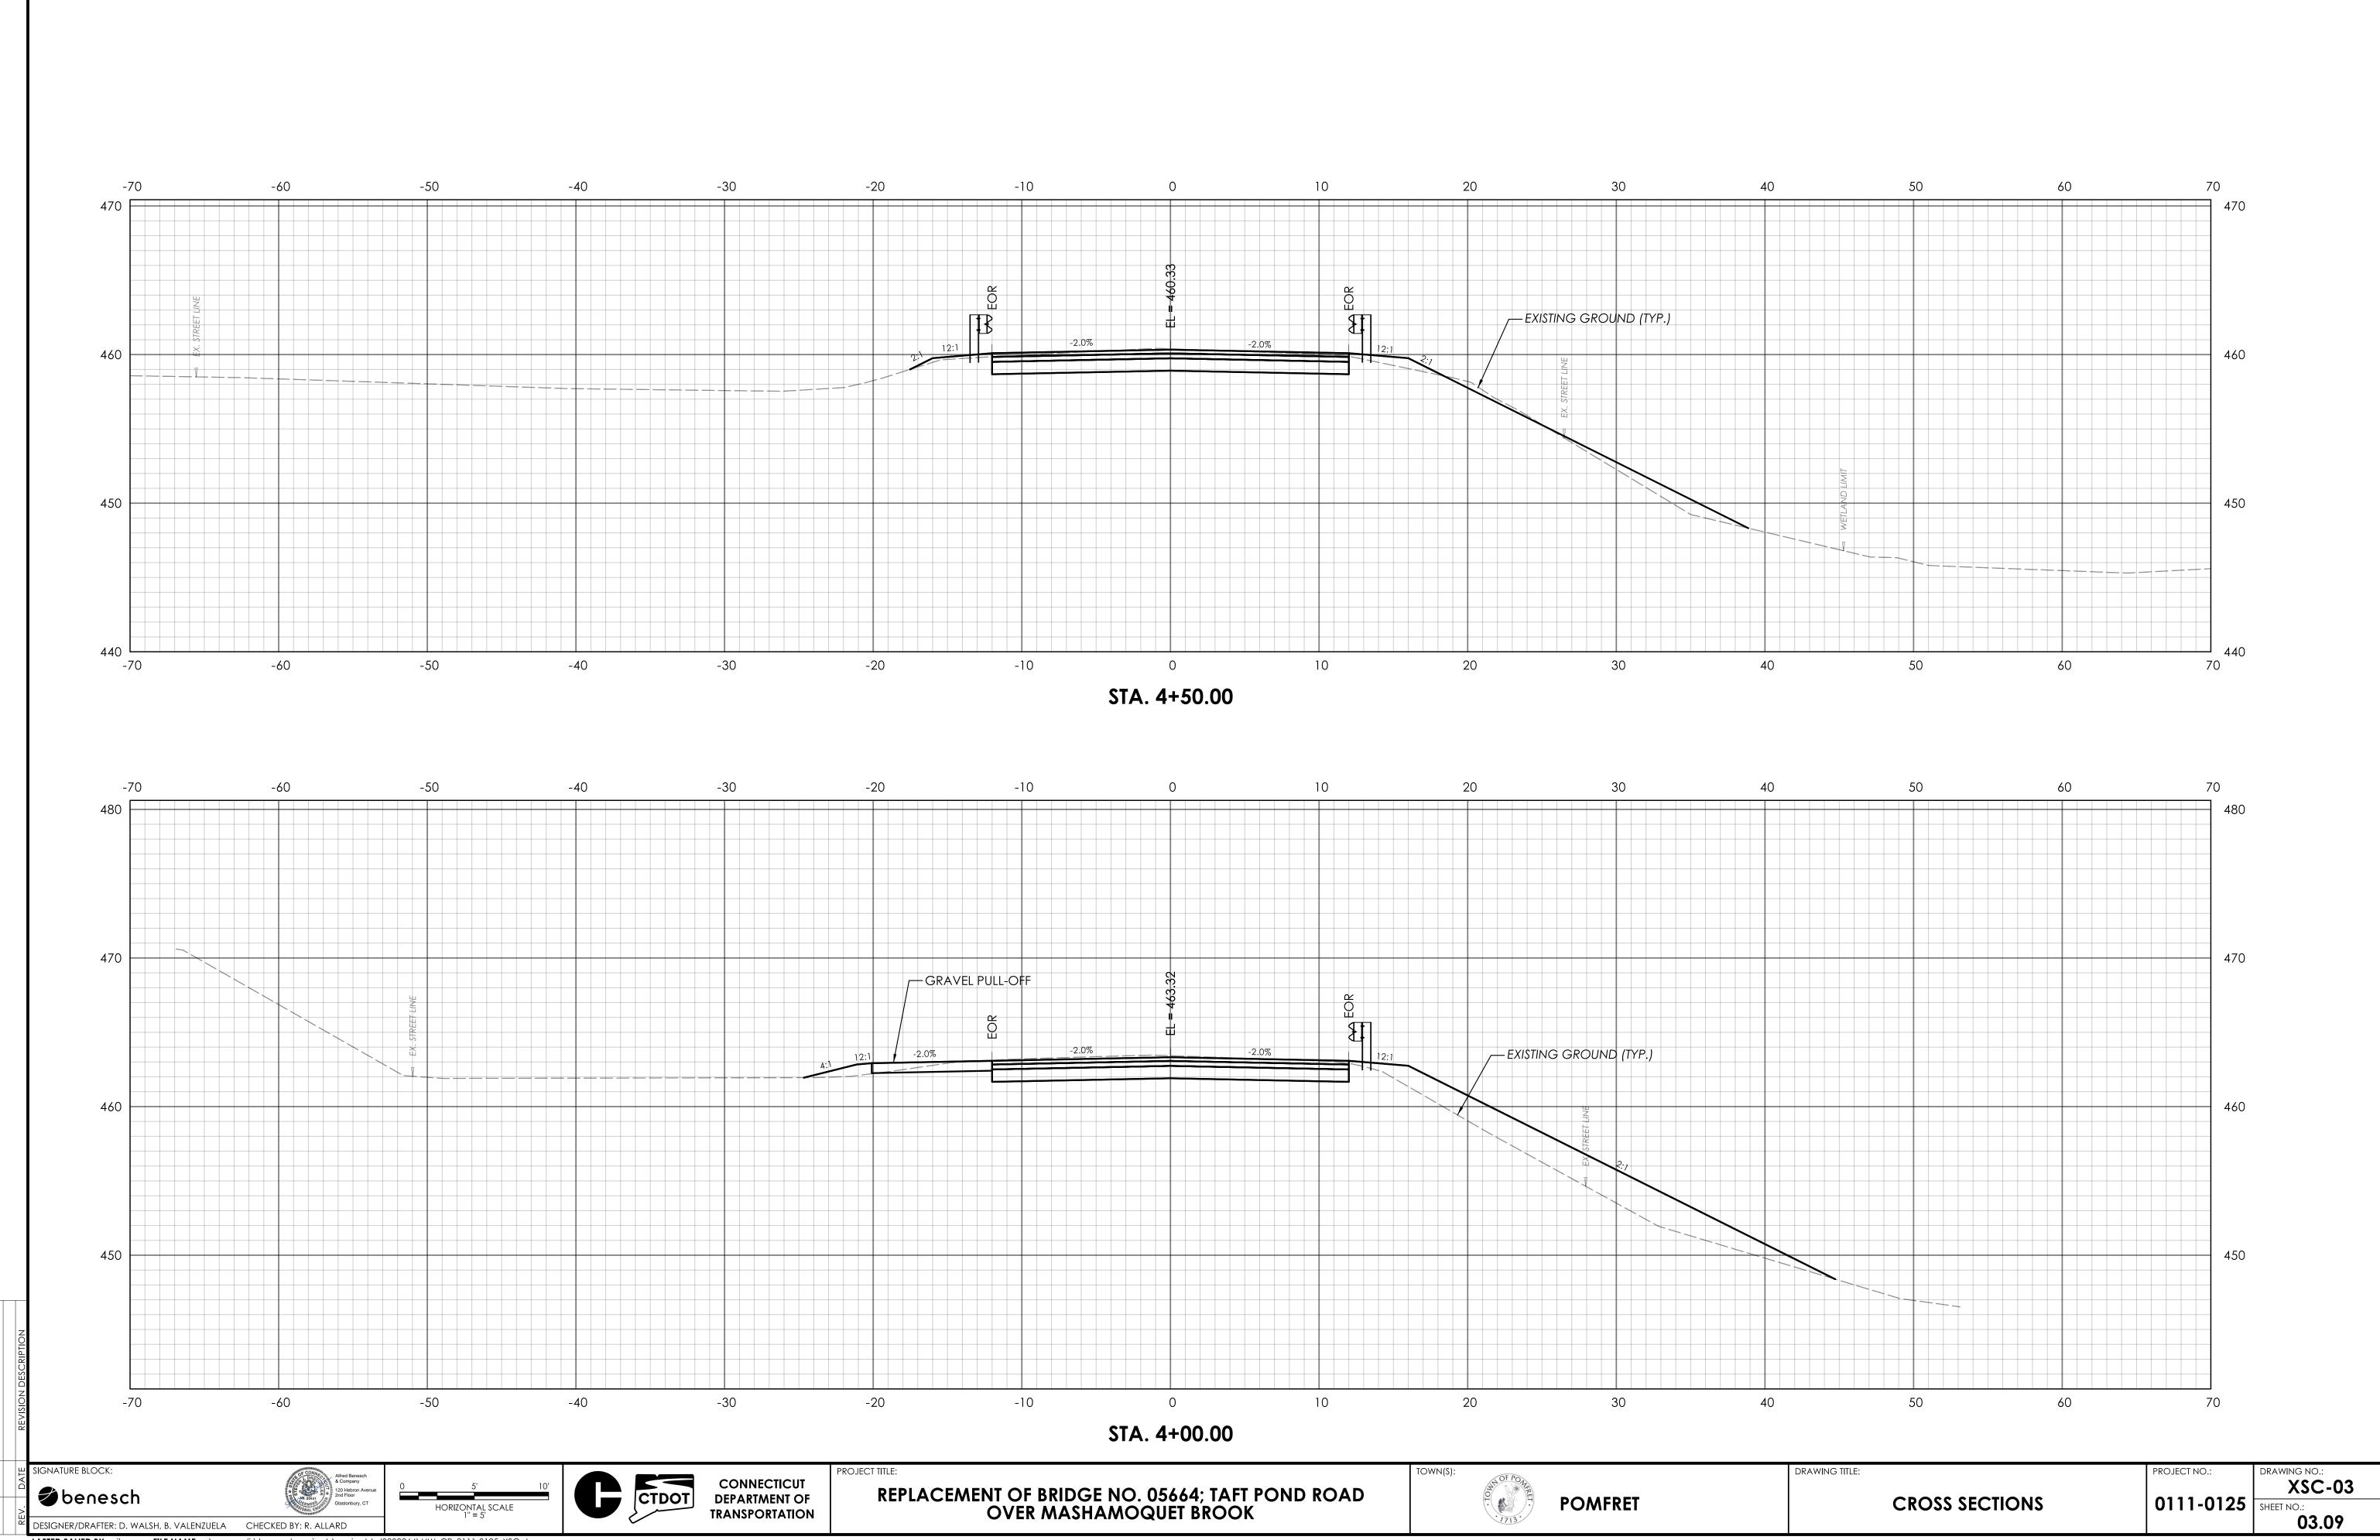
VERTICAL SCALE IN FEET


DESIGNER/DRAFTER: B. VALENZUELA CHECKED BY: R. ALLARD




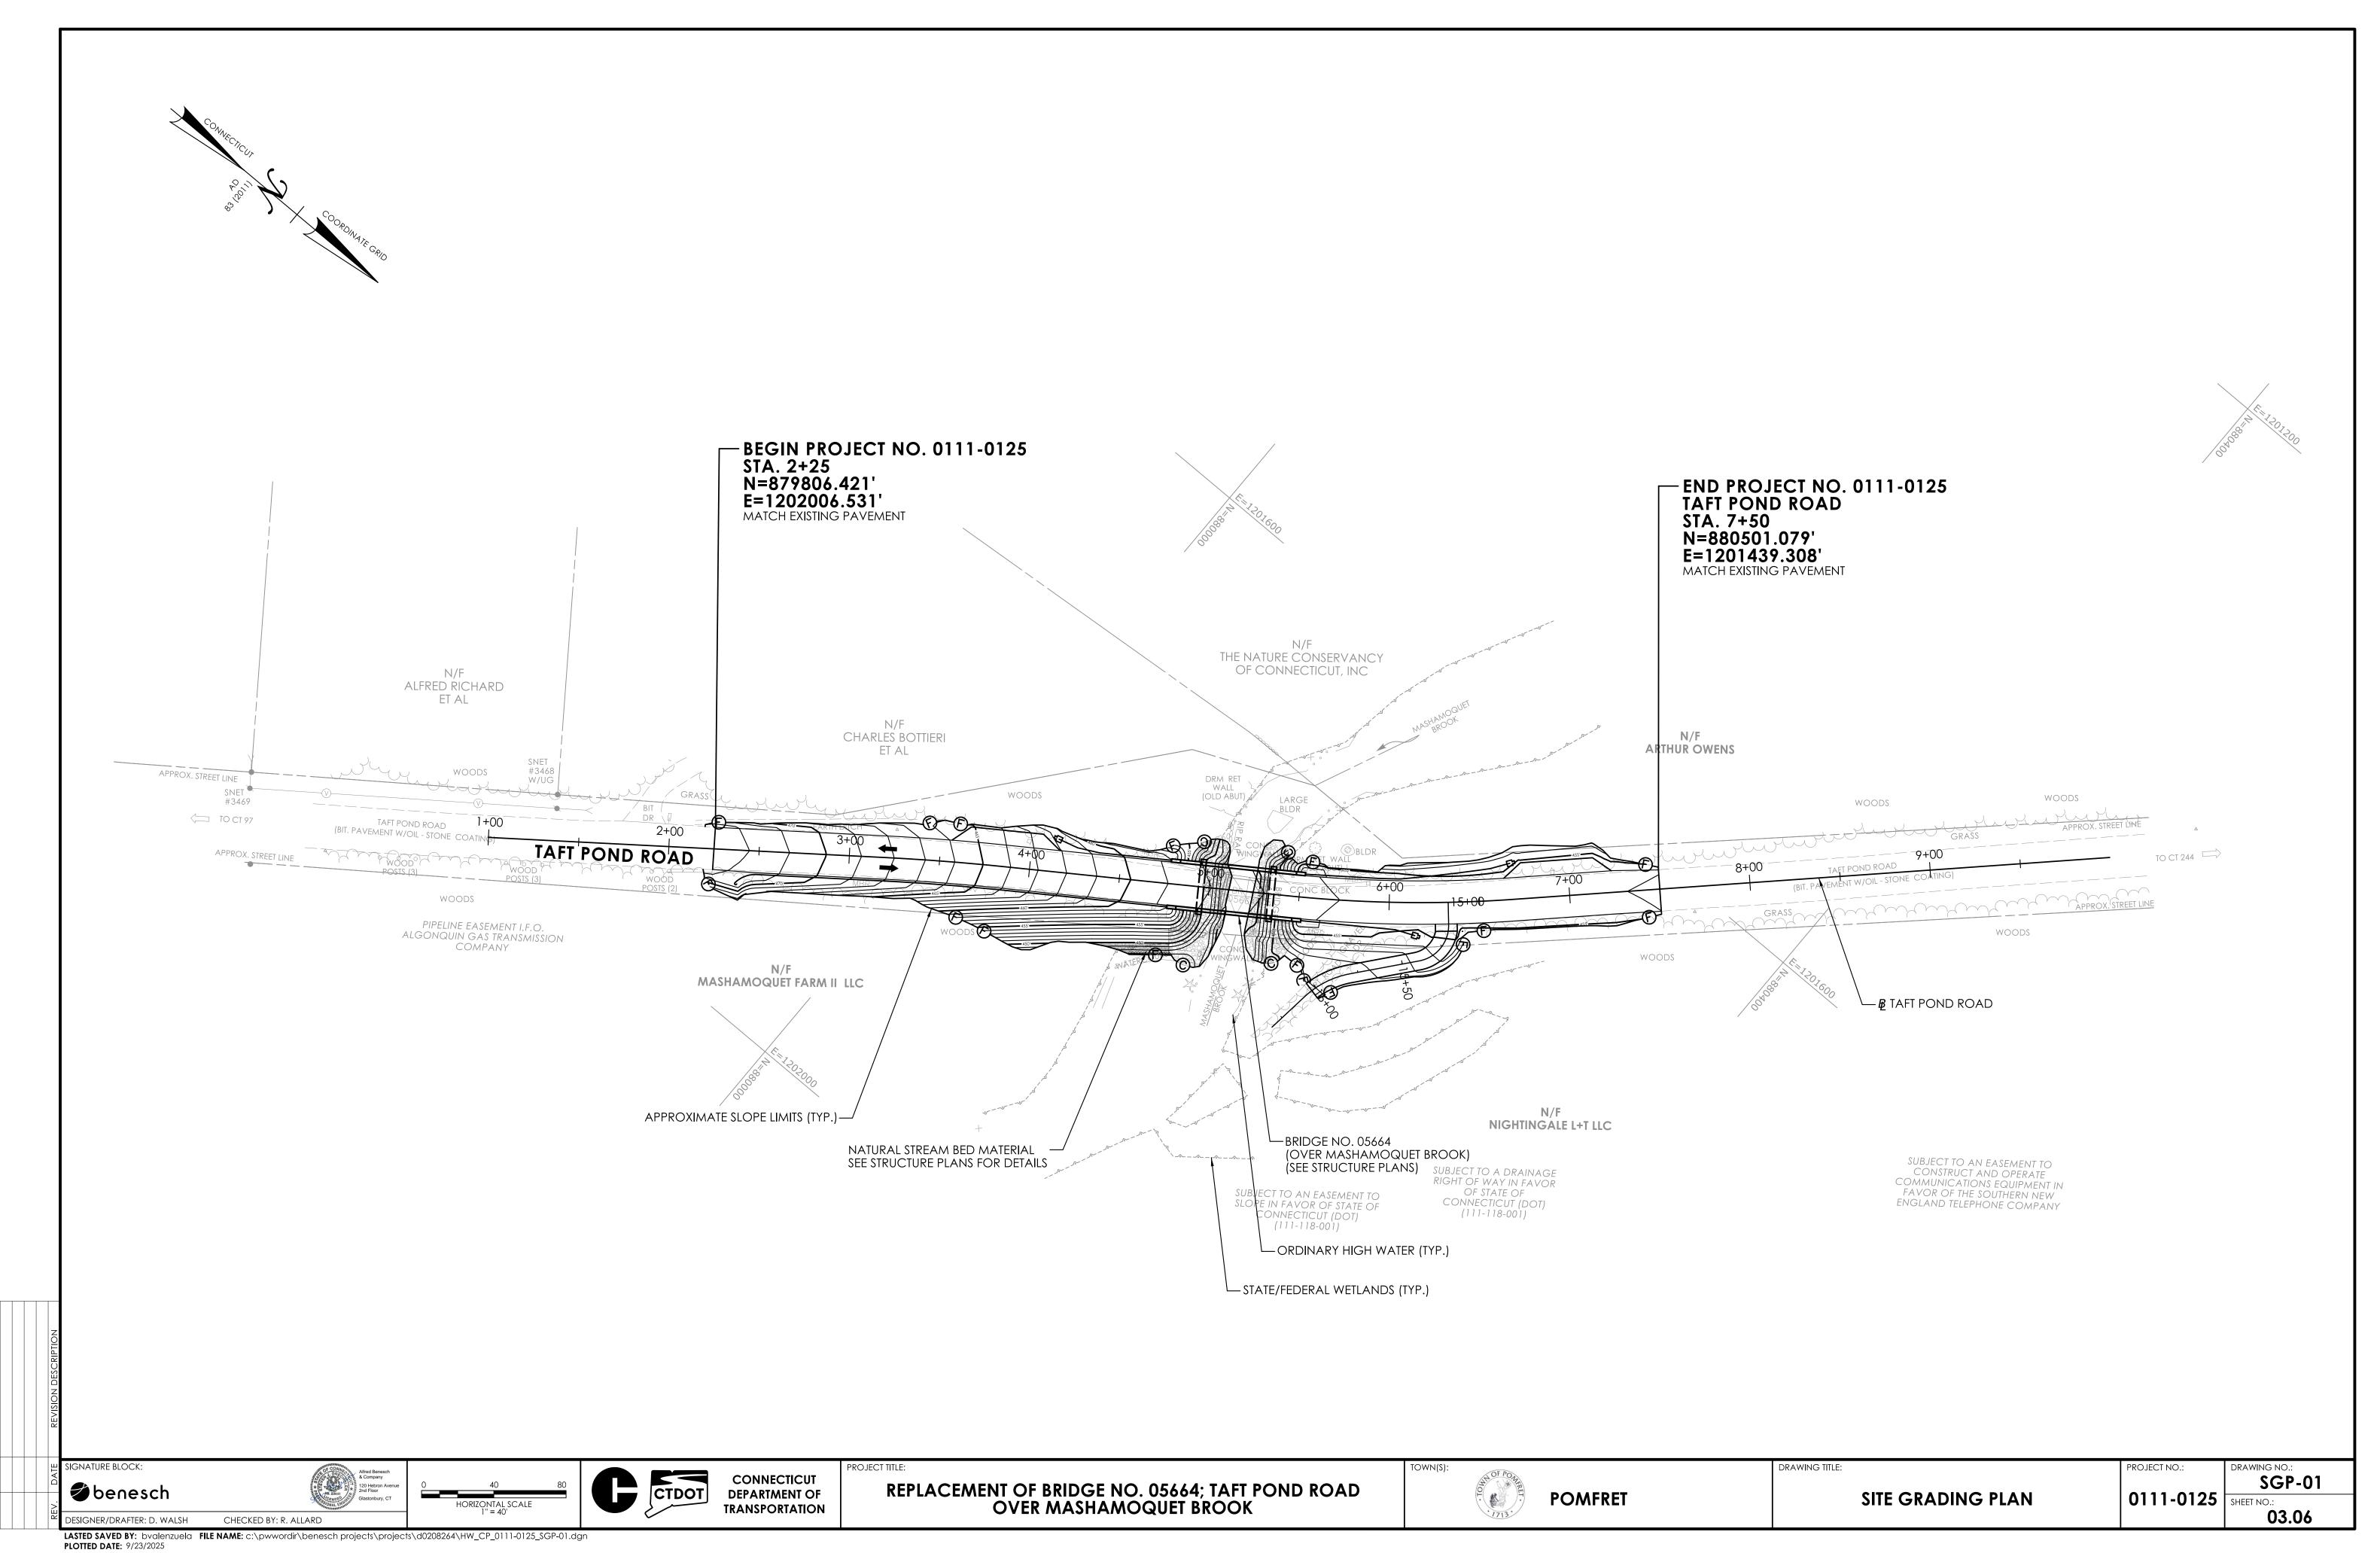


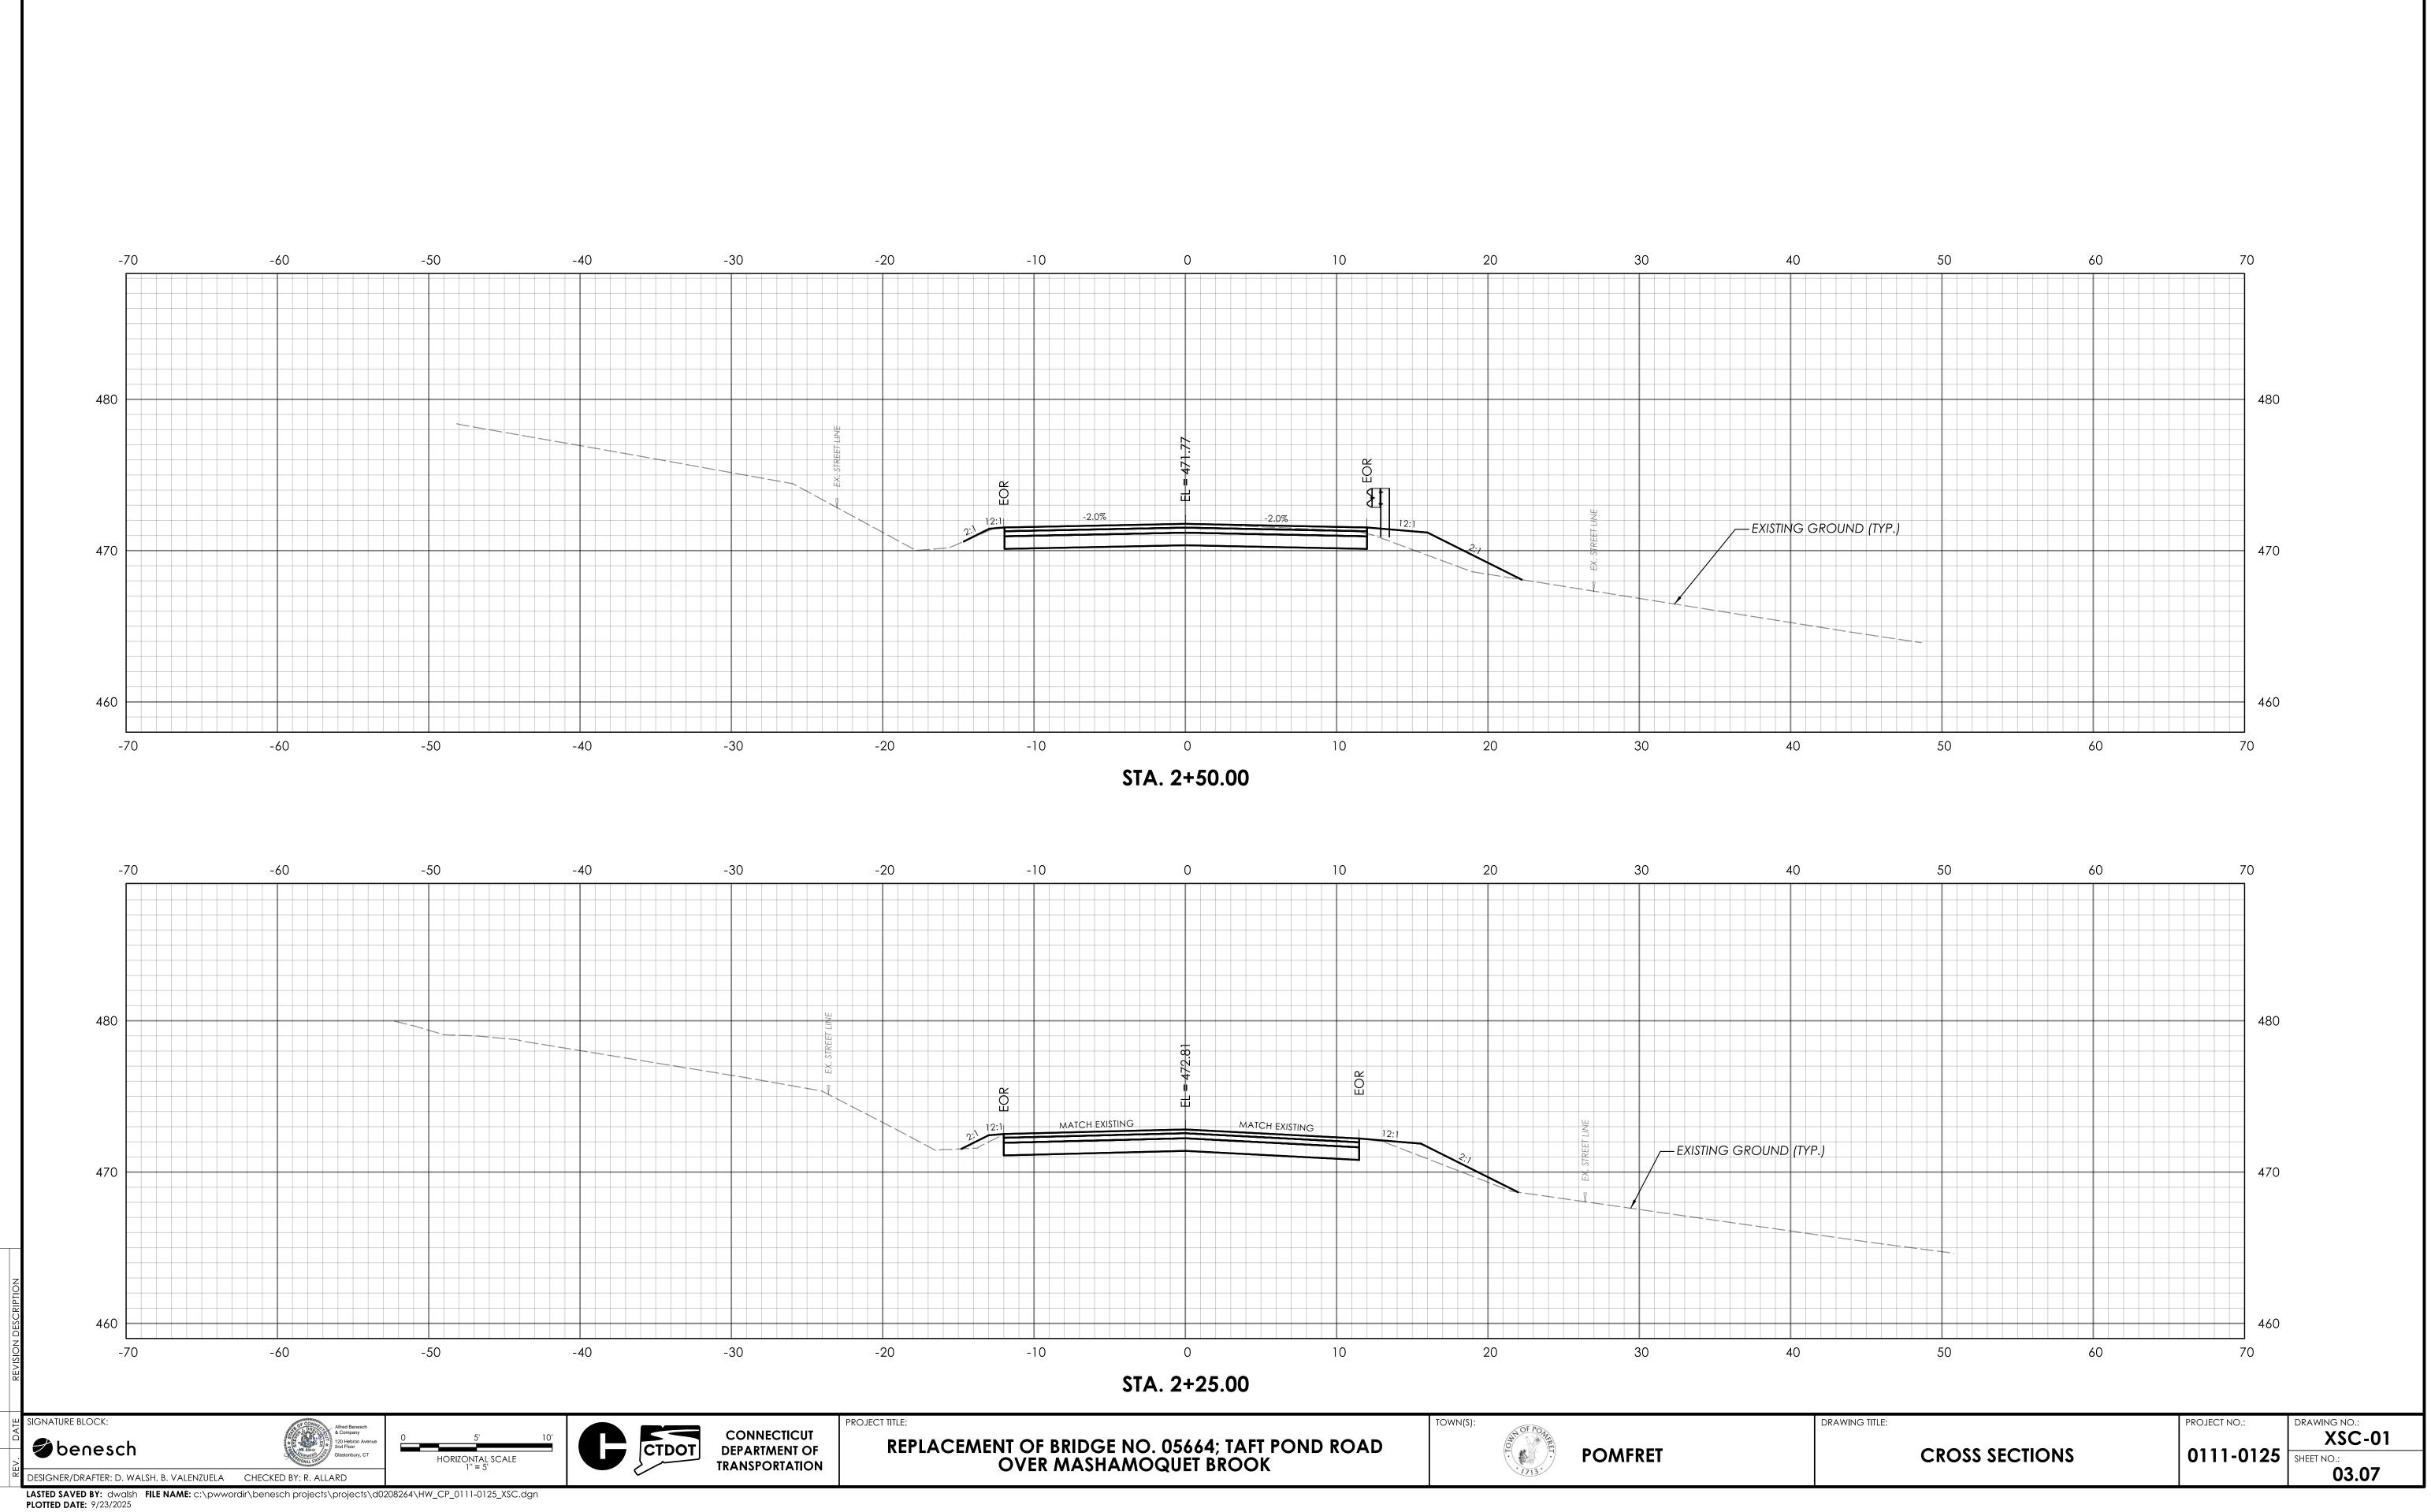

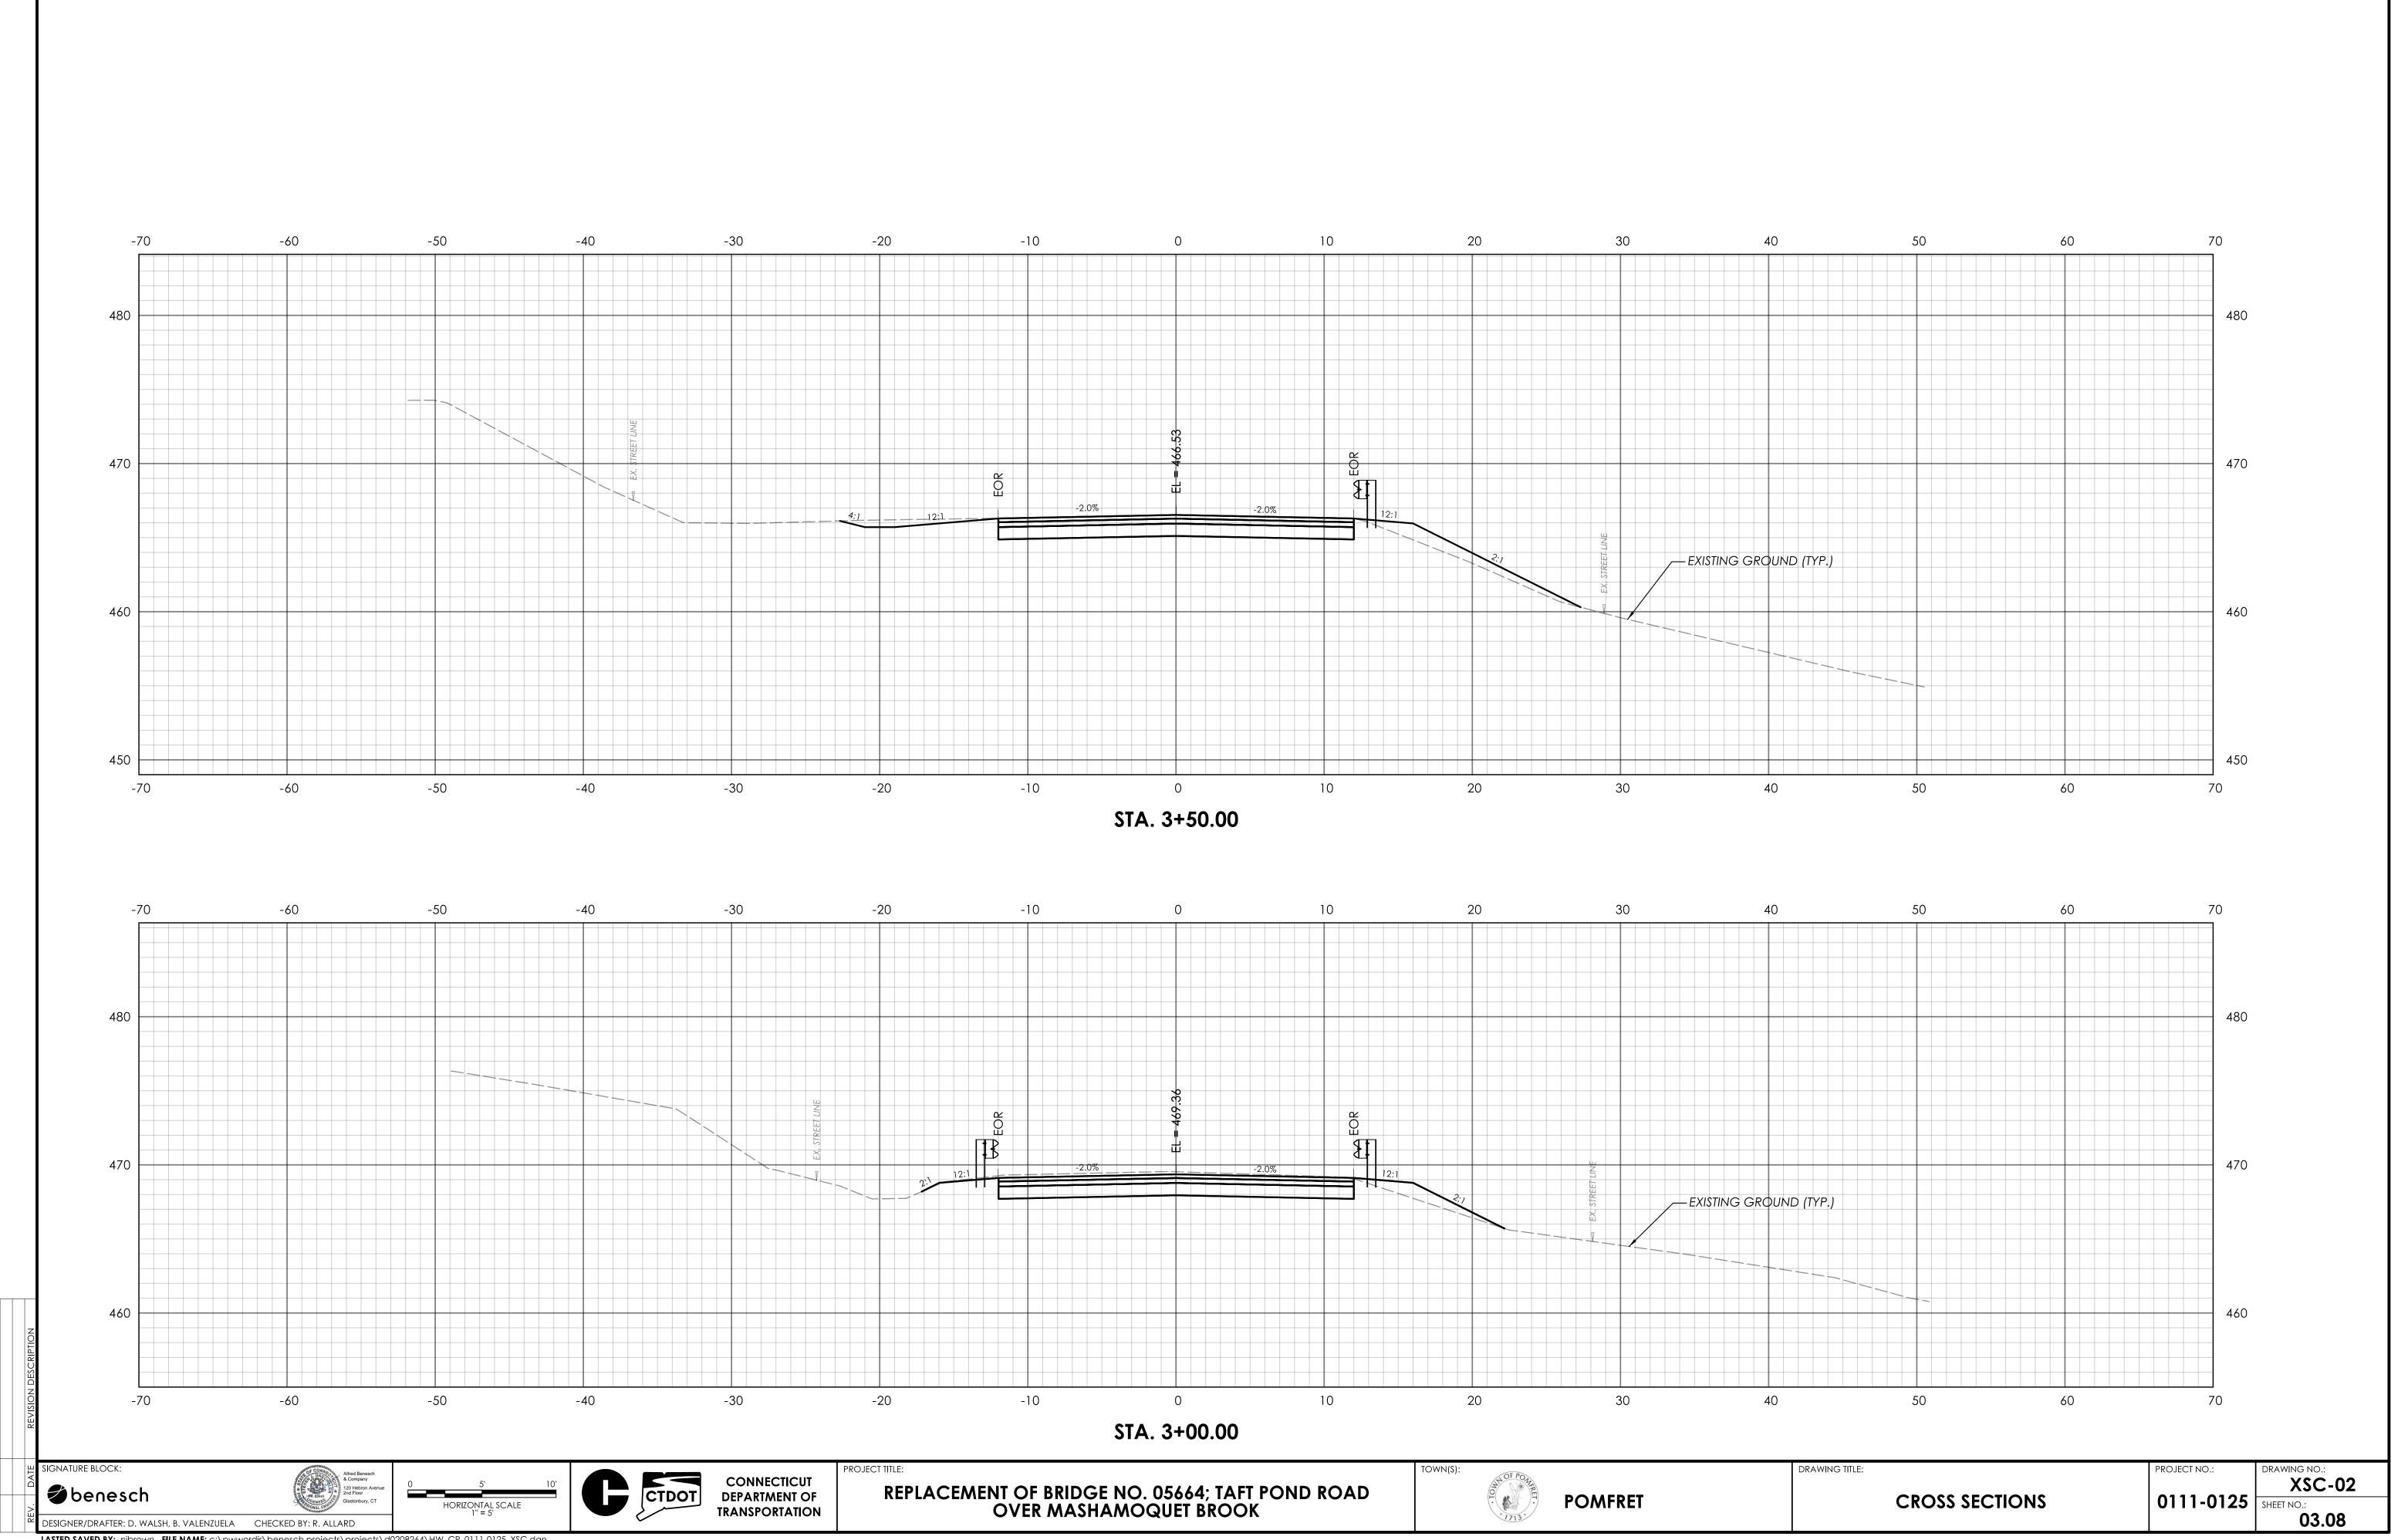


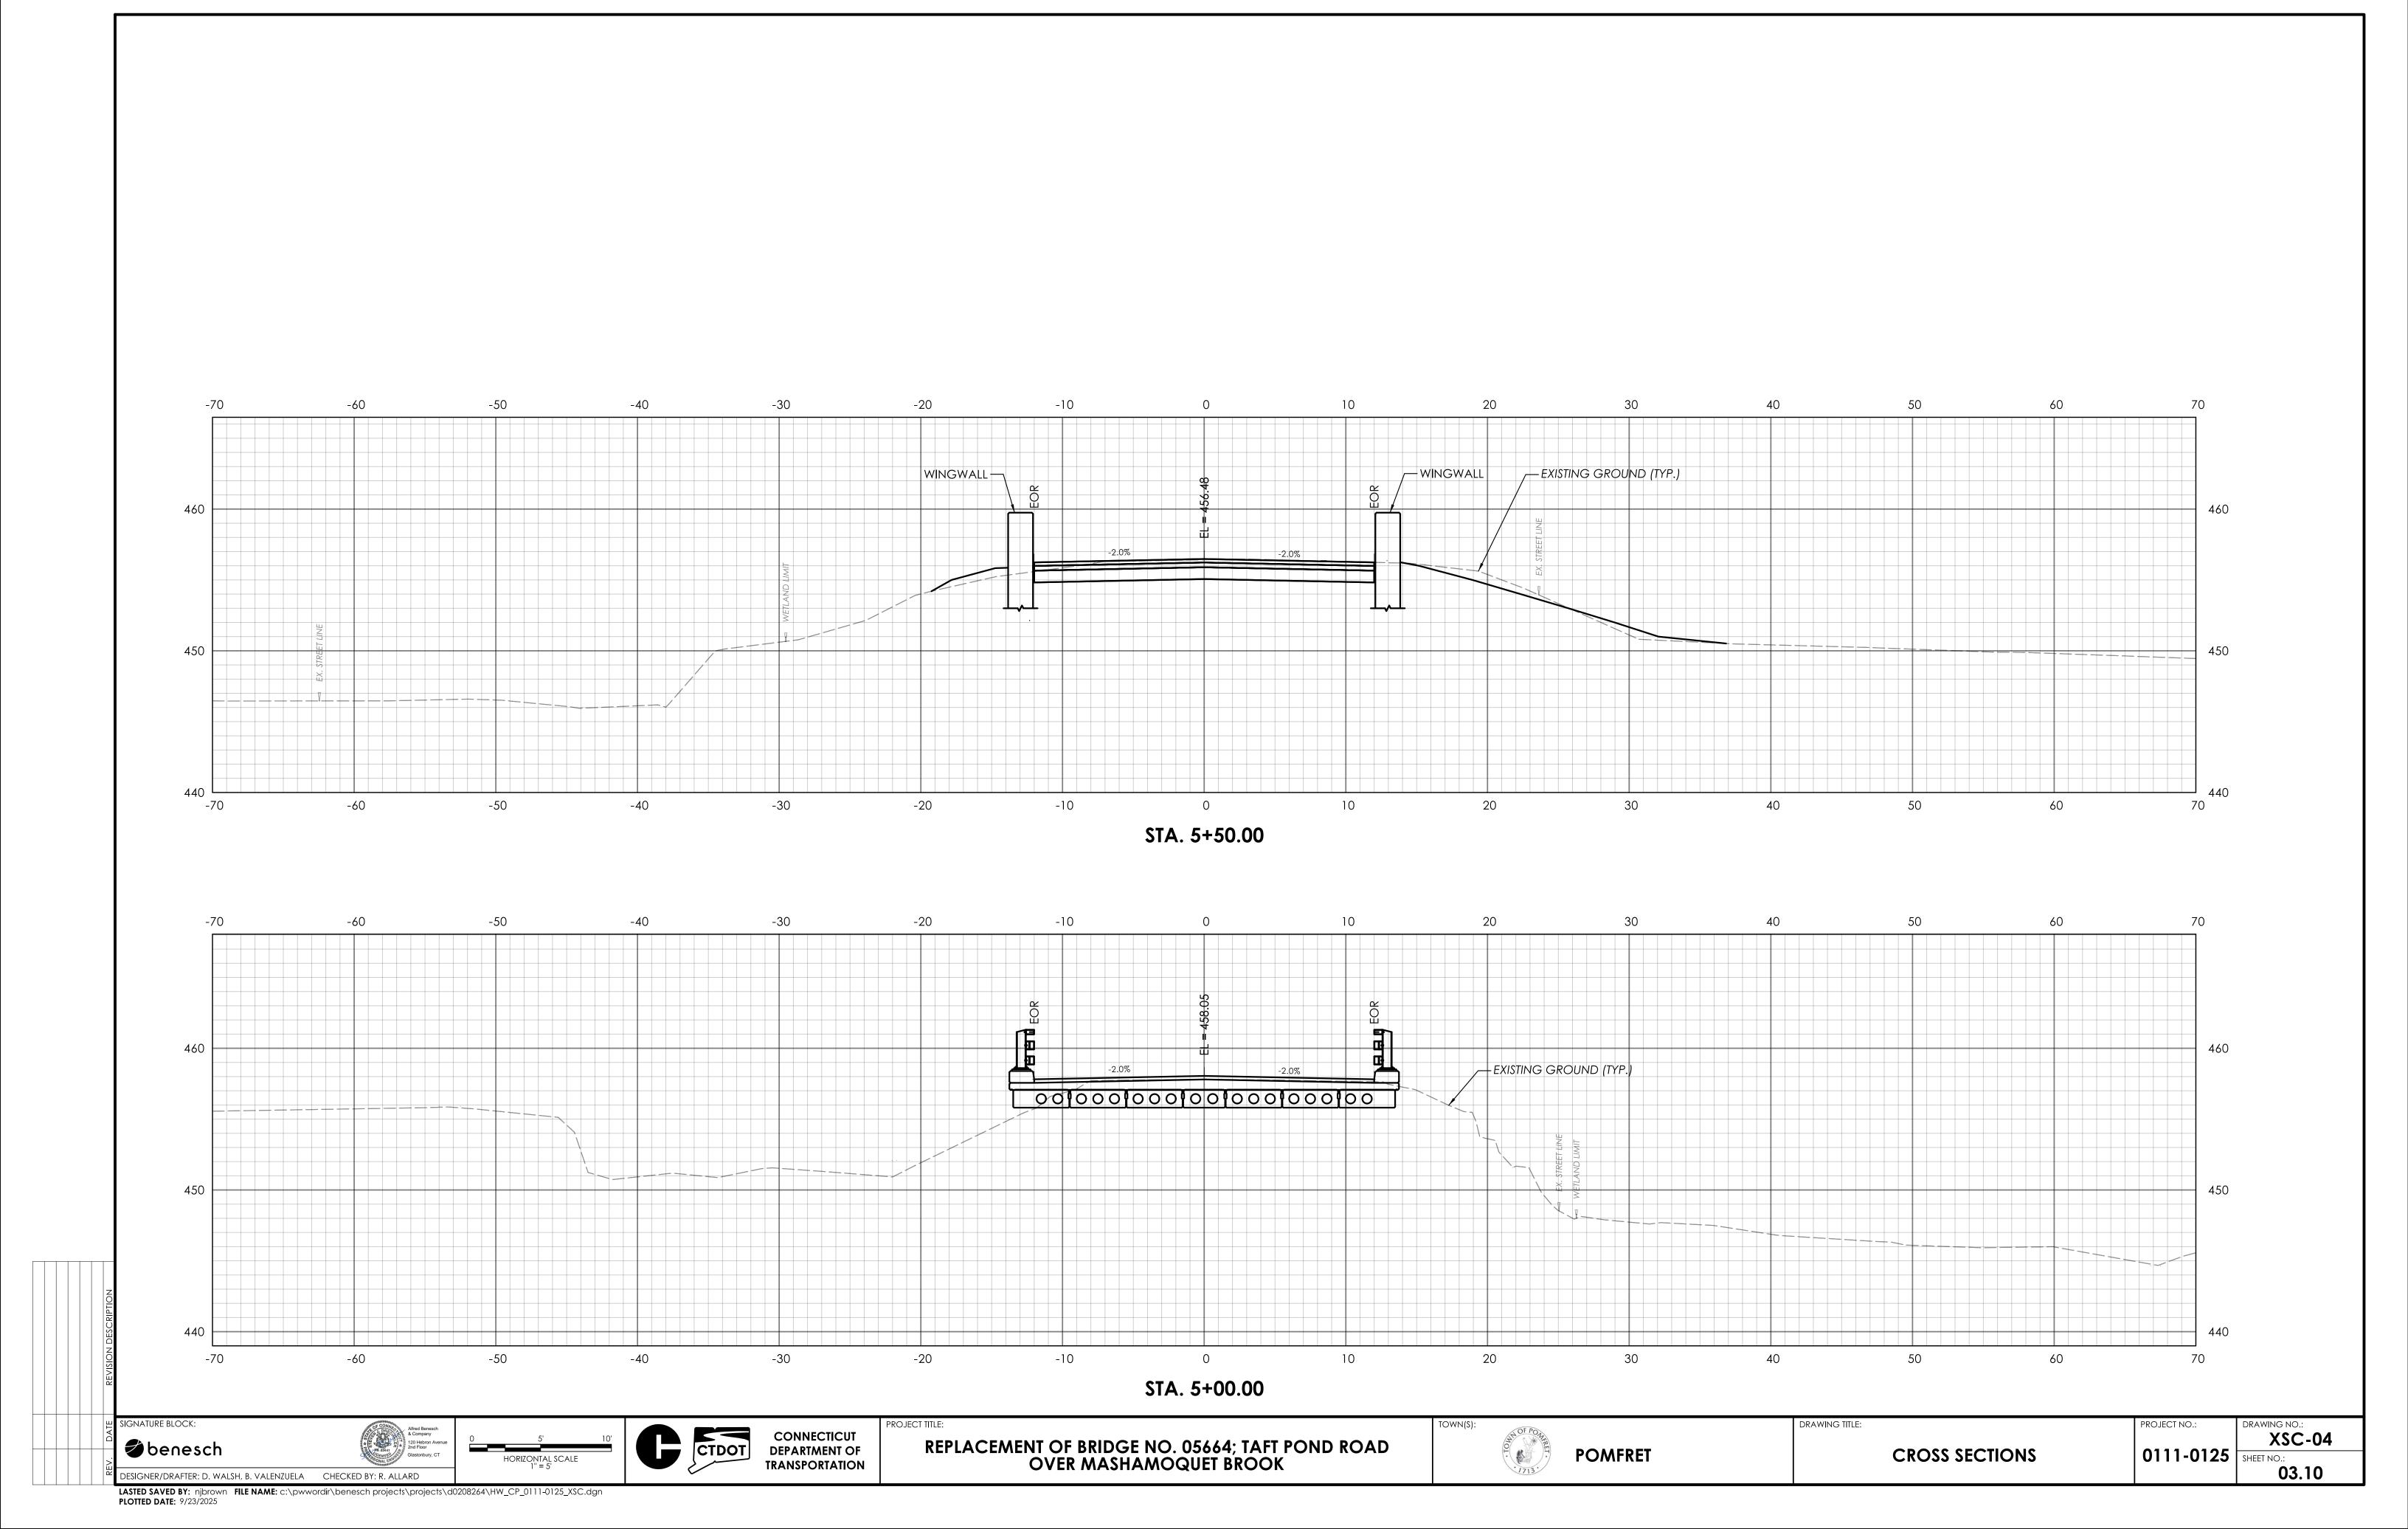

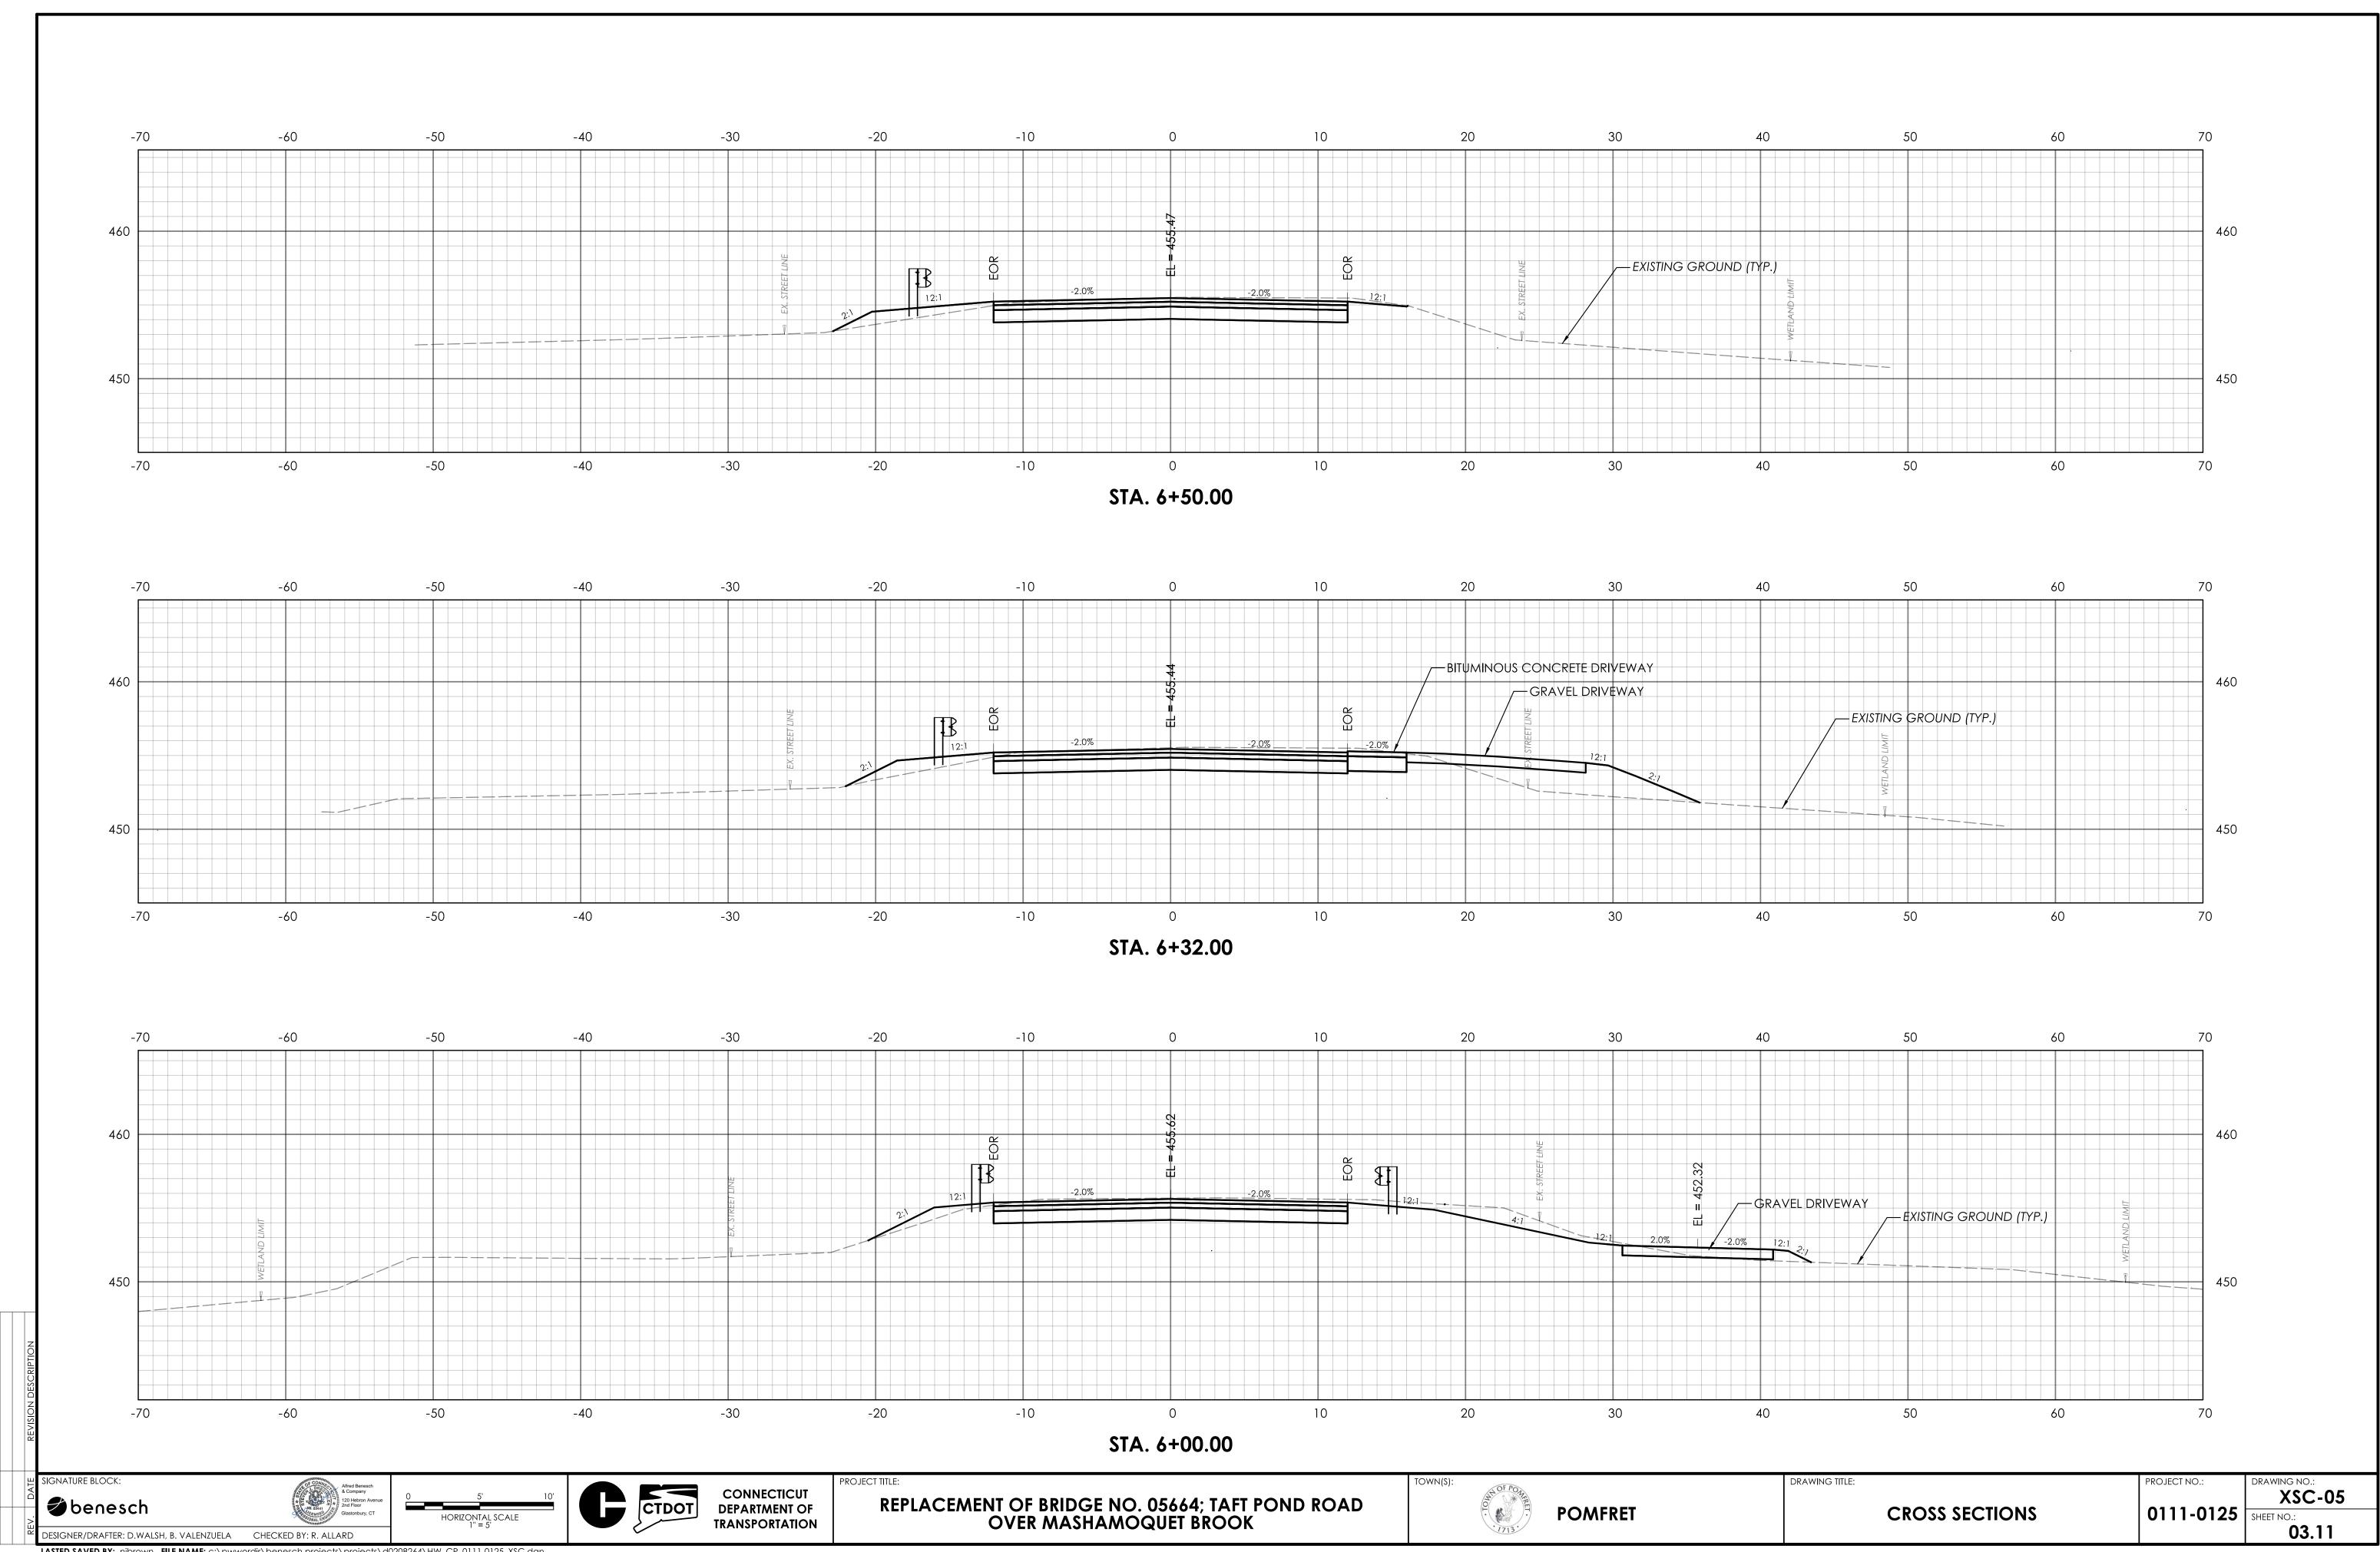

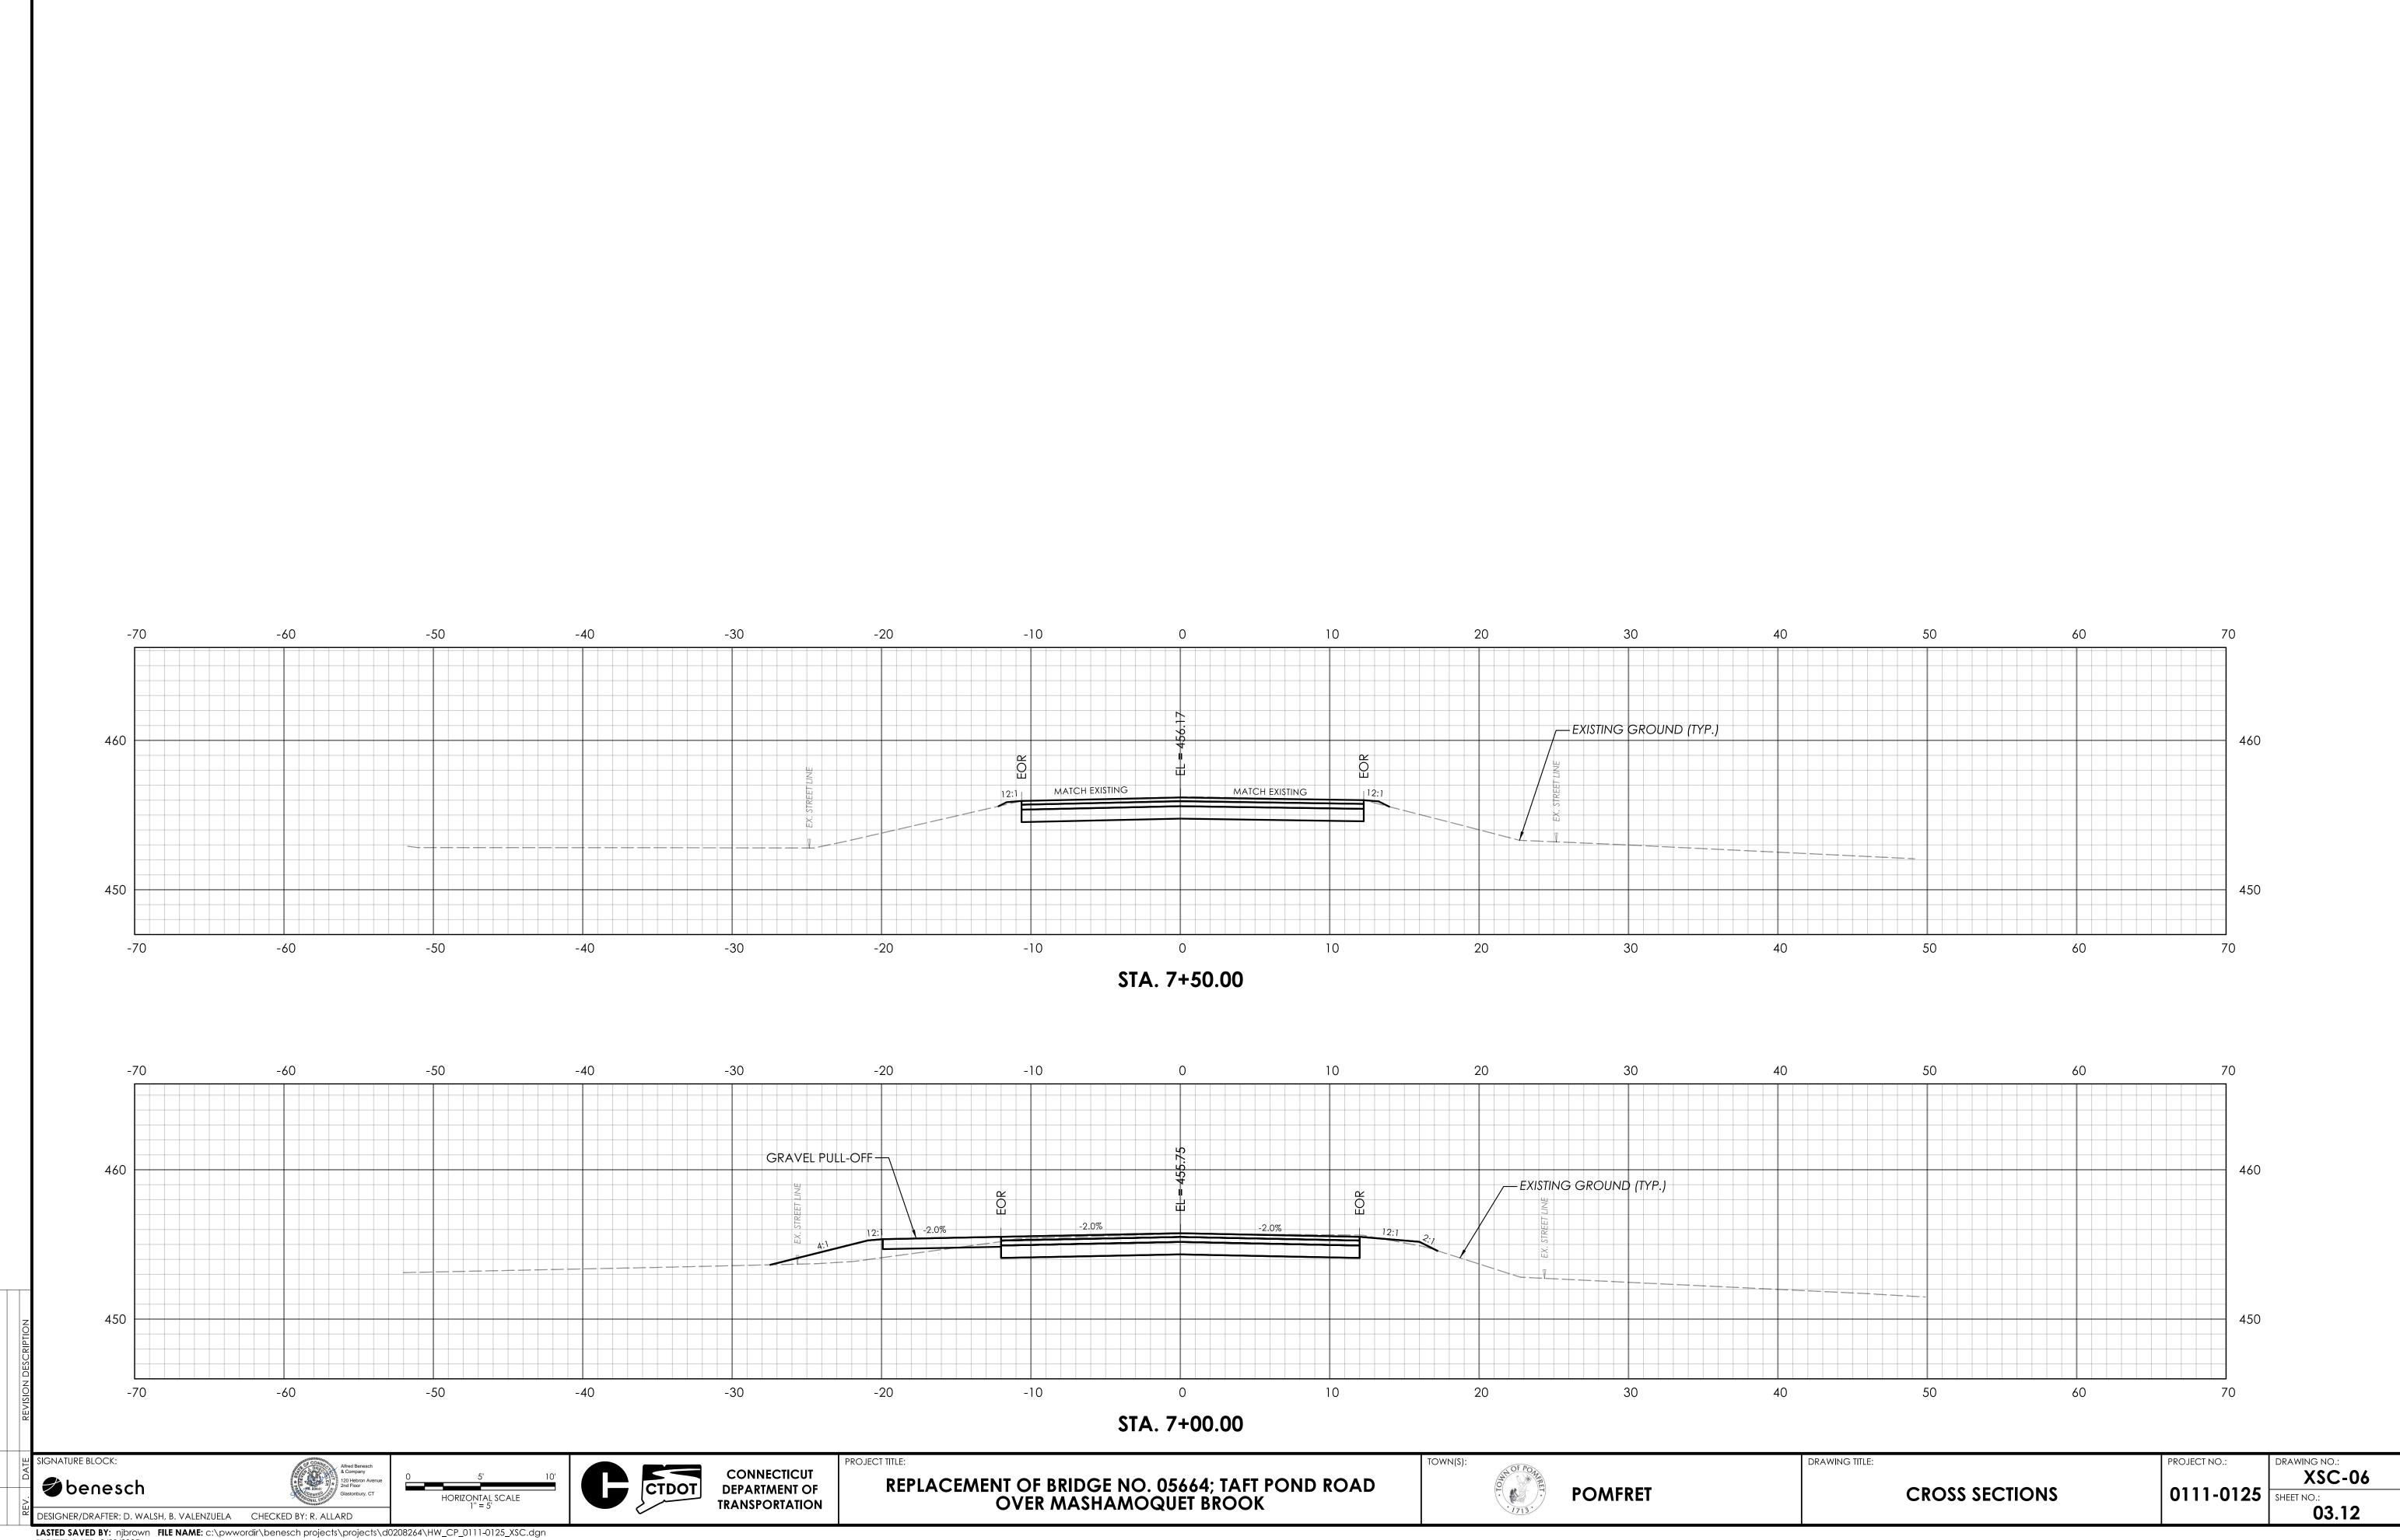


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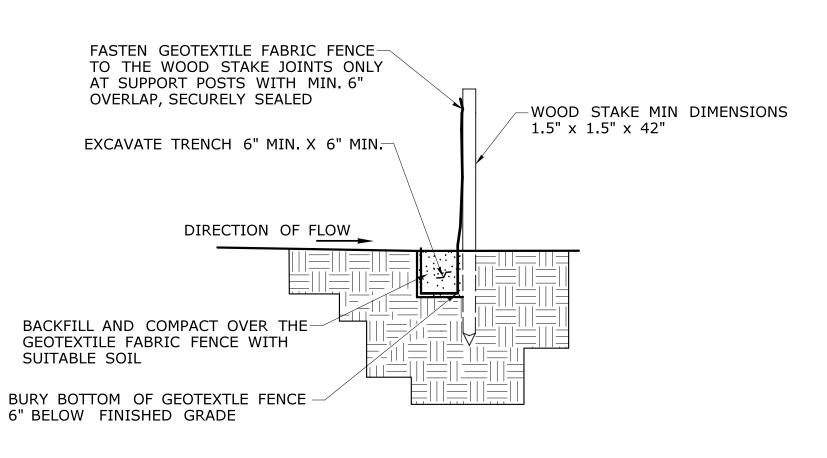


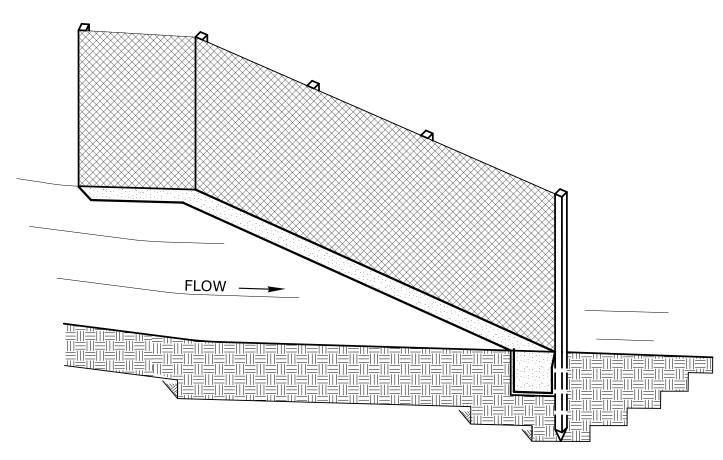SEDIMENTATION CONTROL SYSTEM


INSTALL THE WING WHEN THE FENCE IS MORE THAN 4' FROM THE TOE OF SLOPE AND THE FENCE LINE GRADIENT IS 5% OR MORE

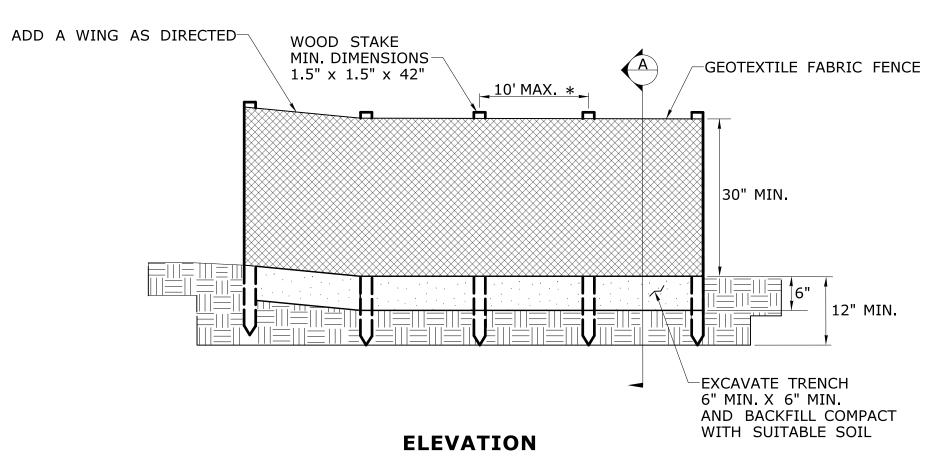


* FOR SLOPES STEEPER THAN 2:1 USE A 5'POST SPACING OR AS DIRECTED BY THE ENGINEER



FLOW-SEDIMENTATION CONTROL SYSTEM

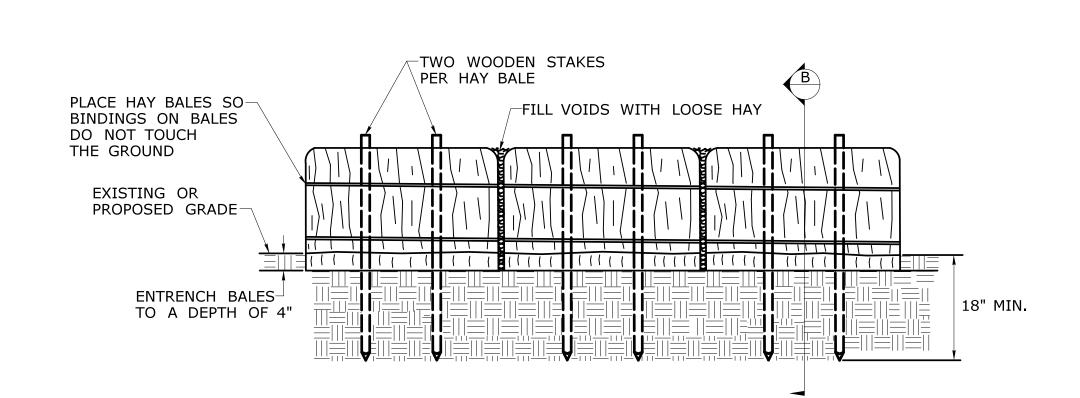

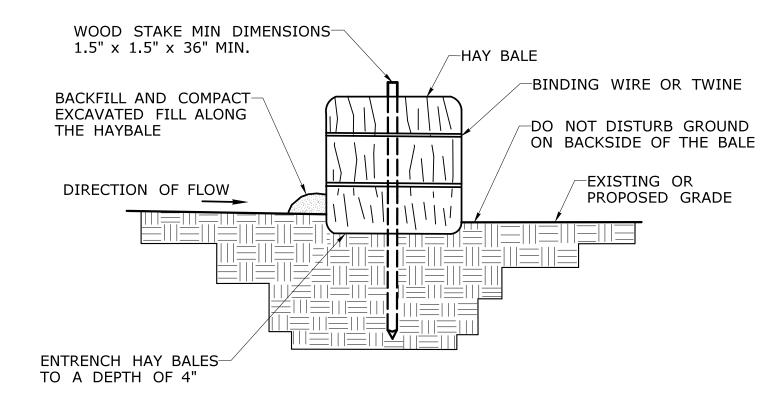

ELEVATION

SECTION B

SIGNATURE BLOCK:

benesch

Alfred Benesch & Company 120 Hebron Avenue 2nd Floor Glastonbury, CT

NOT TO SCALE



SECTION A

CONNECTICUT DEPARTMENT OF TRANSPORTATION

REPLACEMENT OF BRIDGE NO. 05664; TAFT POND ROAD OVER MASHAMOQUET BROOK




POMFRET

DRAWING TITLE: MISCELLANEOUS DETAIL

MDS-01 0111-0125 SHEET NO.: 03.13

CHECKED BY: R. ALLARD LASTED SAVED BY: dwalsh FILE NAME: c:\pwwordir\benesch projects\d0208264\HW_CP_0111-0125_MDS.dgn PLOTTED DATE: 9/23/2025

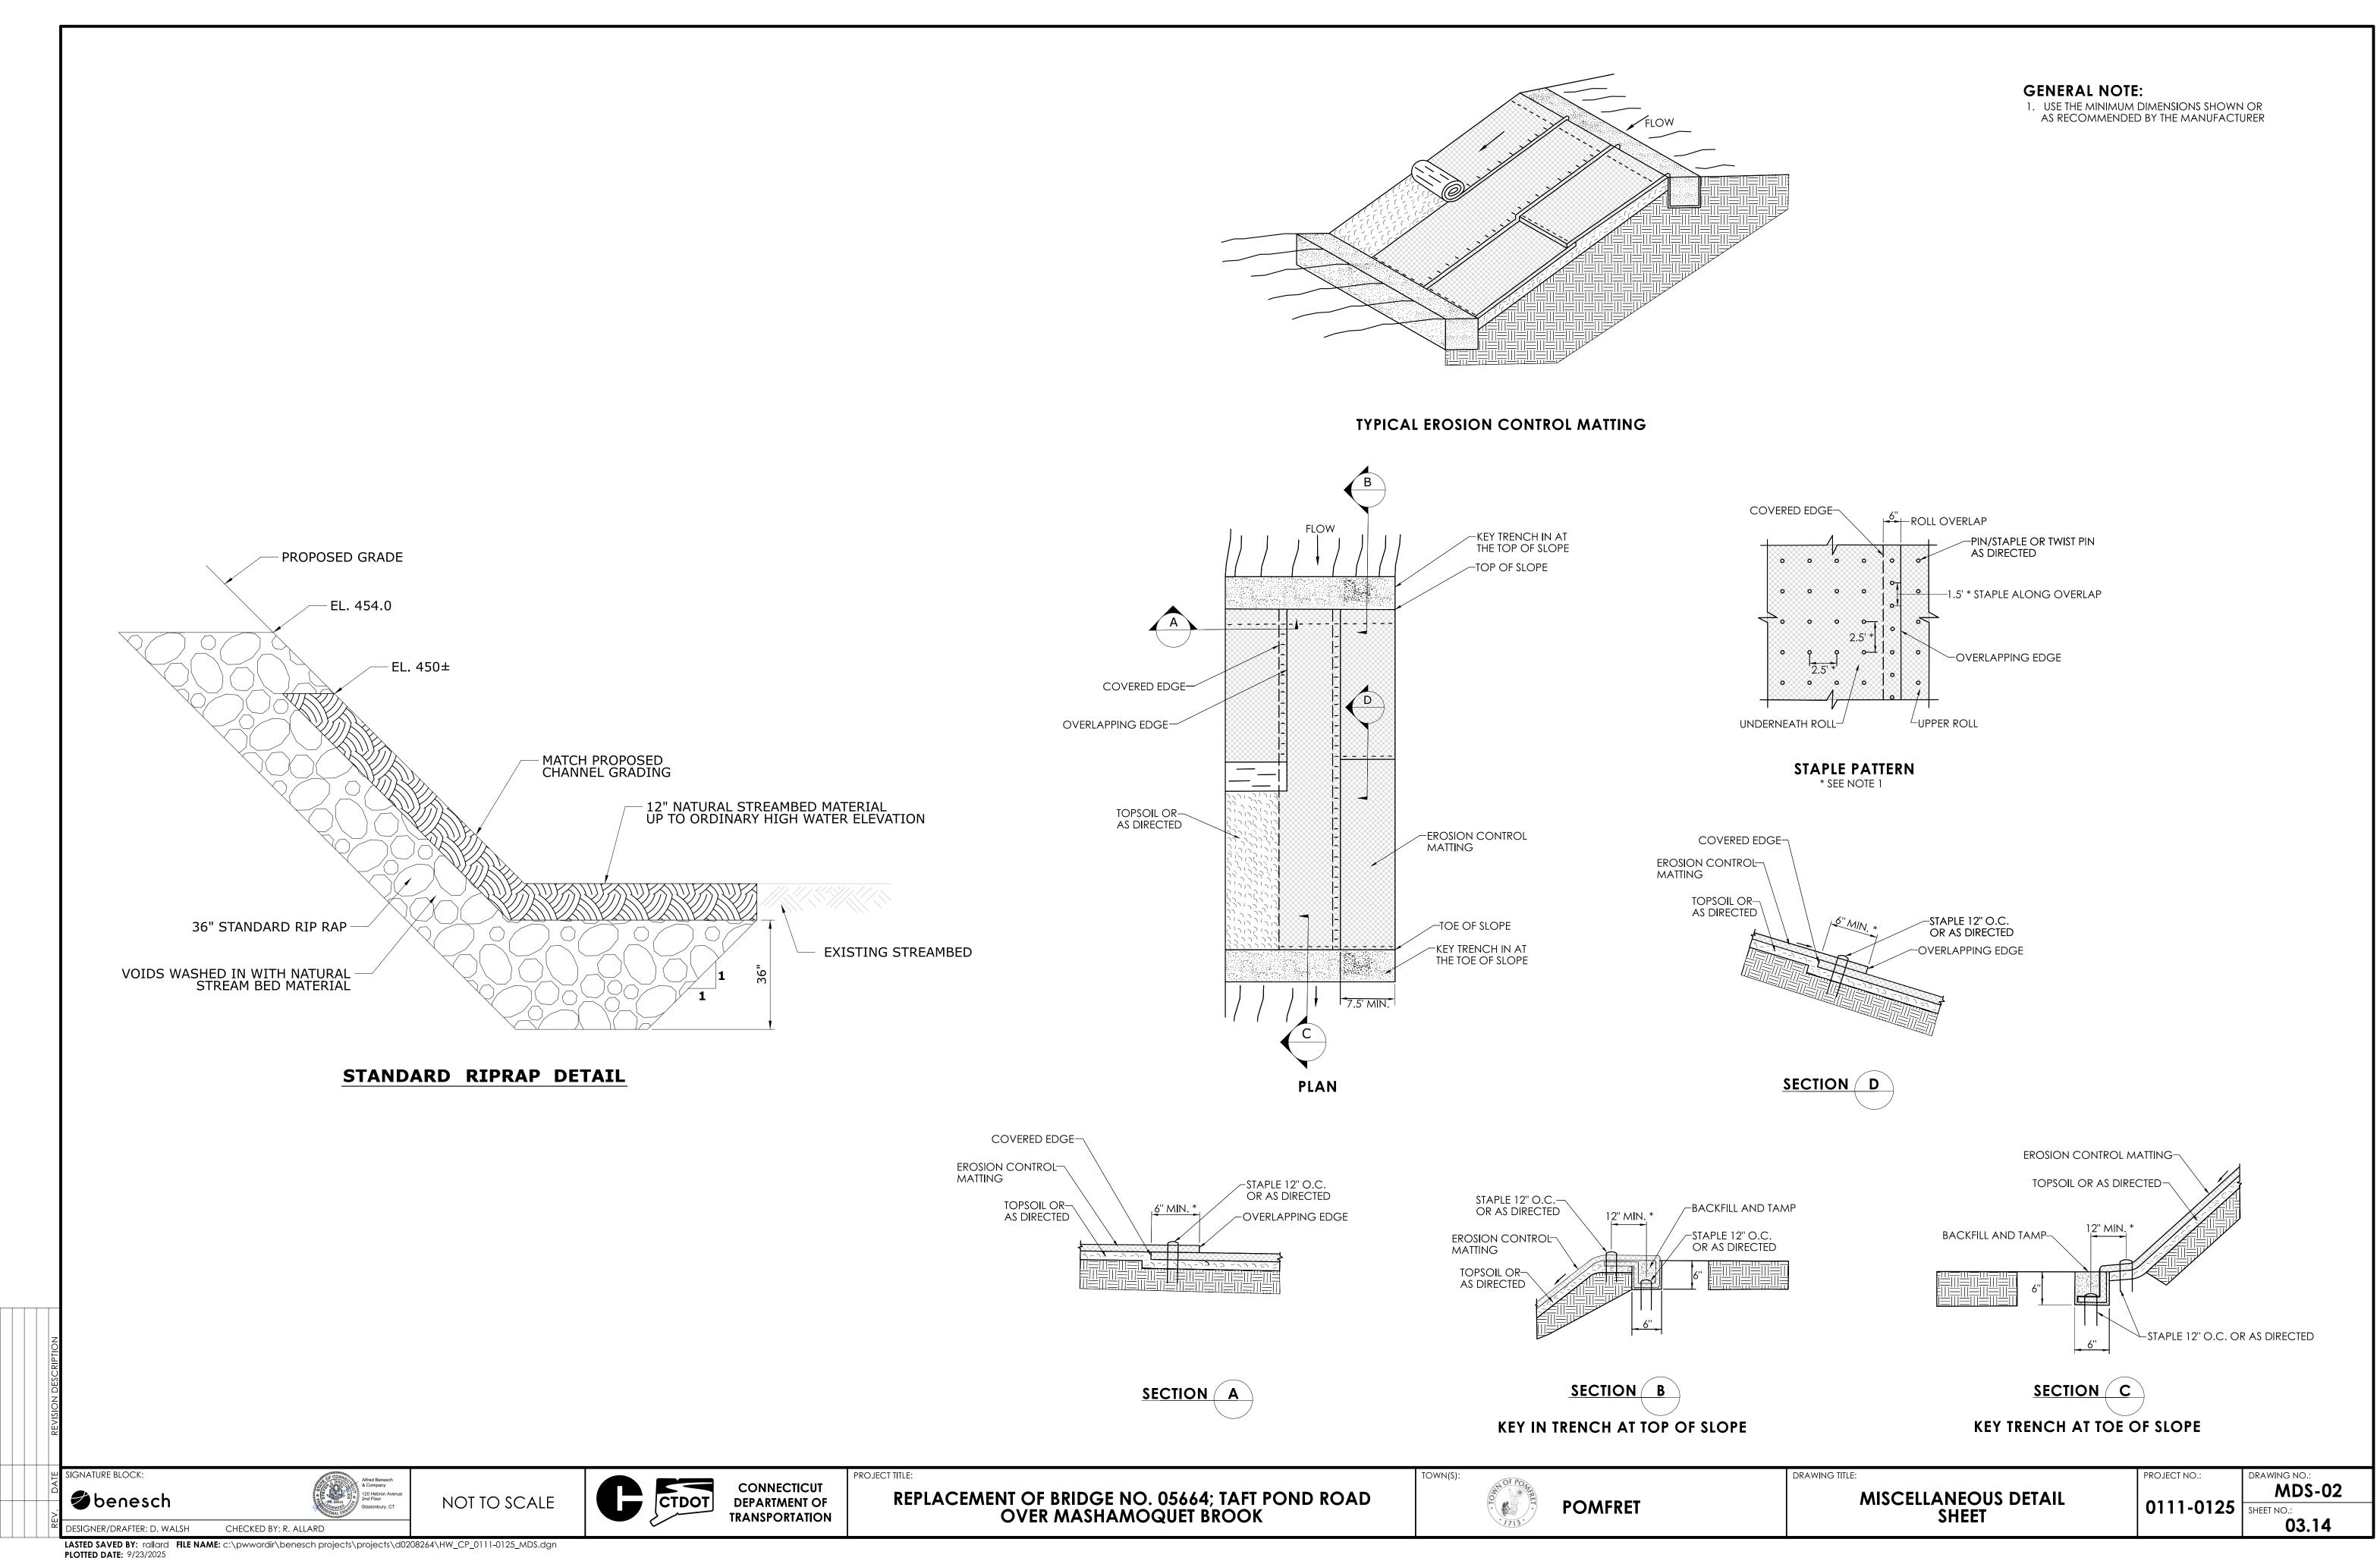

NOTES PERMIT PLANT LIST 1. EXISTING STONE STRUCTURE IS ASSUMED TO BE REMNANTS OF A HISTORICAL CROSSING REQUIRING CULTURAL RESOURCE PROTECTION. BOTANICAL NAME COMMON NAME QTY. SPACING WETLAND INDICATOR CONTRACTOR ACTIVITIES SHALL NOT DISTURB THESE CULTURAL RESOURCES. WORK IS NOT PERMITTED WEST OF THE 30-FT OFFSET LINE. ILEX GLABRA INKBERRY 36-48" HT 40 FIELD LOCATE FACU 2. PLANTINGS ON THIS SHEET ARE FOR ENVIRONMENTAL PERMITTING. ANY SUBSTITUTIONS TO THE PERMIT PLANTINGS SHALL BE CORNUS SERICEA **RED OSIER DOGWOOD** 18-24" HT 25 FIELD LOCATE FACW COORDINATED WITH THE TOWN OR ITS DESIGNATED REPRESENTATIVE. VACCINIUM CORYMBOSUM | NORTHERN HIGHBUSH BLUEBERRY 18-24" HT 10 FIELD LOCATE FACU RUDBECKIA HIRTA **BLACK-EYED SUSAN** 220 FIELD LOCATE FACU 1 QT. 3. PROPOSED PLANTINGS TO BE FIELD LOCATED BY THE TOWN OR THEIR DESIGNATED REPRESENTATIVE. SAMBUCUS CANADENSIS ELDERBERRY 24-36" HT 30 FIELD LOCATE FACU 4. WOOD CHIP MULCH SHALL NOT BE PLACED IN THE WETLAND AREA. FIELD LOCATE IN ASCLEPIAS INCARNATA SWAMP MILKWEED 1 GAL. 12 OBL GROUPS OF 3 5. DISTURBED AREAS ABOVE THE WETLAND LIMIT WITH SLOPES 3:1 OR GREATER SHALL BE SEEDED WITH CONSERVATION SEEDING FOR SLOPES. DISTURBED AREAS ABOVE THE WETLAND LIMIT WITH SLOPES LESS THAN 3:1 SHALL BE SEEDED WITH TURF ESTABLISHMENT - LAWN. TURF ESTABLISHMENT - LAWN 800 SY ALL AREAS SHALL BE RESTORED. CONSERVATION SEEDING FOR SLOPES 170 SY 6. ALL PLANT MATERIAL SHALL BE NURSERY GRADE STRAIGHT SPECIES, CONFORMING TO SECTION 3 OF THE AMERICAN STANDARDS FOR NURSERY STOCK. TOWN OR ITS DESIGNATED REPRESENTATIVE WILL REVIEW AND APPROVE PROPOSED PLANTINGS. SEE NOTE 4 7. NO PLANTINGS SHALL BE PLACED IN MOW AREA. 8. AREA TO BE TREATED FOR INVASIVES SHALL BE PROPERLY PREPARED FOR FINAL PLANTING, SEEDING, AND RESTORATION. 9. HIGH VISIBILITY FENCE SHALL BE PAID UNDER ITEM NO. 0913850A - "HIGH VISIBILITY SAFETY FENCE", SEE SPECIAL PROVISIONS. END GRAVEL PULL-OFF — BEGIN PROJECT NO. 0111-0125 STA. 7+24, 12' L STA. 2+25 GRAVEL PULL-OFF-N=879806.421' (SEE NOTE 1) E=1202006.531' BEGIN GRAVEL PULL-OFF -BEGIN FULL DEPTH PAVEMENT RECONSTRUCTION STA. 6+64, 12' L CUT BITUMINOUS CONCRETE PAVEMENT → OBL ZONE MATCH EXISTING PAVEMENT - HIGH VISIBILITY FENCE TO EXISTING STONE STRUCTURE — PROTECT CULTURAL SCHEMATIC PLANTING (HISTORIC ABUTMENT AND RESOURCES (TYP.) RETAINING WALLS) (SEE NOTE 1) END GRAVEL PULL-OFF -(SEE NOTE 9) **END PROJECT NO. 0111-0125** STA. 4+16, 12' L STATE/FEDERAL ----TAFT POND ROAD WETLANDS STA. 7+50 THE NATURE CONSERVANCY GRAVEL PULL-OFF N=880501.079' OF CONNECTICUT, INC. N/F E=1201439.308' ALFRED RICHARD BEGIN GRAVEL PULL-OFF END FULL DEPTH PAVEMENT RECONSTRUCTION ET AL STA. 3+56, 12' L CUT BITUMINOUS CONCRETE PAVEMENT MATCH EXISTING PAVEMENT 30-FT OFFSET TO PROTECT -REBAR CULTURAL RESOURCES CHARLES BOTTIE W/CAP SEEDING (TO RESTORE ALL —ET AL DISTURBED AREAS UNLESS (SEE NOTE 1) **ARTHUR OWENS** APPROX. STREET LINE OTHERWISE DEFINED) WOODS #3469 TAFT POND ROAD (BIT. PAVEMENT W/OIL -STONE CO WALL BLOOM TAFT POND ROAD WOODS PLANTINGS AND SHRUBS (ALL AREAS-PIPELINE EASEMENT I.F.O. SHOWN IN GRAY, SEE NOTE 7) (TYP.) ALGONQUIN GAS TRANSMISSION COMPANY SEDIMENTATION CONTROL SYSTEM (TYP. 1'NATURAL RIGHT-OF-WAY LINE STREAMBED MATERIAL MASHAMOQUET FARM II LLC (TYP.) UP TO EL. 450 (TYP.) B TAFT POND ROAD PLACEMENT OF TOE -BITUMINOUS CONCRETE DRIVEWAY BOULDERS AS DIRECTED - B GRAVEL DRIVEWAY STANDARD RIPRAP (TYP.) -**NOTES** NATURAL STREAMBED MATERIAL ON STANDARD RIPRAP (TYP.) TREE TO BE REMOVED 1. PLACEMENT OF TOE BOULDERS SHALL BE EXISTING ISLAND + DIRECTED IN THE FIELD BY OEP, OR THEIR COMPOSEDOF -EDGE OF STREAMBANK AUTHORIZED DELEGATE. SEE SPECIAL SEDIMENT NIGHTINGALE L+T LLC PROVISIONS FOR ITEM NO. 0703040A PROPOSED SINGLE-SPAN - "PLACEMENT OF TOE BOULDERS". PRESTRESSED DECK UNITS SUPERSTRUCTURE (36'-0" CLEAR) **LEGEND GENERAL SITE PLAN** -SELECT, ORIENT, AND PLACE BOULDERS IN A ROUNDED TOF BOULDERS PROPOSED ABUTMENT FACE WETLAND LIMIT (STATE AND IANNER TO MINIMIZE GAP WIDTH ALIGNMENT OF BOULDER EDGES SCALE: 1"=40' TO BE VARIABLE AND OFF-SET FEDERAL) BY MIN. DISTANCE OF 0.5 TO 1.0 FT. G STREAMBANK ROUNDED TOE BOULDER 2'-6" MIN. DIAMETER EXISTING 100-YEAR FLOOD ROUNDED TOE BOULDER 2'-6" MIN. DIAMETER DIMENSION PER PLAN (CALCULATED) -FINISHED STREAMBED ORDINARY HIGH WATER -EXISTING STREAMBED OR ALL DISTURBED AREAS TO BE STABILIZED AS SPECIFIED (TO BE SPECIFIED PER PROJECT DESIGN) SEDIMENTATION CONTROL SYSTEM BOULDER EMBEDDED APPROXIMATELY 12" NATURAL STREAMBED MATERIAL 6 TO 12 INCHES 30-FT OFFSET TO PROTECT —BOULDER EMBEDDED APPROXIMATELY 6 TO 12 INCHES CULTURAL RESOURCES TREE TO BE REMOVED EXISTING STREAMBED MATERIAL -12" NATURAL STREAMBED MATERIAL 5' MIN TOE BOULDERS AT STRUCTURE TOE BOULDERS PROFILE VIEW **TOE BOULDERS PLAN VIEW**

REPLACEMENT OF BRIDGE NO. 05664; TAFT POND ROAD

OVER MASHAMOQUET BROOK

DRAWING TITLE:

PLANTING PLAN

POMFRET

PROJECT NO.:

0111-0125 SHEET NO.

PMT-02

03.15

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DEPARTMENT OF

TRANSPORTATION

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SIGNATURE BLOCK

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