RI CONTRACT NO. 2025-CB-057

TCB26005787

Bridge Group 26C – Woonsocket Blackstone River West ADDENDUM NO. 1 October 22, 2025

Prospective bidders and all concerned are hereby notified of the following changes in the Plans, Specifications, Proposal, and Distribution of Quantities for this contract. These changes shall be incorporated in the Plans, Specifications, Proposal, and Distribution of Quantities, and shall become an integral part of the Contract Documents.

A. CS Pages

1. Page CS-1

Remove Page CS-1 in its entirety and replace it with revised Page CS-1 (R-1) attached to this Addendum No. 1. Reference to metalizing has been removed from the BRIEF SCOPE OF WORK.

B. JS Pages

1. Page JS-19

Remove Page JS-19 in its entirety and replace it with revised Page JS-19 (R-1) attached to this Addendum No. 1. The Base Price of Diesel Fuel has been revised.

C. Plans

1. Volume 2 – Sheet No. 4

Remove Volume 2 – Sheet No. 4 in its entirety and replace it with revised Volume 2 – Sheet No. 4 (R-1) attached to this Addendum No. 1.

2. Volume 2 – Sheet No. 7

Remove Volume 2 – Sheet No. 7 in its entirety and replace it with revised Volume 2 – Sheet No. 7 (R-1) attached to this Addendum No. 1.

3. Volume 2 – Sheet No. 9

Remove Volume 2 – Sheet No. 9 in its entirety and replace it with revised Volume 2 – Sheet No. 9 (R-1) attached to this Addendum No. 1.

4. Volume 2 – Sheet No. 11

Remove Volume 2 – Sheet No. 11 in its entirety and replace it with revised Volume 2 – Sheet No. 11 (R-1) attached to this Addendum No. 1.

5. Volume 2 – Sheet No. 16

Remove Volume 2 – Sheet No. 16 in its entirety and replace it with revised Volume 2 – Sheet No. 16 (R-1) attached to this Addendum No. 2.

RI CONTRACT NO. 2025-CB-057

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Bridge Group 26C – Woonsocket Blackstone River West ADDENDUM NO. 1 October 22, 2025

6. Volume 2 – Sheet No. 22

Remove Volume 2 – Sheet No. 22 in its entirety and replace it with revised Volume 2 – Sheet No. 22 (R-1) attached to this Addendum No. 1.

7. Volume 2 – Sheet No. 30

Remove Volume 2 – Sheet No. 30 in its entirety and replace it with revised Volume 2 – Sheet No. 30 (R-1) attached to this Addendum No. 2.

8. Volume 2 – Sheet No. 38

Remove Volume 2 – Sheet No. 38 in its entirety and replace it with revised Volume 2 – Sheet No. 38 (R-1) attached to this Addendum No. 1.

9. Volume 2 – Sheet No. 39

Remove Volume 2 – Sheet No. 39 in its entirety and replace it with revised Volume 2 – Sheet No. 39 (R-1) attached to this Addendum No. 1.

10. Volume 3 – Sheet No. 4

Remove Volume 2 – Sheet No. 4 in its entirety and replace it with revised Volume 2 – Sheet No. 4 (R-1) attached to this Addendum No. 1.

11. Volume 3 – Sheet No. 7

Remove Volume 2 – Sheet No. 7 in its entirety and replace it with revised Volume 2 – Sheet No. 7 (R-1) attached to this Addendum No. 1.

12. Volume 3 – Sheet No. 9

Remove Volume 2 – Sheet No. 9 in its entirety and replace it with revised Volume 2 – Sheet No. 9 (R-1) attached to this Addendum No. 1.

13. Volume 3 – Sheet No. 11

Remove Volume 2 – Sheet No. 11 in its entirety and replace it with revised Volume 2 – Sheet No. 11 (R-1) attached to this Addendum No. 1.

14. Volume 3 – Sheet No. 16

Remove Volume 2 – Sheet No. 16 in its entirety and replace it with revised Volume 2 – Sheet No. 16 (R-1) attached to this Addendum No. 2.

15. Volume 3 – Sheet No. 22

Remove Volume 2 – Sheet No. 22 in its entirety and replace it with revised Volume 2 – Sheet No. 22 (R-1) attached to this Addendum No. 1.

RI CONTRACT NO. 2025-CB-057

TCB26005787

Bridge Group 26C – Woonsocket Blackstone River West ADDENDUM NO. 1 October 22, 2025

16. Volume 3 – Sheet No. 30

Remove Volume 2 – Sheet No. 30 in its entirety and replace it with revised Volume 2 – Sheet No. 30 (R-1) attached to this Addendum No. 2.

17. Volume 3 – Sheet No. 38

Remove Volume 2 – Sheet No. 38 in its entirety and replace it with revised Volume 2 – Sheet No. 38 (R-1) attached to this Addendum No. 1.

18. Volume 3 – Sheet No. 39

Remove Volume 3 – Sheet No. 39 in its entirety and replace it with revised Volume 2 – Sheet No. 39 (R-1) attached to this Addendum No. 1.

D. DOQ

1. Table of Contents

Remove Table of Contents in its entirety and replace them with revised Table of Contents (R-1) attached to this Addendum No. 1. Revisions have been marked in red.

2. Sheet 43

Remove Sheet 43 in its entirety and replace it with revised Sheet 43 (R-1) attached to this Addendum No. 1. The quantity for Item Code 803.0500 has been revised.

3. Sheet 55

Remove Sheet 55 in its entirety and replace it with revised Sheet 55 (R-1) attached to this Addendum No. 2. The quantity for Item Code 824.2000 has been revised.

4. Sheet 61

Remove Sheet 61 in its entirety and replace it with revised Sheet 61 (R-1) attached to this Addendum No. 1. Item Code 827.8038 has been removed from the project.

5. Sheets 94

Add new Sheet 94 attached to this Addendum No. 1. Item Code 833.0400 has been added to the project.

RI CONTRACT NO. 2025-CB-057

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Bridge Group 26C – Woonsocket Blackstone River West ADDENDUM NO. 1 October 22, 2025

6. Sheets 95

Add new Sheet 95 attached to this Addendum No. 2. Item Code 202.0800 has been added to the project.

E. OSP File

1. Item Specifications and Quantities

Item and quantity changes include the following:

Item 21 – Item deleted. Note item remains in file with a quantity of zero (0).

Item 43 – Quantity change.

Item 55 – Quantity change.

Item 61 – Item deleted. Note item remains in file with a quantity of zero (0).

Item 94 – Item Code 401.0510 has been added.

Item 95 – Item Code 833.0400 has been added.

Item 96 – Item Code 202.0800 has been added.

F. Federal Wage Rates

1. Federal Wage Rate Determination

Remove Federal Wage Rates - 09--2025 Pages 1 through 15 in their entirety and replace them with revised Federal Wage Rates - 10-03-2025 Pages 1(R-1) through 15(R-1), attached to this Addendum No. 1. Federal Wage Rates have been updated.

G. Other

1. Questions and Answers

Questions and answers that have been submitted are attached to this Addendum No. 1.

2. Formal Solicitation Header Information

Reference to metalizing has been removed from the Description.

RI CONTRACT NO. 2025-CB-057

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Bridge Group 26C – Woonsocket Blackstone River West ADDENDUM NO. 1 October 22, 2025

3. Requirements – Disadvantaged Business Enterprise or Minority/Woman Business Enterprise Goal

The DBE requirement has been removed from the project.

1. BRIEF SCOPE OF WORK

Rhode Island Contract No. 2025-CB-057, Federal Aid Project No. BHO-026C (001) is for the Bridge Group 26C – Woonsocket Blackstone River West Project which includes the rehabilitation of the Singleton Road Bridge No. 095501 and the River Road Bridge No. 095601 in Woonsocket, Rhode Island.

The work to be performed under this Contract shall consist of, but not be limited to: complete removal and reconstruction of the concrete bridge decks including deck-over-backwall extension details; steel repair and strengthening details; cleaning and painting all steel members; expansion joint replacement; channel band restoration at the abutments; installation of new MASH compliant barriers; reconstructing approach roadway at each end of the bridges including full depth pavement structure and new steel beam guardrail with end treatments; maintenance and protection of traffic; pavement markings; erosion controls; and other incidentals, complete and accepted.

2. LIST OF CONTRACT DOCUMENTS

Contract Documents

Contract Specifications

RI Department of Administration Division of Purchases Procurement Regulations February 2025 Edition of the RI Standard Specifications for Road & Bridge Construction Required Contract Provisions/Federal-Aid Construction Contracts

Rhode Island Standard Details

Bridge Standard Details

General Provisions

General Provisions – Contract Specific

Specifications – Job Specific

Distribution of Quantities

Federal Wage Rates

Plans – There are three (3) volumes of Plans that comprises the Contract Drawings for this Contract. The volumes of plans are as follows:

VOLUME 1 - HIGHWAY PLANS

VOLUME 2 - SINGLETON STREET BRIDGE NO. 095501

VOLUME 3 - RIVER STREET BRIDGE NO. 095601

Additional Information Documents

The following documents are included but shall not be considered part of the Contract Documents. These documents are included for informational purposes only. The Contractor

(R-1) Date: 9/24/25

RICN: 2025-CB-057

Page 1 of 1

CODE 938.1000 PRICE ADJUSTMENTS

DESCRIPTION:

- **a.** Liquid Asphalt Cement.* The Base Price of Liquid Asphalt Cement as required to implement Subsection 938.03.1 of the Standard Specifications is \$625.00 per ton.
- * In the case of modified asphalt binder, this price adjustment provision shall only apply to the neat liquid asphalt component. This provision shall not apply to the modifier component, manufacture, storage, transportation or other associated costs.
- **b. Diesel Fuel.** The Base Price of Diesel Fuel as required to implement **Subsection 938.03.2** of the Standard Specifications is \$ 2.3732 per gallon.

Current price adjustments can be found at the following web address:

http://www.dot.ri.gov/business/contractorsandconsultants.php

FISCAL SHEET TOTAL YEAR NO. SHEETS RI CONTRACT NO. 2025-CB-057 2025 4

STRUCTURAL STEEL NOTES

- 1. FRAMING DIMENSIONS ARE GIVEN ALONG CENTERLINES OF GIRDERS AND ALONG CENTERLINES OF BEARINGS ON ABUTMENTS AND PIERS. THE FABRICATOR IS RESPONSIBLE FOR INCORPORATING THE CAMBER, CROSS SLOPE, AND OTHER EFFECTS THAT MAY IMPACT THE OVERALL GIRDER LENGTHS, DIMENSIONS AND/OR THE DETAILING.
- 2. INSTABILITY DURING CONSTRUCTION OF THE GIRDERS (INCLUDING DURING LIFTING. TRANSPORTING AND ERECTION) MAY PRESENT A HAZARDOUS SITUATION. THE CONTRACTOR SHALL TAKE ALL NECESSARY PRECAUTIONS AND MEASURES TO ENSURE STABILITY AND THEREBY SAFETY DURING THE STEEL ERECTION AND CONSTRUCTION.
- THE SHOPS FABRICATING THE STRUCTURAL STEEL SHALL, AT A MINIMUM, BE CERTIFIED FOR "SIMPLE STEEL BRIDGE STRUCTURES (SBR)".

THE SHOPS SHALL ALSO BE CERTIFIED UNDER THE AISC "SOPHISTICATED PAINT ENDORSEMENT (SPE)" QUALITY PROGRAM OR THE SSPC-QP3 PAINT CERTIFICATION PROGRAM.

THE FABRICATOR MUST SUBMIT PROOF OF CURRENT CERTIFICATION AS SPECIFIED.

- 4. THE STEEL ERECTOR/CONTRACTOR FOR THIS PROJECT SHALL BE CERTIFIED FOR "ADVANCED CERTIFIED STEEL ERECTOR (ASCE)" IN ACCORDANCE WITH THE AISC QUALITY CERTIFICATION PROGRAM. THE ERECTOR/CONTRACTOR OF THE STRUCTURAL STEEL SHALL BE REQUIRED TO SUBMIT PROOF OF CURRENT CERTIFICATION AS SPECIFIED.
- 5. THIS BRIDGE CONTAINS FRACTURAL CRITICAL MEMBERS (FCM). THESE MEMBERS HAVE BEEN DESIGNATED ON THE STEEL FRAMING AND/OR THE STEEL DETAIL SHEETS.
- 6. THIS BRIDGE CONTAINS FATIGUE SENSITIVE DETAILS (FSD). THESE DETAILS HAVE BEEN DESIGNATED ON THE STEEL FRAMING AND/OR THE STEEL DETAIL SHEETS
- 7. SHOP DRAWINGS FOR ALL FABRICATED STEEL INCLUDING BEARINGS, EXPANSION JOINTS, RAILINGS AND FALSEWORK SHALL BE SUBMITTED TO THE ENGINEER IN SUFFICIENT TIME TO PERMIT CAREFUL CHECKING PRIOR TO FABRICATION.
- 8. INSPECTION OF WELDS INCLUDING RADIOGRAPHIC TESTING (RT) AND MAGNETIC PARTICLE TESTING (MT) SHALL BE IN ACCORDANCE WITH THE RI STANDARD SPECIFICATIONS AND THE AASHTO/AWS BRIDGE WELDING CODE, EXCEPT THAT THE REMAINING PERCENTAGE OF ALL GROOVE WELDS NOT RT TESTED SHALL BE MT OR DYE-PENETRANT TESTED.
- 9. STRUCTURAL STEEL SHAPES AND PLATES SHALL CONFORM TO THE LATEST PROVISIONS OF AASHTO DESIGNATION M 270 GRADE 36, GRADE 50, AND 50W AS DESIGNATED ON THE PLANS.
- 10. ALL AASHTO M 270 STRUCTURAL STEEL USED IN GIRDERS (INCLUDING CONNECTION PLATES AND STIFFENERS), SHALL MEET THE ZONE 2 CHARPY V-NOTCH FRACTURE TOUGHNESS TEST REQUIREMENTS AS SPECIFIED IN TABLE 6.6.2-2 OF THE AASHTO LRFD BRIDGE DESIGN SPECIFICATIONS FOR "NONFRACTURE-CRITICAL" AND "FRACTURE-CRITICAL" COMPONENTS. THE ZONE 2 FRACTURE TOUGHNESS REQUIREMENTS ARE AS FOLLOWS:

NONFRACTURE-CRITICAL

15 FT-LBS @ 40°F (UP TO 4 INCHES THICK) 15 FT-LBS @ 40°F (UP TO AND INCLUDING 2 INCHES THICK) GRADE 50 OR 50W GRADE 50 OR 50W 20 FT-LBS @ 40°F (FROM 2 INCH THICK UP TO AND INCLUDING 4 INCHES THICK)

FRACTURAL-CRITICAL

GRADE 36 25 FT-LBS @ 40°F (UP TO 4 INCHES THICK) **GRADE 50 OR 50W** GRADE 50 OR 50W THICK)

25 FT-LBS @ 40°F (UP TO AND INCLUDING 2 INCHES THICK) 30 FT-LBS @ 40°F (FROM 2 INCH THICK UP TO AND INCLUDING 4 INCHES

SAMPLING AND TESTING PROCEDURES SHALL BE IN ACCORDANCE WITH AASHTO T 243. THE FREQUENCY OF TESTING SHALL BE IN ACCORDANCE WITH THE AASHTO LRFD BRIDGE DESIGN SPECIFICATIONS.

THE CHARPY V-NOTCH FRACTURE TOUGHNESS TEST REQUIREMENT IS NOT MANDATORY FOR THE FOLLOWING STEEL COMPONENTS:

- BEARINGS, MASONRY PLATES AND SOLE PLATES
- EXPANSION JOINTS AND MODULAR BRIDGE JOINT SYSTEMS
- DRAINAGE MATERIAL
- RAILINGS
- FOUNDATION H-PILES AND PIPE PILES
- SUPPORT OF EXCAVATION COMPONENTS
- 11. WELDING SHALL BE IN ACCORDANCE WITH THE LATEST BRIDGE WELDING CODE AASHTO/AWS D1.5 (INCLUDING ALL INTERIMS TO DATE) AND APPLICABLE SUPPLEMENTAL AWS PUBLICATIONS.
- 12. ALL HIGH STRENGTH BOLTS SHALL CONFORM TO ASTM F3125, GRADE 325, AND THEY SHALL BE INSTALLED IN ACCORDANCE WITH SECTION 824 OF THE RI STANDARD SPECIFICATIONS.
- 13. WASHERS MEETING ASTM F436 ARE TO BE USED OVER ALL HOLES THAT ARE MORE THAN 1/16" IN DIAMETER GREATER THAN THE BOLT DIAMETER AND UNDER ALL PARTS TURNED DURING ASSEMBLY.

- 14. WELDING ELECTRODES SHALL HAVE THE SAME CORROSION RESISTANCE AS THE BASE METAL AND SHALL BE FREE OF MOISTURE AT THE TIME OF USE.
- 15. STRUCTURAL STEEL SHALL BE PREPARED AND PAINTED IN ACCORDANCE WITH THE RI STANDARD SPECIFICATIONS. SEE NOTES BELOW FOR COLOR.
- 16. UNLESS OTHERWISE SPECIFIED, THE UPPER SURFACES OF GIRDER TOP FLANGES SHALL BE FREE OF PAINT, OIL OR OTHER IMPURITIES THAT WOULD IN ANY WAY REDUCE THE BOND OF CONCRETE TO STEEL.
- 17. PRIOR TO FABRICATION, ALL MATERIALS SHALL FIRST BE SOLVENT CLEANED TO SSPC-SP1 TO REMOVE ALL OIL, GREASE AND DIRT; FOLLOWED BY BLAST-CLEANING TO SSPC-SP10 TO REMOVE ALL MILL SCALE, RUST, AND OTHER DELETERIOUS MATERIALS FROM THE SURFACES OF THE STEEL TO BE FABRICATED.
- 18. PRIOR TO SHOP COATING AS SPECIFIED IN SECTION 825 OF THE RI STANDARD SPECIFICATIONS, ALL CORNERS AND EDGES OF STEEL WHICH HAVE BEEN FLAME CUT OR OTHERWISE HARDENED SHALL BE SOFTENED BY GRINDING OR BLAST-CLEANING TO PROVIDE A SURFACE SUITABLE FOR APPLICATION OF THE SPECIFIED PAINT SYSTEM.

UPON COMPLETION OF ALL FABRICATION AND PRIOR TO THE APPLICATION OF THE SHOP PRIMER COAT THE STRUCTURAL STEEL SHALL BE RESTORED TO AN SSPC-SP10 CONDITION.

- 19. WELDING OF ATTACHMENTS TO GIRDER FLANGES OR WEBS FOR CONSTRUCTION PURPOSES IS NOT PERMITTED EXCEPT WHEN APPROVED BY THE ENGINEER.
- 20. THE ENDS OF ALL GIRDERS SHALL BE VERTICAL AFTER ALL DEAD LOADS HAVE BEEN PLACED.
- 21. INTERMEDIATE STIFFENERS SHALL BE PLACED ON THE INTERIOR SIDE OF THE FASCIA PLATE GIRDER WEBS AND ON BOTH SIDES OF ALL INTERIOR PLATE GIRDER WEBS.
- 22. ALL SHOP CONNECTIONS AND SPLICES SHALL BE WELDED. WELDING PROCEDURES AND TECHNIQUES TO BE USED IN FABRICATION AND ERECTION OF THE GIRDERS SHALL BE AS SHOWN ON THE SHOP DRAWINGS AND SHALL INCORPORATE THE FOLLOWING:
 - BOTH FLANGES AND THE WEB SHALL BE COMPLETELY FABRICATED FOR THEIR ENTIRE LENGTHS BEFORE THE WELDING OF THE FLANGES TO THE WEB IS PERFORMED.
 - ALL WEB AND FLANGE SPLICES OTHER THAN THOSE SHOWN ON THE PLANS MUST BE APPROVED BY THE ENGINEER. ALTERNATE OR ADDITIONAL SPLICES ARE TO BE LOCATED AND DESIGNED BY THE FABRICATOR AND SHOWN ON THE SHOP DRAWINGS. THESE SPLICES ARE TO FULLY DEVELOP THE STRENGTH OF THE WEB AND FLANGE PLATES. WEB SPLICES, IF USED, SHALL BE LOCATED 2'-0" MINIMUM FROM ANY STIFFENER.
 - NO MORE THAN TWO SHOP WEB SPLICES WILL BE PERMITTED BETWEEN FIELD SPLICES. SPLICING OF GIRDERS BY FIELD WELDING WILL NOT BE PERMITTED.
- 28. ALL FILLET WELDS SHALL BE IN ACCORDANCE WITH THE BRIDGE WELDING CODE AASHTO/AWS D1.5
- 29. ALL SHEAR STUD CONNECTORS SHALL BE WELDED BY THE AUTOMATIC TIMED ELECTRIC ARC PROCESS. SHEAR STUDS SHALL BE INSPECTED AND TESTED IN ACCORDANCE WITH SECTION 824 OF THE RI STANDARD SPECIFICATIONS.
- 30. WHEN STEEL DIE STAMPS ARE USED TO IDENTIFY PIECES AND MEMBERS. FABRICATORS SHALL UTILIZE LOW STRESS STAMPS.
- 31. FOR SIZE AND LOCATION OF ANCHOR BOLTS, SEE PIER, ABUTMENT, AND BEARING DRAWINGS.
- 32. IT SHALL BE THE CONTRACTOR'S RESPONSIBILITY TO ENSURE THAT THE EXPANSION JOINT SYSTEM PROVIDED WILL BE COMPATIBLE WITH BOTH THE END OF DECK OR PIER HAUNCHES AND/OR THE STRUCTURAL STEEL FRAMING CONFIGURATION. THAT IS, THE EXPANSION JOINT SYSTEM AND ALL ITS INHERENT COMPONENTS AND ATTACHMENT DEVICES SHALL BE SIZED OR ARRANGED TO BE COMPATIBLE WITH THE GIRDER AND DIAPHRAGM FLANGES, CONNECTION PLATES, BOLTS, SHEAR STUDS AND REINFORCING STEEL THAT SHARE THE END HAUNCH REGION.

PAINT NOTES

- BRIDGE STEEL (TRUSS ELEMENTS, SUPERSTRUCTURE STEEL) -FEDERAL COLOR 24272 (GREEN, SEMI-GLOSS). THIS INCLUDES ALL ELEMENTS AFTER REPAIRS.
- 2 4-BAR TRAFFIC RAIL FEDERAL COLOR 17038 (BLACK, GLOSS)

METALIZING/GALVANIZING NOTES

EXISTING BRIDGE STEEL (TRUSS ELEMENTS, SUPERSTRUCTURE STEEL) SHALL BE FIELD METALIZED.

PROPOSED REPAIR PLATES, STRUCTURAL STEEL SHALL BE SHOP METALIZED.

3. TRAFFIC RAILING SHALL BE GALVANIZED.





RHODE ISLAND DEPARTMENT OF TRANSPORTATION

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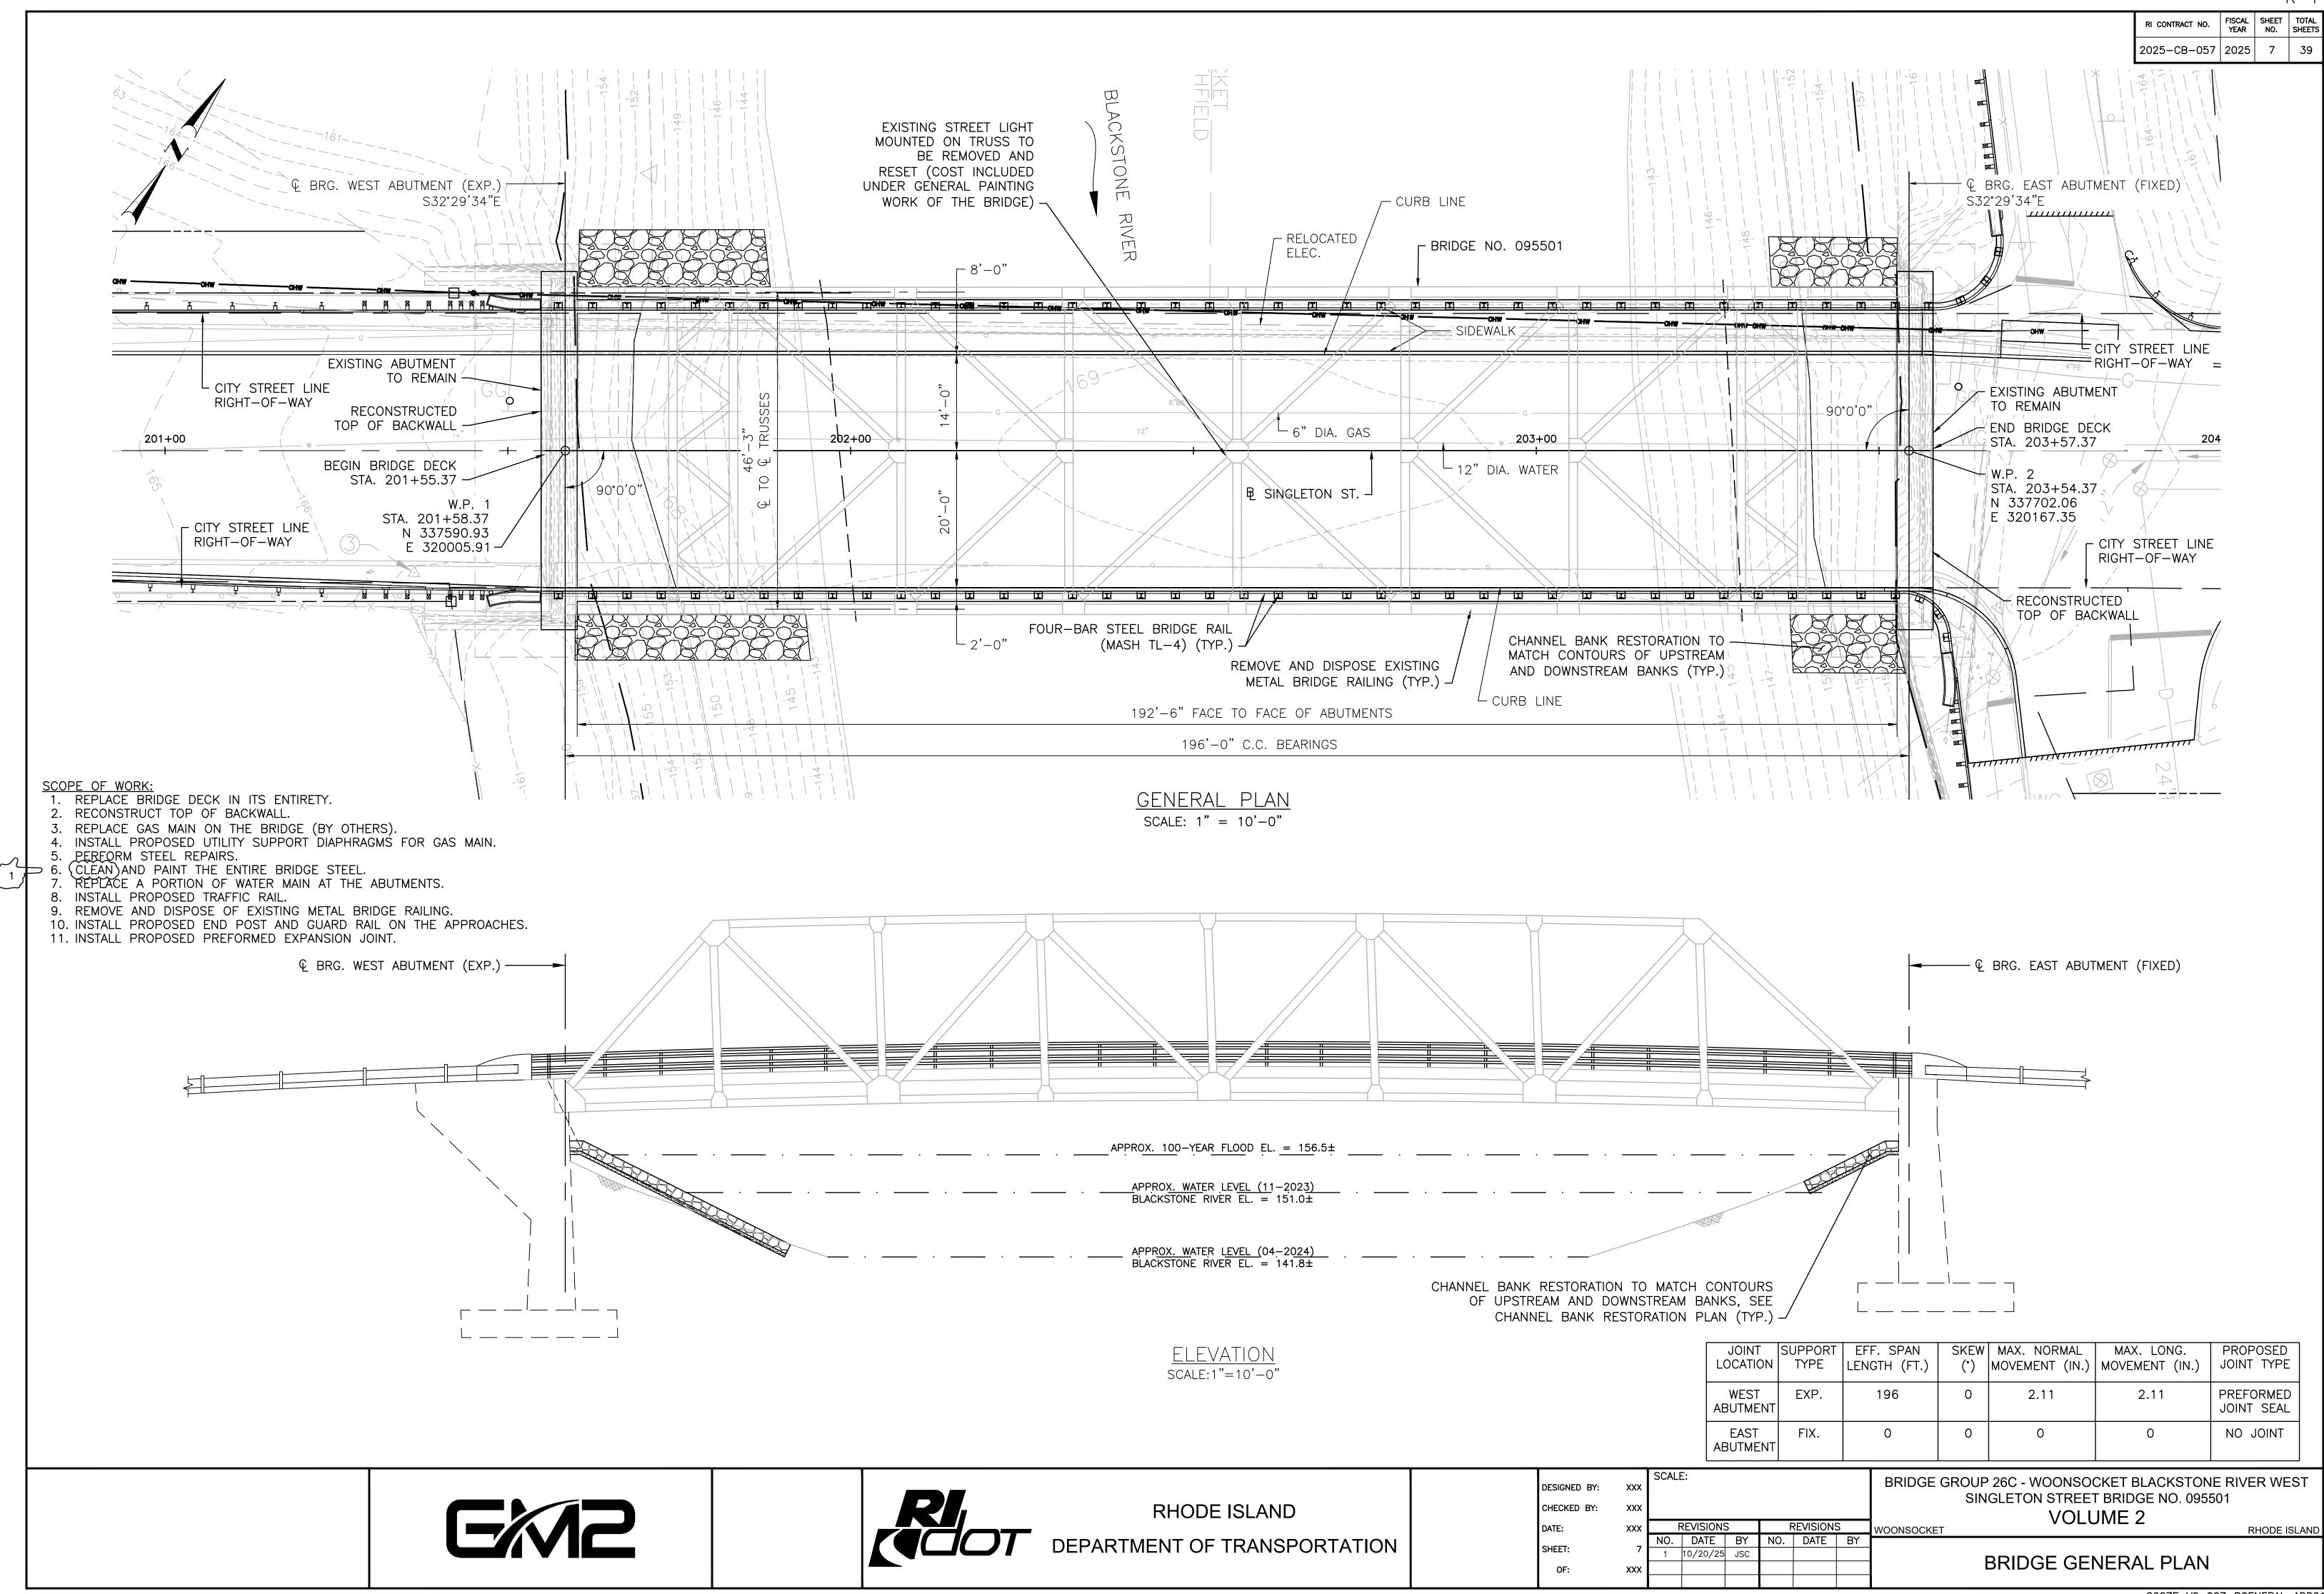
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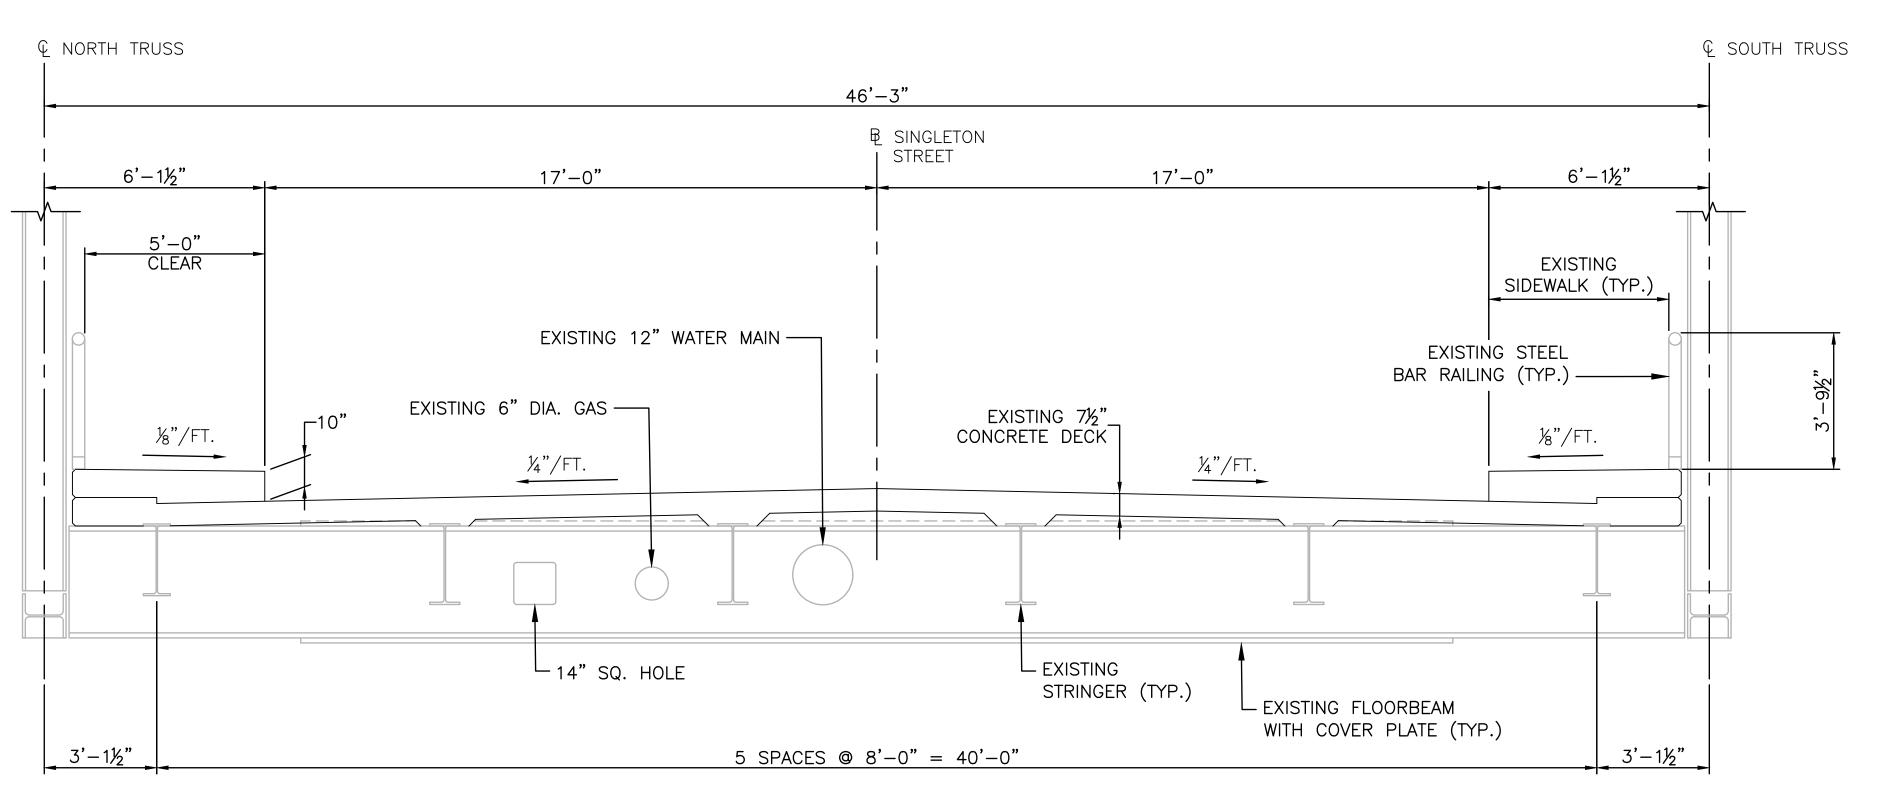
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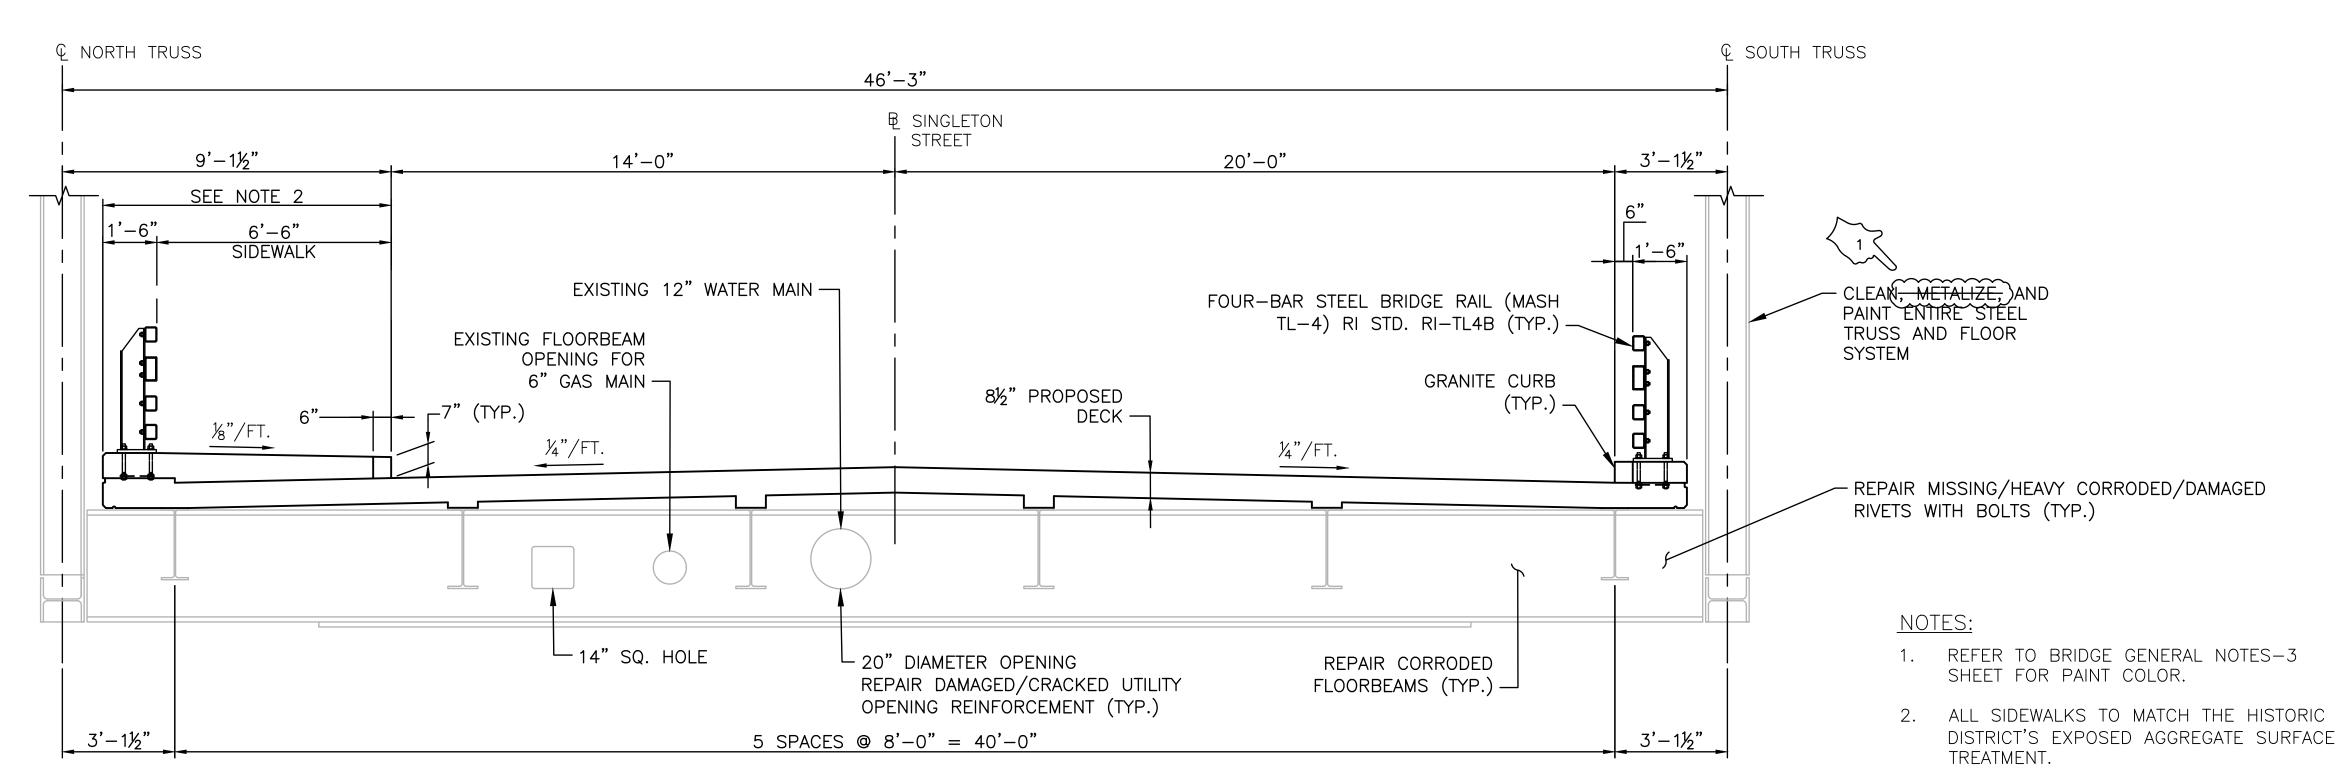
BRIDGE GENERAL NOTES - 3



FISCAL SHEET TOTAL YEAR NO. SHEETS 2025-CB-057 2025 9 39



EXISTING DECK CROSS SECTION (LOOKING UPSTATION) 3/8" = 1'-0"



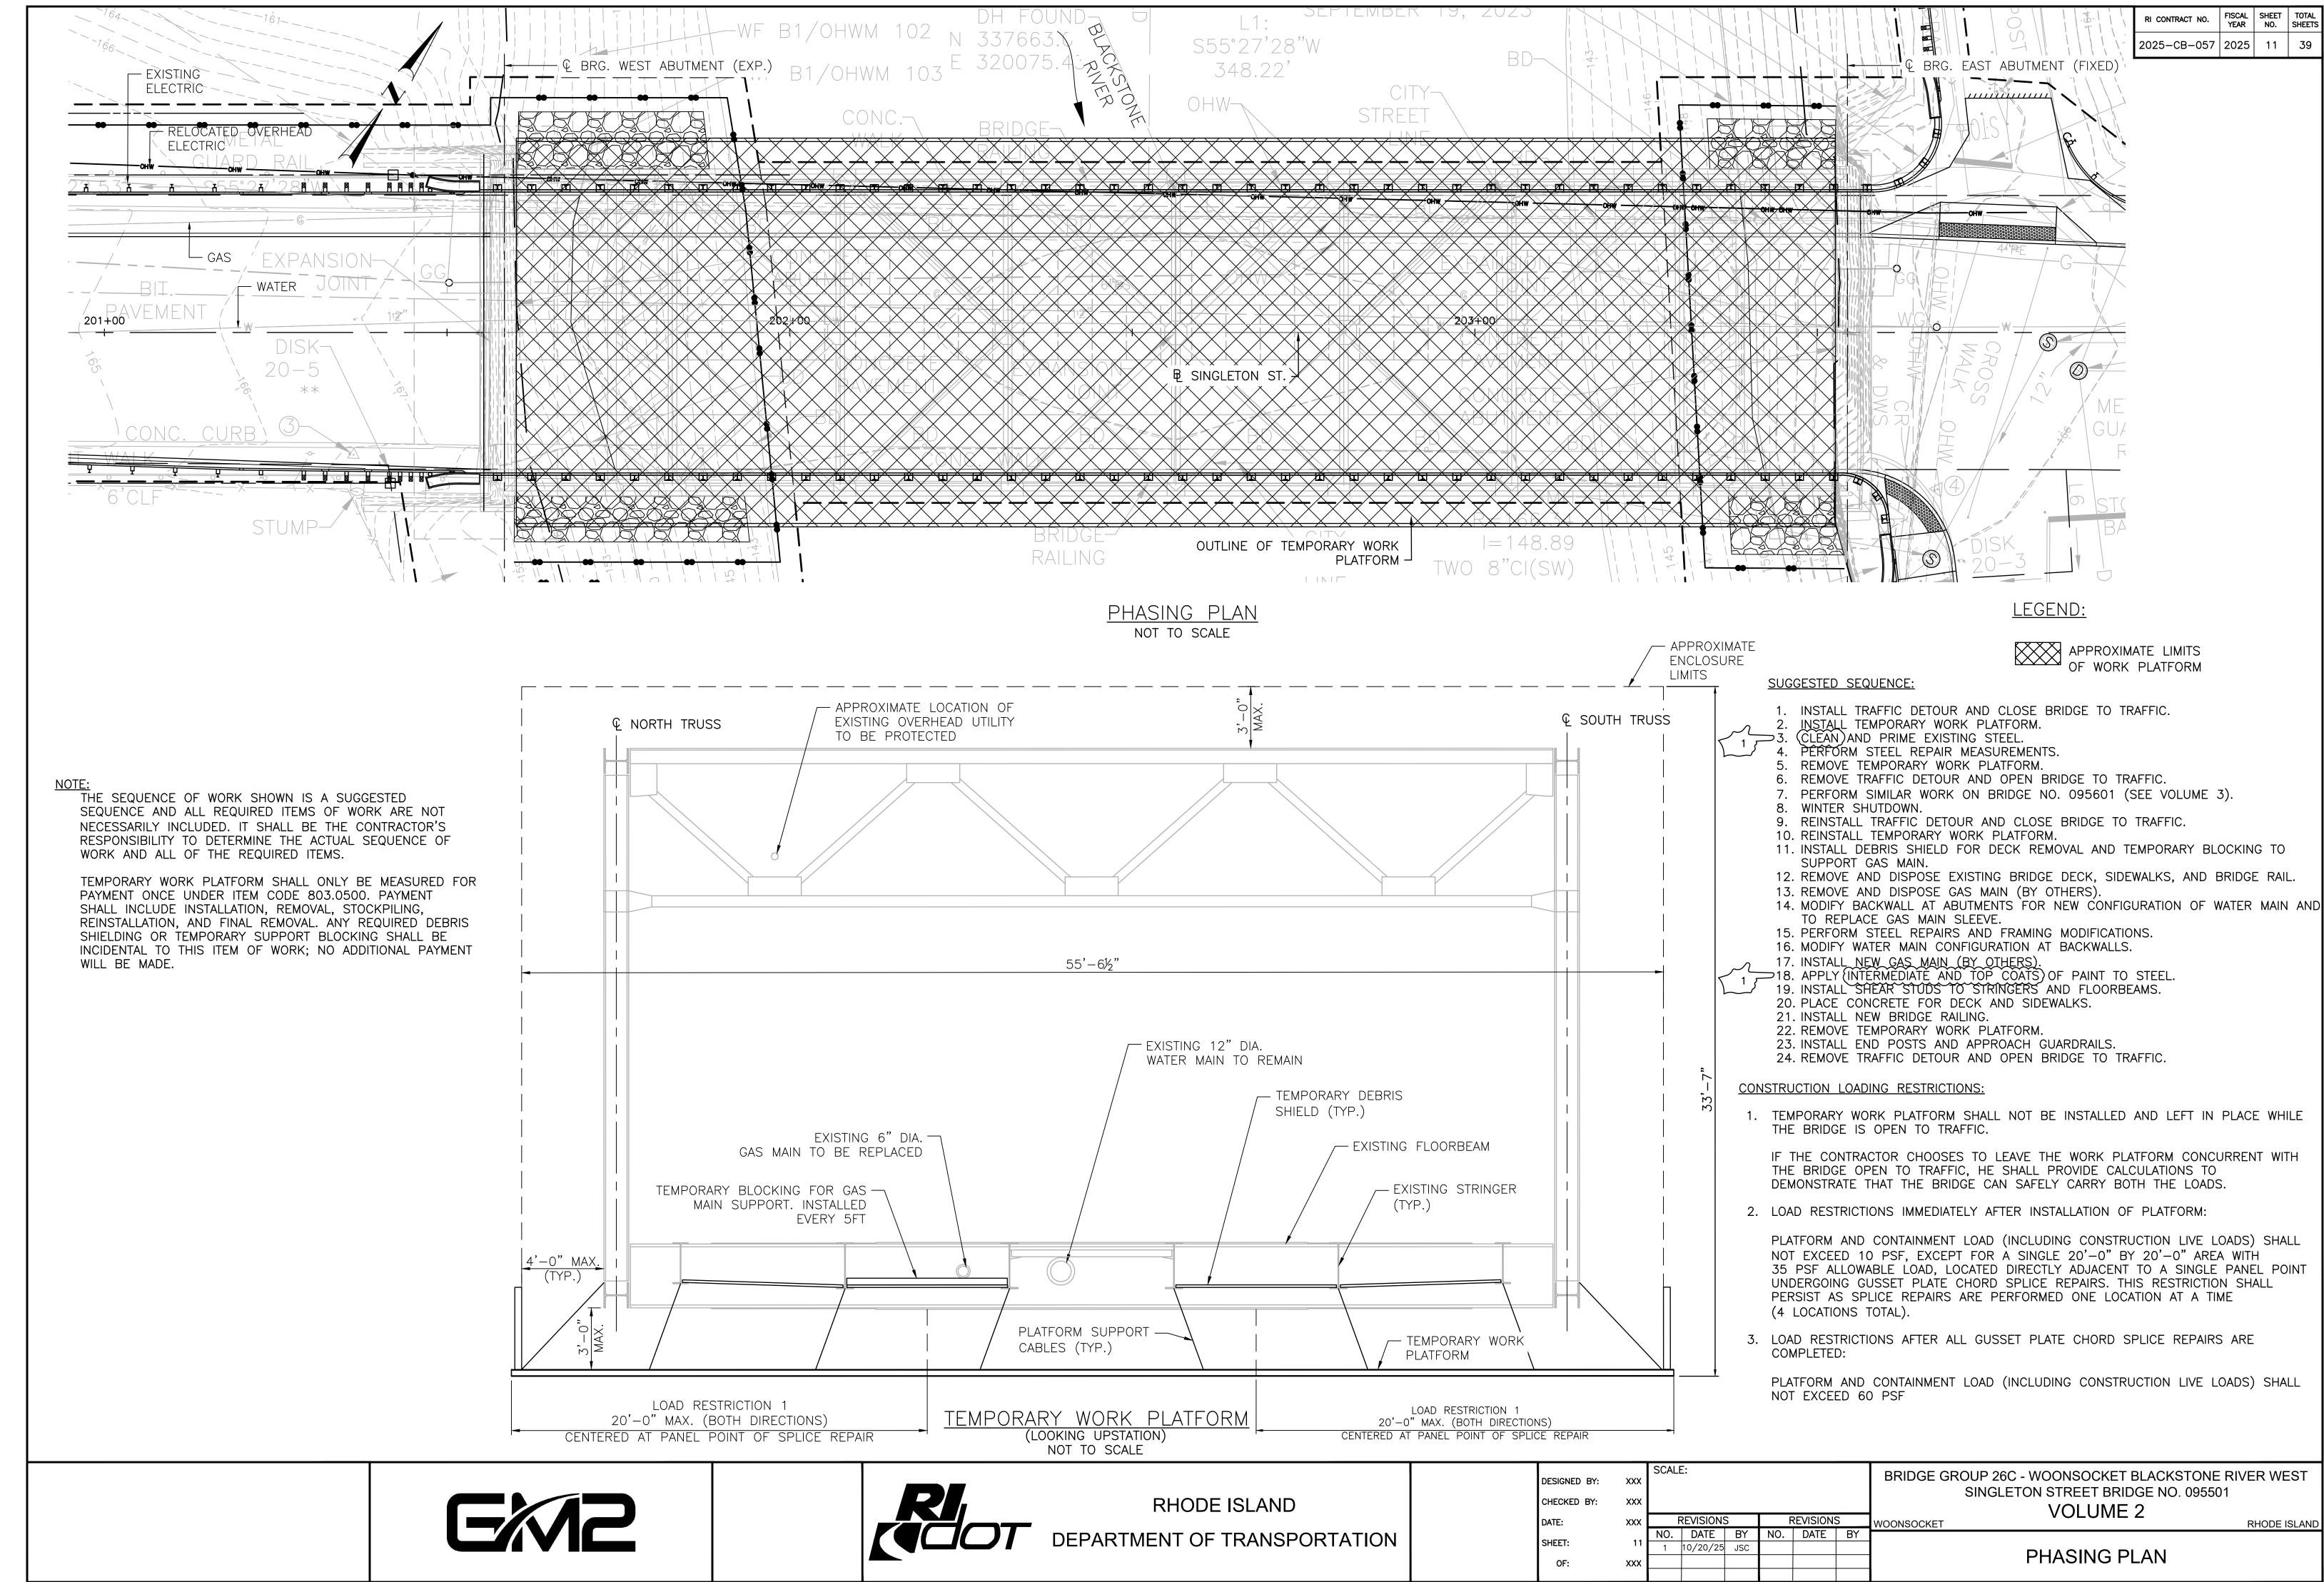
PROPOSED DECK CROSS SECTION (LOOKING UPSTATION) SCALE: 3/8" = 1'-0"



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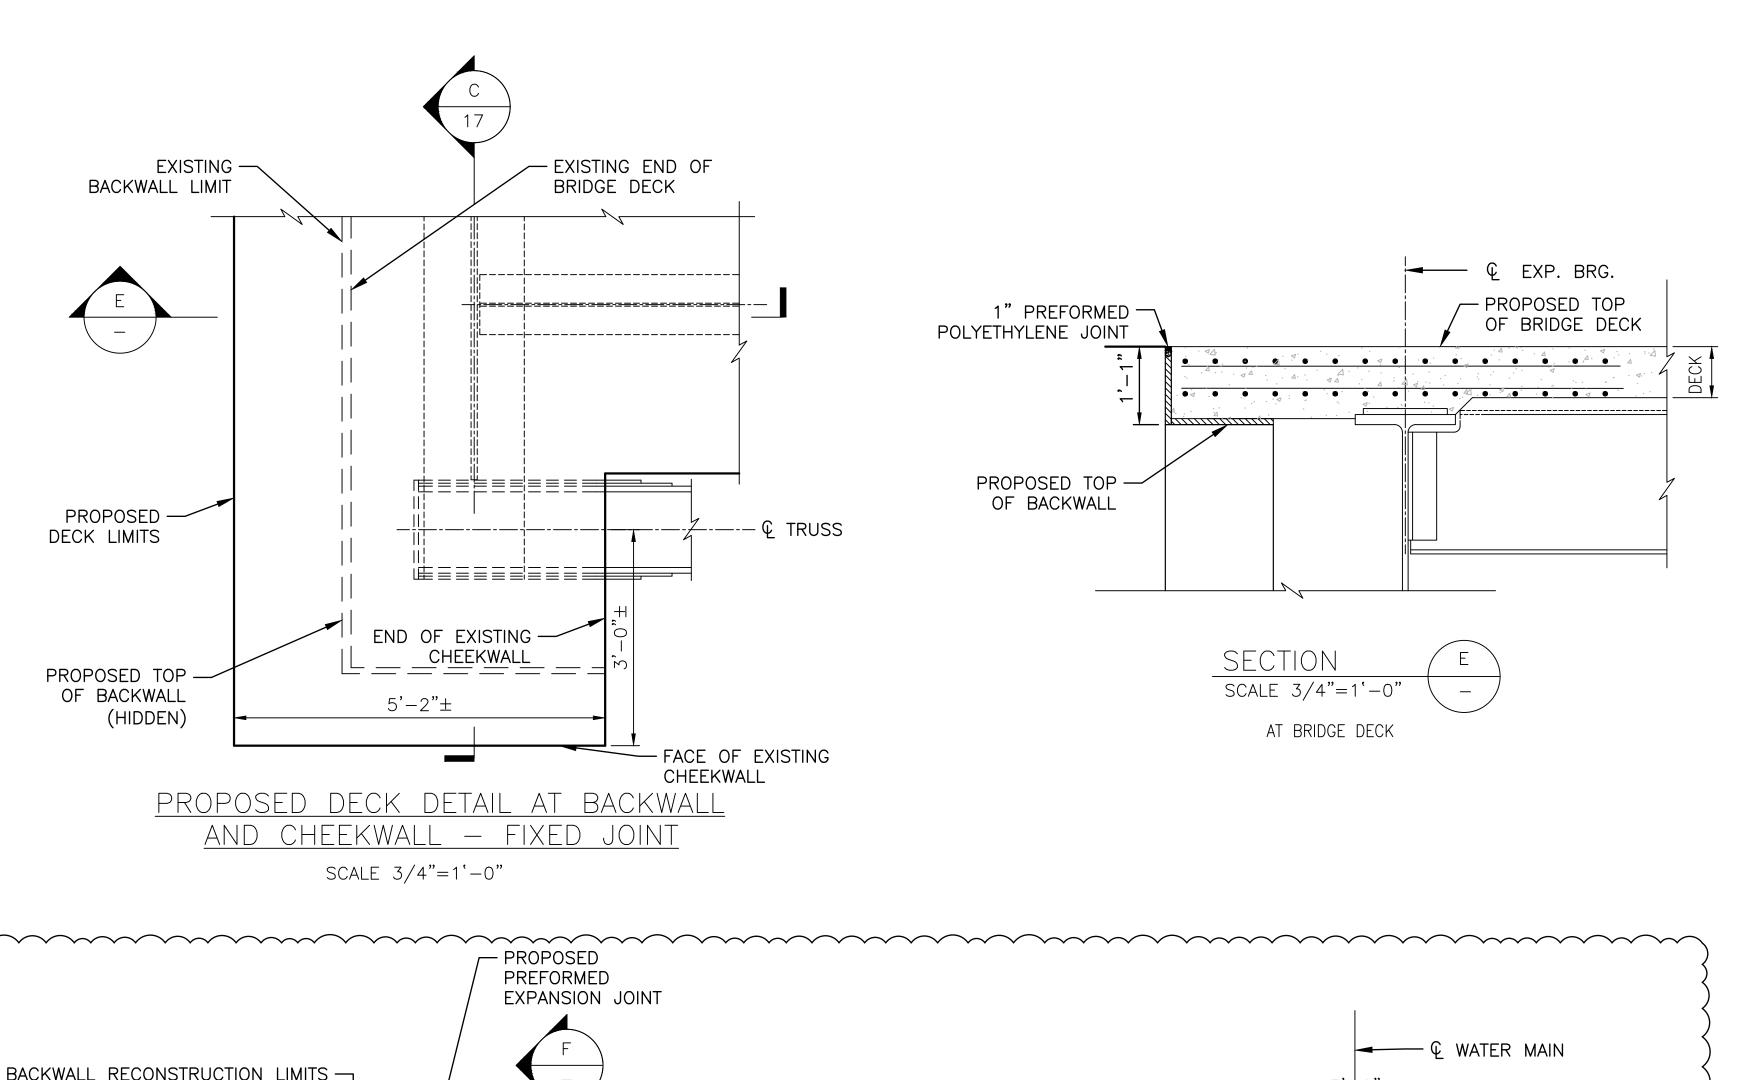
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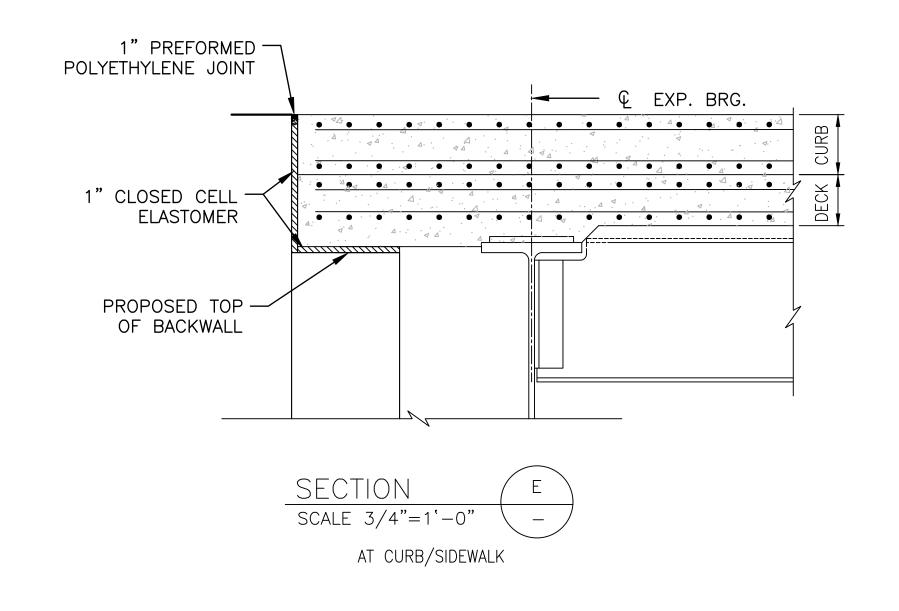
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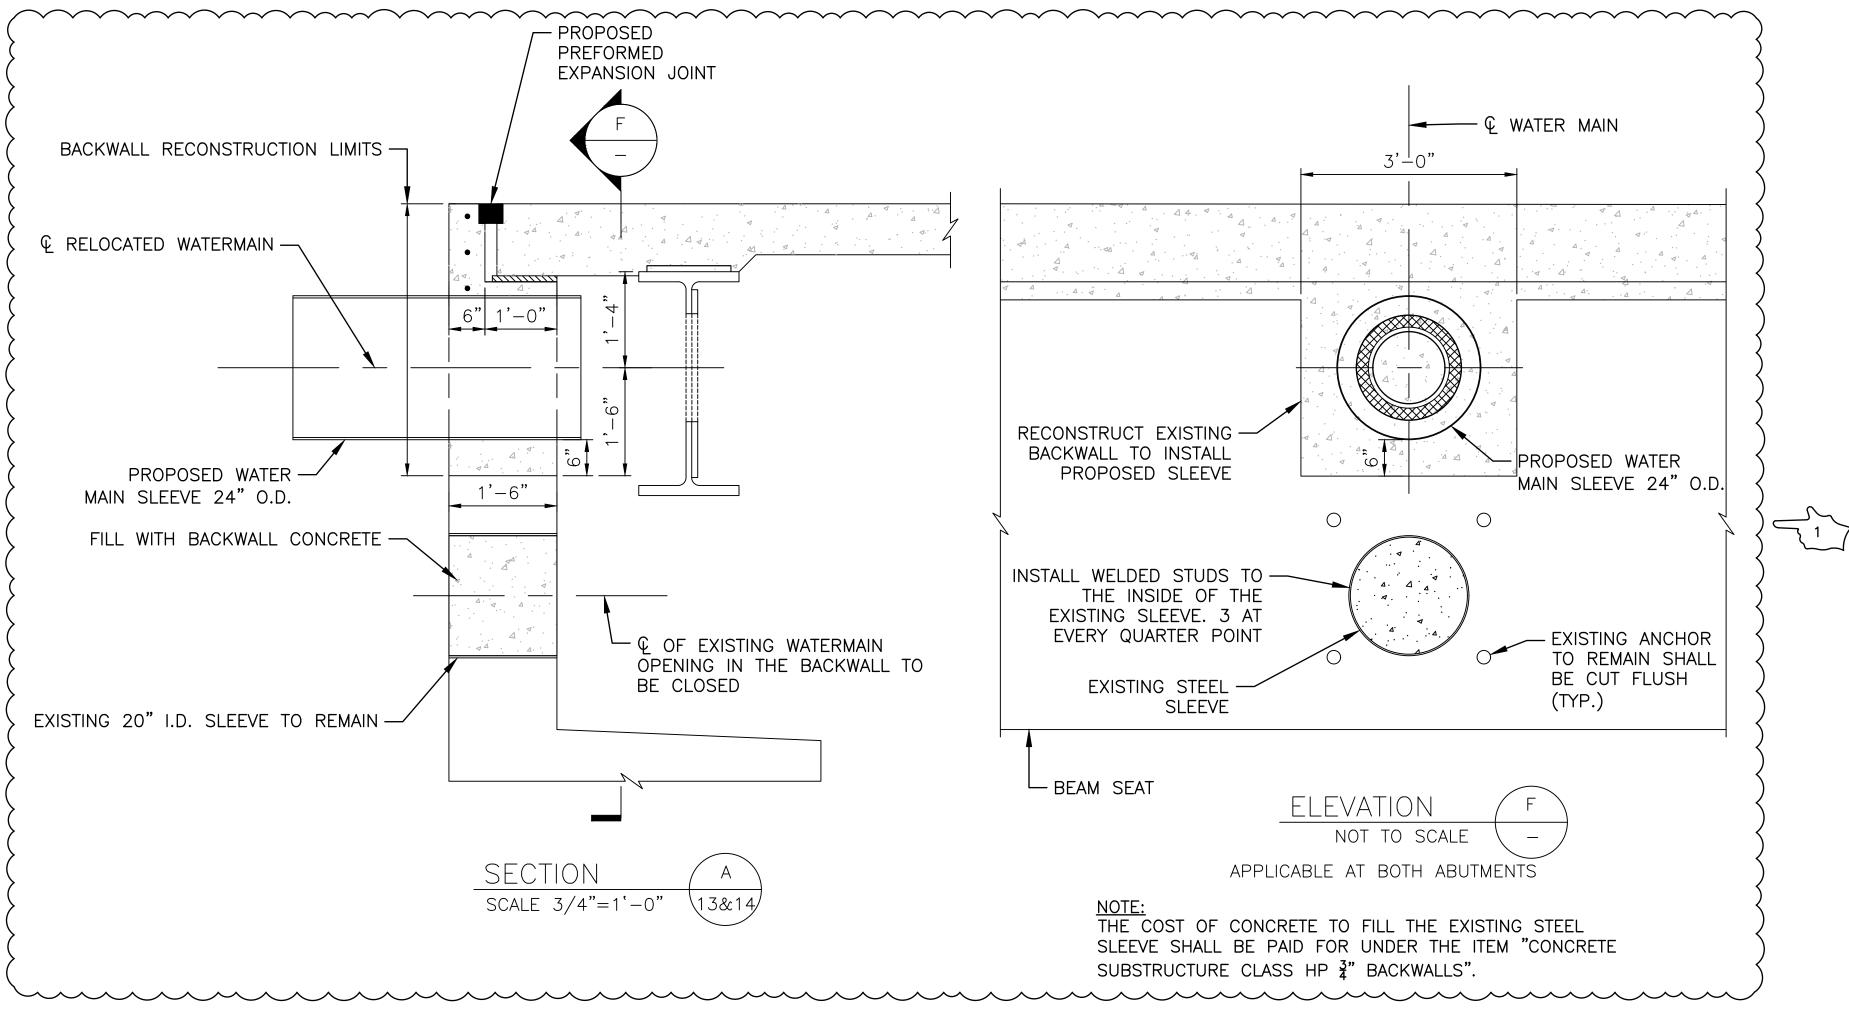


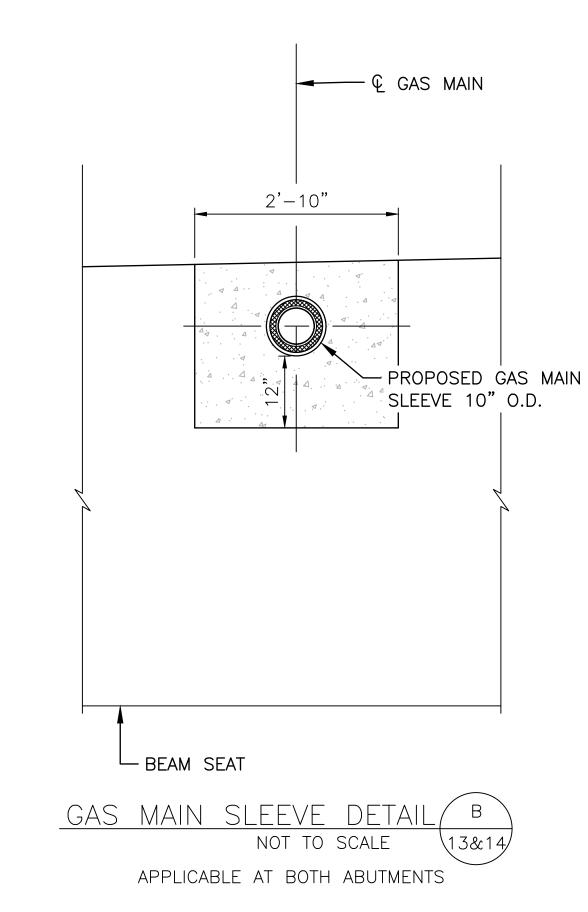
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2025—CB—057 2025 16 39









SEQUENCE OF CONSTRUCTION FOR SLEEVE INSTALLATION:

- 1. REMOVE CONCRETE IN THE EXISTING BACKWALL TO THE DIMENSIONS.
- 2. PLACE THE GAS/WATER MAIN ALONG WITH THE SLEEVE IN THE BLOCKOUT.
- 3. PUSH THE WATER/GAS MAIN.

WOONSOCKET

- 4. AFTER THE MAINS ARE INSTALLED, POUR CONCRETE AROUND THE SLEEVE FOR COMPLETING THE WORK.
- 5. SLEEVES FOR THE GAS MAIN WILL BE PROVIDED BY RI ENERGY
- PROVIDED BY RI ENERGY.

 6. CONTRACTOR TO COORDINATE THE REMOVAL
- AND INSTALLATION OF THE GAS/WATER MAINS WITH THE UTILITY COMPANIES.



RHODE ISLAND
DEPARTMENT OF TRANSPORTATION

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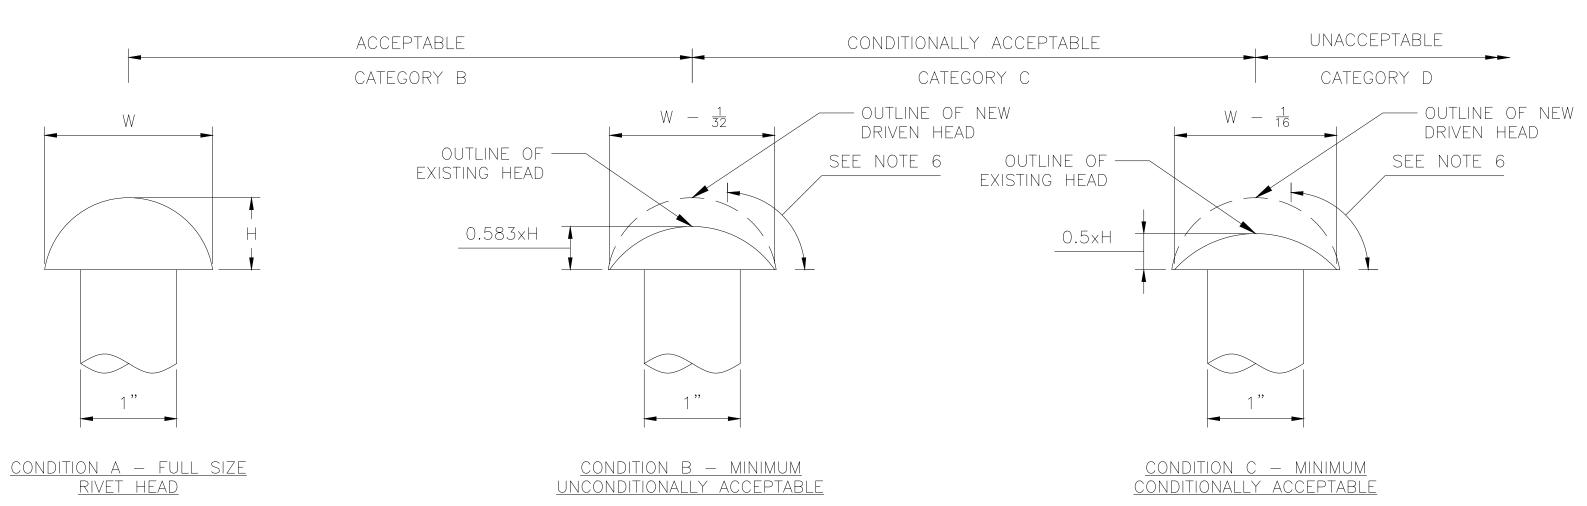
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VOLUME 2

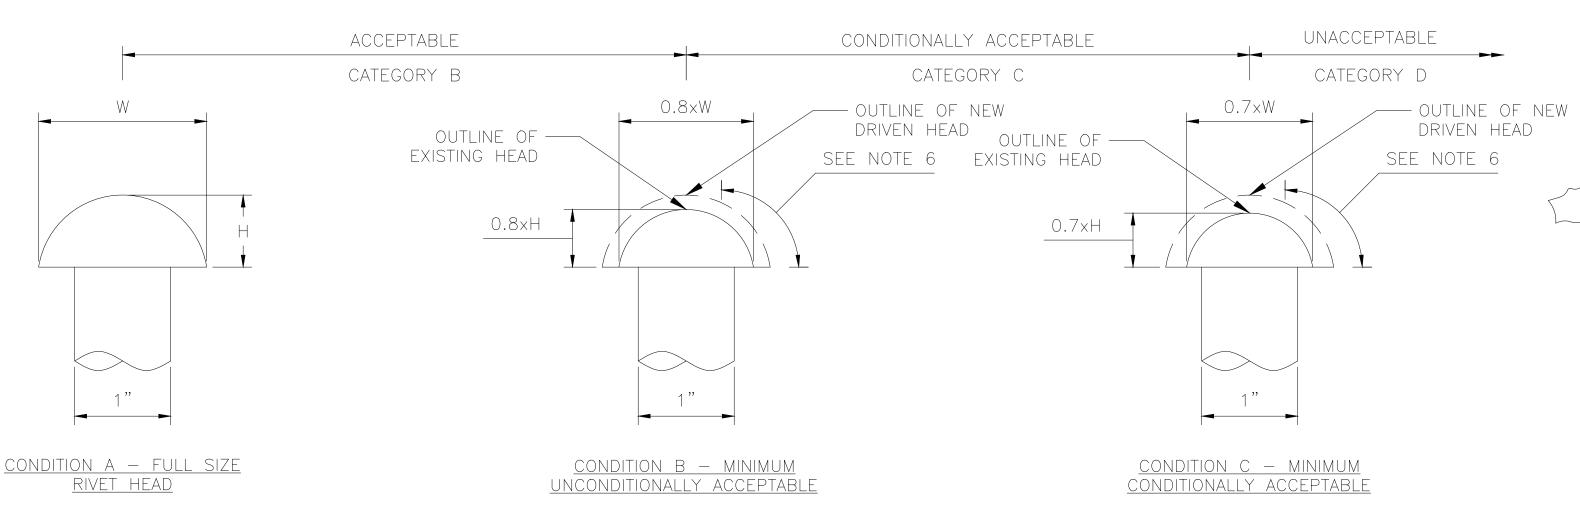
BACKWALL AND CHEEKWALL MODIFICATION DETAILS - 2

RHODE ISLAND

FISCAL SHEET TOTA YEAR NO. SHEET 2025-CB-057 | 2025 | 22 | 39



RIVET REPLACEMENT CRITERIA FOR DETERIORATION IN HEAD CROWN SCALE: 1'=1'-0"



<u>rivet replacement criteria for deterioration in overall head</u>

RIVET REPLACEMENT NOTES

- 1. REMOVAL OF RIVETS FOR THE PURPOSE OF MAKING VARIOUS STRUCTURAL STEEL REPAIRS INDICATED ON THE PLANS OR AS ORDERED BY THE ENGINEER ARE NOT INCLUDED IN THE CRITERIA.
- 2. DETERIORATED RIVETS NOT COVERED UNDER NOTE 1 ABOVE WILL BE INSPECTED BY THE ENGINEER, WHO WILL ORDER THAT SPECIFIC RIVETS BE REPLACED WITH HIGH STRENGTH BOLTS IN ACCORDANCE WITH FOLLOWING GUIDELINES.
- 3. RIVETS (CONDITION B) WITH DIMENSIONS OF BOTH HEADS MEETING OR SURPASSING EACH OF THE MINIMUM DIMENSIONS SHOWN FOR CONDITION B MAY BE LEFT IN PLACE SUBJECT TO CONDITIONS DESCRIBED IN NOTE 6.
- 4. RIVETS (CONDITION C) NOT MEETING THE REQUIREMENTS OF CONDITION B, BUT HAVING DIMENSIONS WHICH MEET OR SURPASS AT BOTH HEADS EACH OF THE MINIMUM REQUIREMENTS SHOWN FOR CONDITION C MAY BE LEFT IN PLACE SUBJECT TO THE FOLLOWING CONDITIONS:
 - A) THERE IS NO PRYING ACTION FROM APPLIED STRESS WHICH TENDS TO SEPARATE THE CONNECTED PARTS.
 - B) RIVETS HEADS DO NOT HAVE ADDITIONAL LOSSES DESCRIBED IN NOTE 6.
 - C) RIVETS MAY BE LEFT IN PLACE TO THE EXTENT THAT THEIR NUMBER DOES NOT EXCEED 15% OF CONNECTION RIVETS IN ANY ONE CONNECTION OR 40% OF STITCH RIVETS.
 - D) WHERE THE ABOVE PERCENTAGES ARE EXCEEDED THE NUMBER OF RIVETS OVER THE PRESCRIBED PERCENTAGE SHALL BE REPLACED WITH HIGH STRENGTH BOLTS.
 - E) WHEN SELECTING RIVETS FOR REPLACEMENT TO MEET THE ABOVE PERCENTAGE REQUIREMENTS, THE WORST RIVETS IN ANY GROUP OR CONNECTION SHALL BE SELECTED FOR REPLACEMENT.
- 5. RIVETS (CONDITION D) NOT MEETING THE REQUIREMENTS OF CONDITION C AT EITHER HEAD SHALL BE REPLACED (CONDITION D NOT SHOWN).
- 6. REPLACEMENT WILL ALSO BE REQUIRED FOR ANY RIVET EXHIBITING ADDITIONAL LOSS IN THE FORM OF PITS OR GOUGES OF THE EDGE OF EITHER HEAD PROJECTING BEYOND THE SHANK WHERE SUCH LOSS REDUCES THE SECTION BELOW THE
- RIVETS REPLACED IN ACCORDANCE WITH NOTES 2 THROUGH 6 WILL BE PAID FOR UNDER THE ITEM "REPLACE REMOVED OR
- DIMENSIONS SHOWN ON THESE DETAILS FOR CONDITION B AND C ARE MINIMUM REQUIREMENTS FOR BOTH DRIVEN AND MANUFACTURED HEADS. THE MINIMUM HEIGHT OF A RIVET HEAD IS MEASURED TO THE CENTER OF THE RIVET. THE MINIMUM DIAMETER APPLIES TO THAT DIRECTION IN WHICH IT IS THE SMALLEST.
- 9. THE SELECTION AND INSTALLATION OF BOLTS SHALL BE IN ACCORDANCE WITH THE SPECIFICATIONS. FOR EACH BOLT IN THESE ITEMS, A MINIMUM OF TWO WASHERS SHALL BE USED, ONE UNDER EACH HEAD AND NUT. THE CONTRACTOR SHALL TAKE ALL NECESSARY FIELD MEASUREMENTS TO DETERMINE PROPER GRIP LENGTHS.
- 10. ONLY ONE RIVET SHALL BE REPLACED AT A TIME WITHIN A REPAIR LOCATION.
- 11. THE NEW BOLTS TO BE INSTALLED SHALL BE 7/8" DIA. AT THE APPROACH SPANS AND 1" DIA. AT THE RIVER SPAN, ASTM F3125, TYPE 1 HIGH STRENGTH BOLTS WITH NUT AND WASHER.

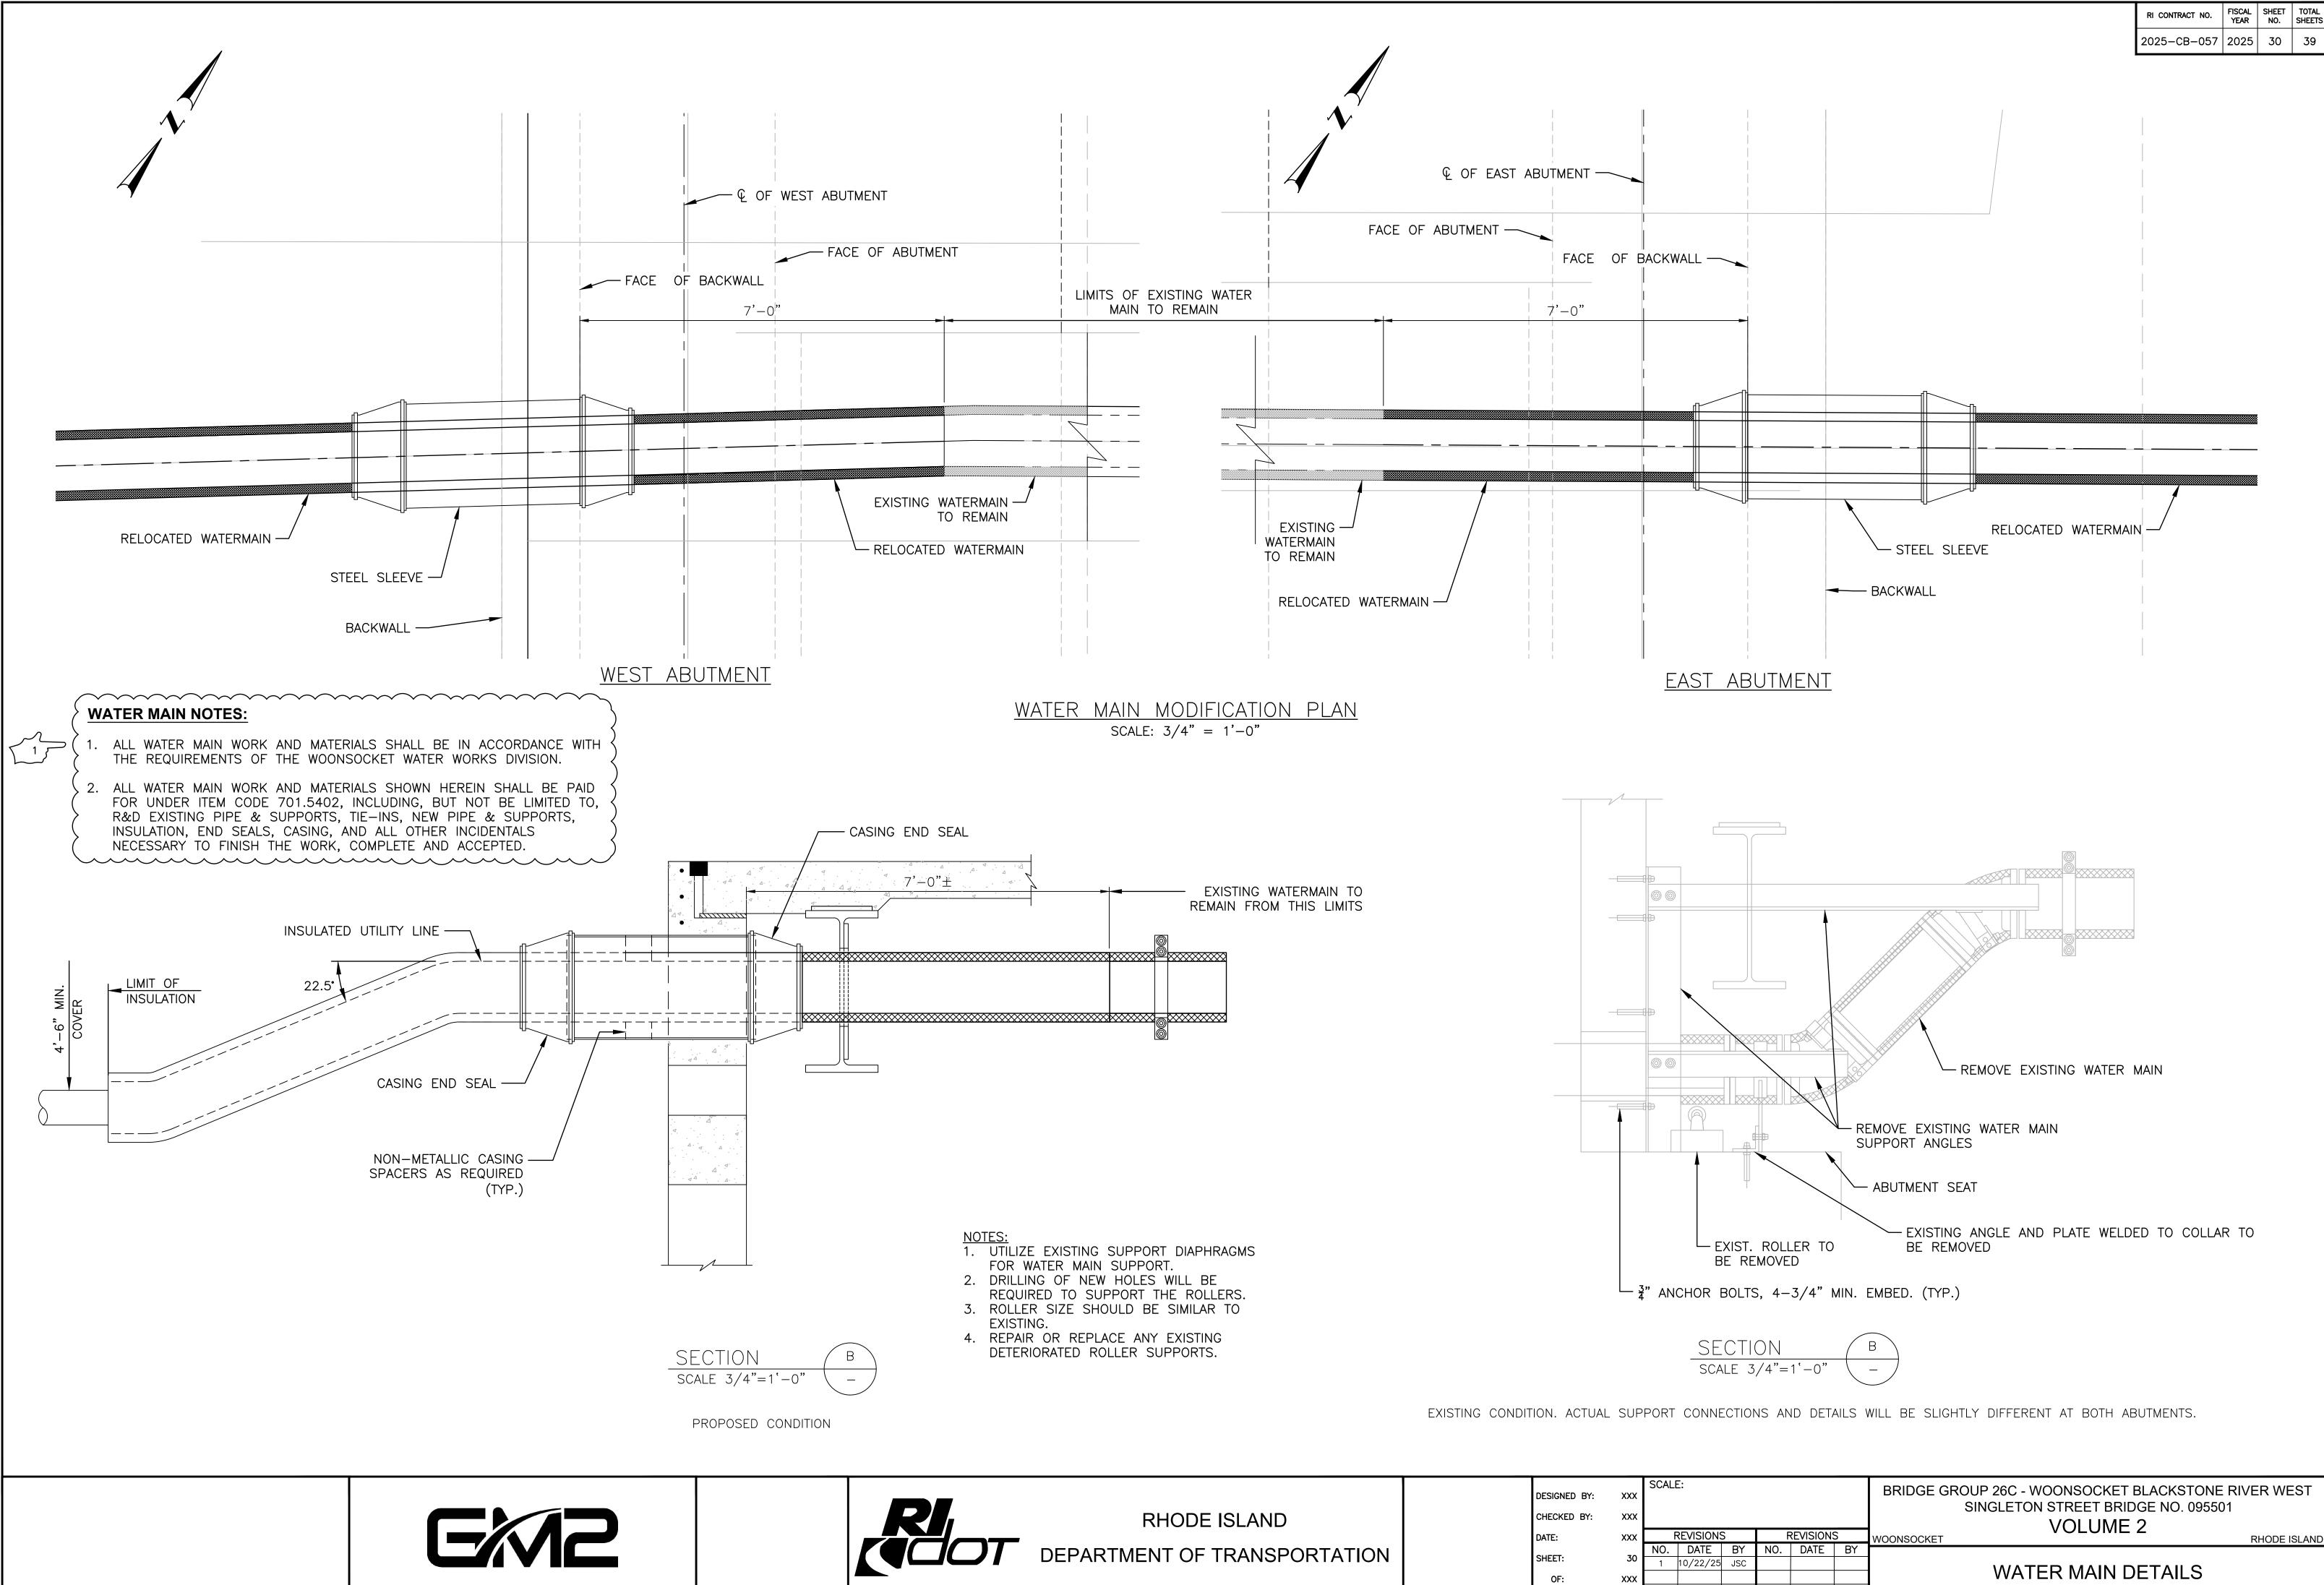


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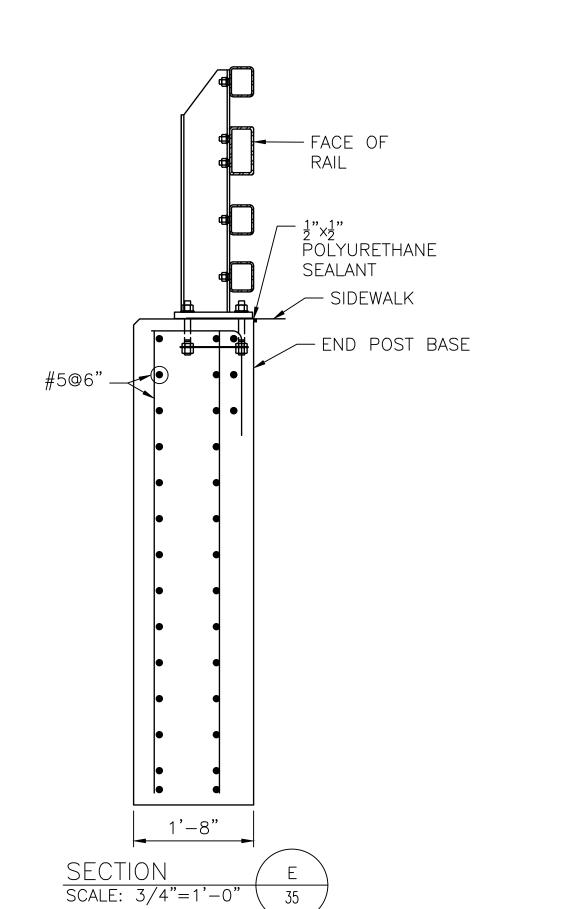
SINGLETON STREET BRIDGE NO. 095501 VOLUME 2 RHODE ISLAND

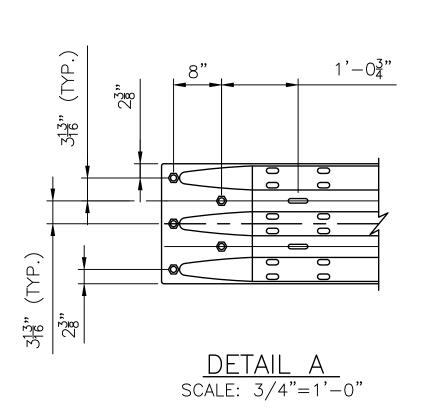
STEEL REPAIR DETAILS - 1

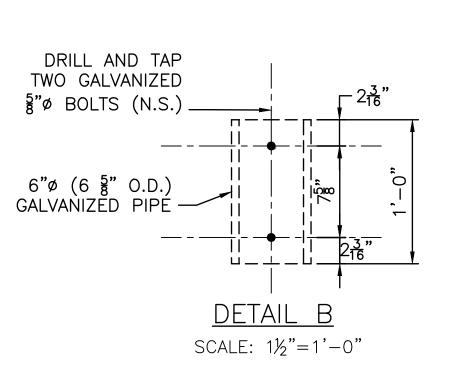


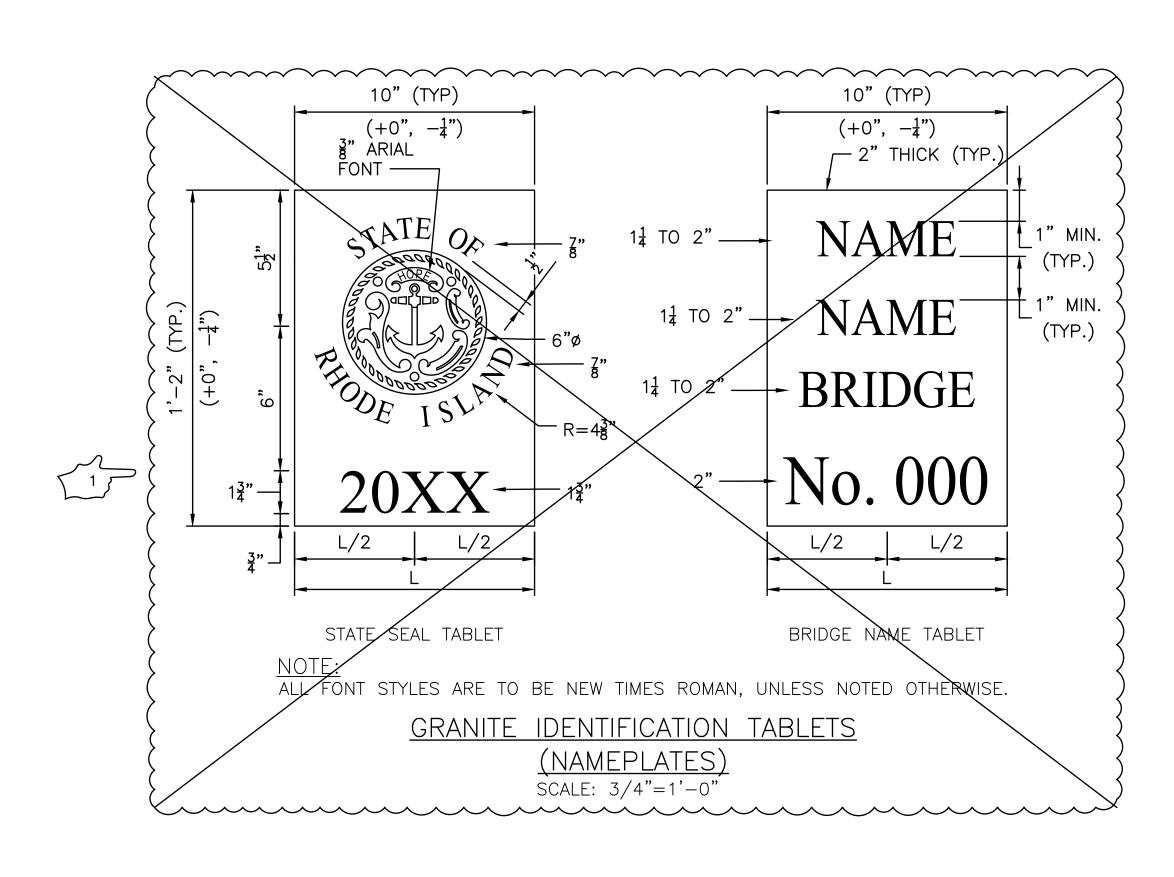
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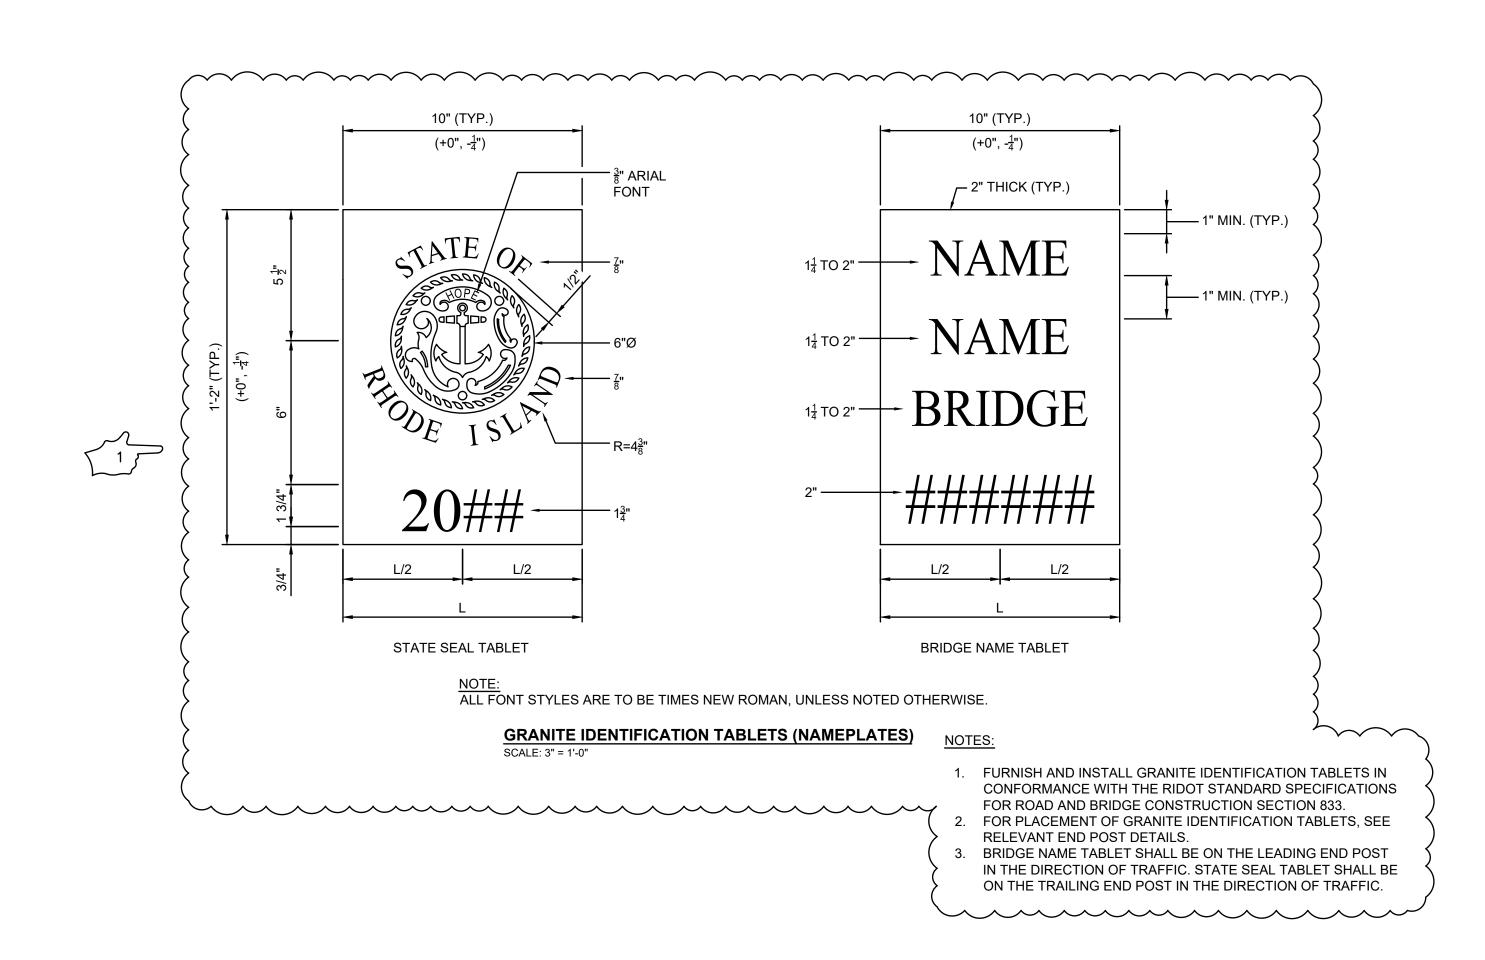
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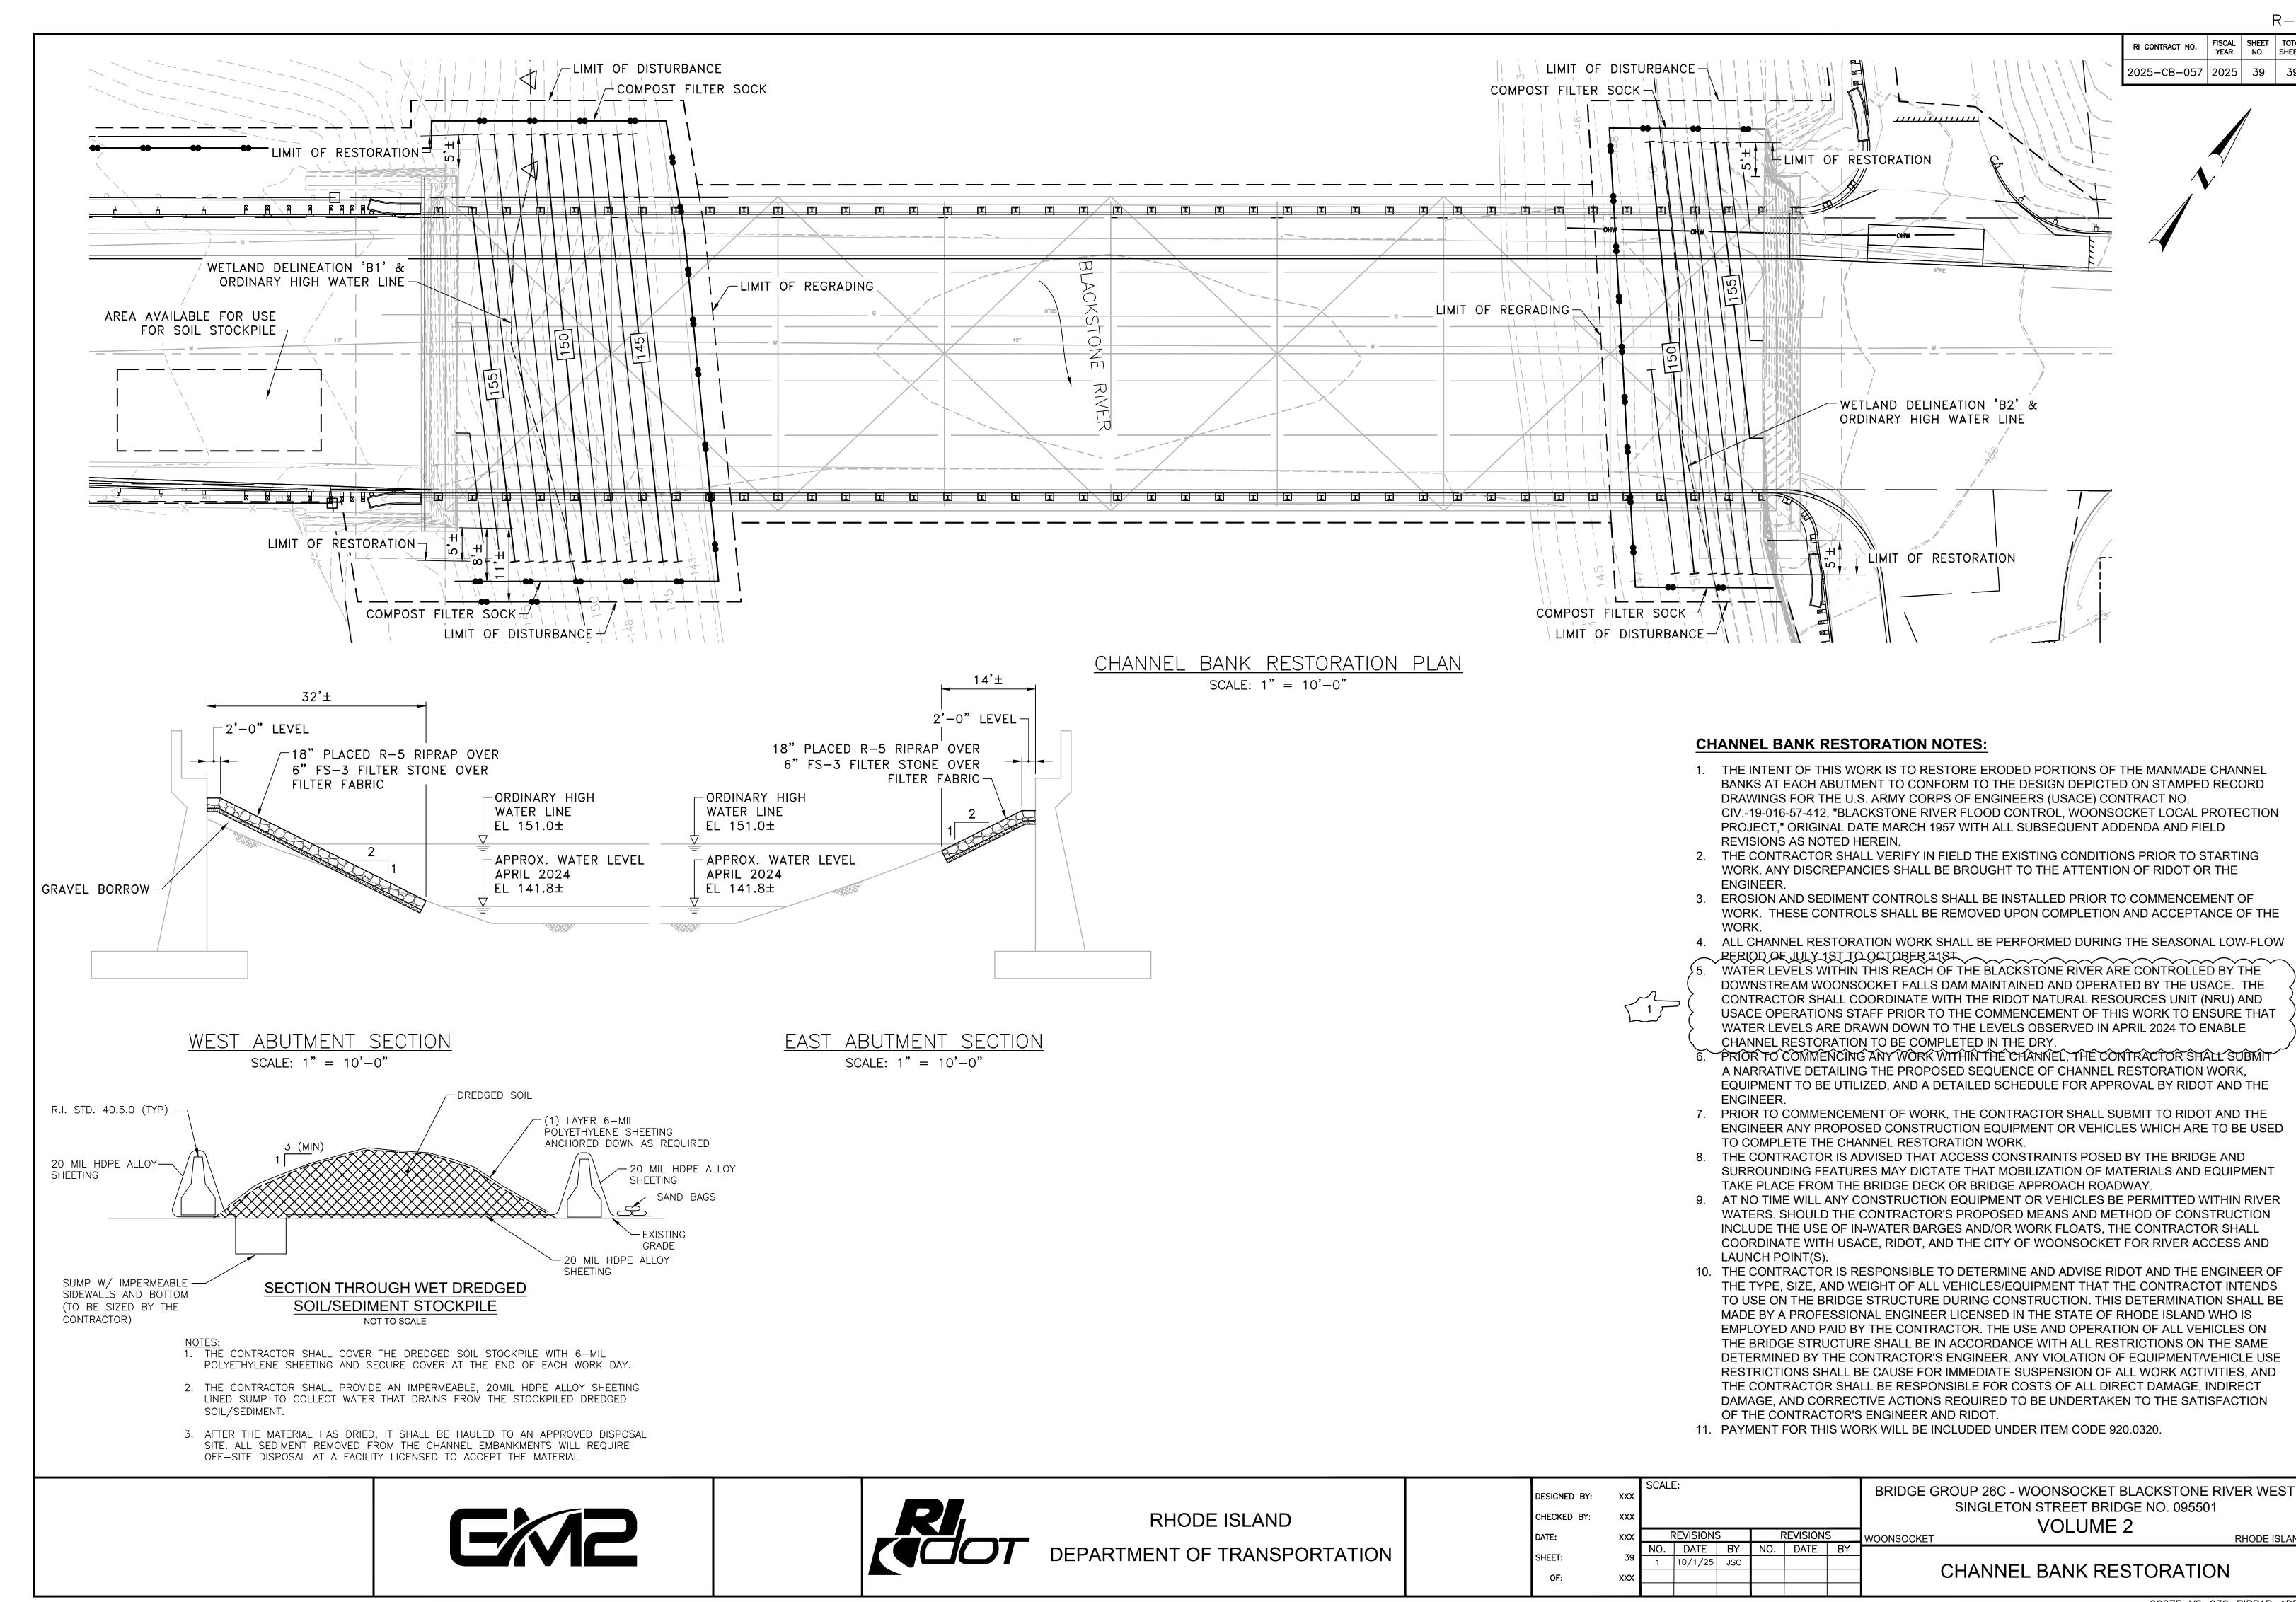
RHODE ISLAND
DEPARTMENT OF TRANSPORTATION

BRIDGE GROUP 26C - WOONSOCKET BLACKSTONE RIVER WEST
SINGLETON STREET BRIDGE NO. 095501
VOLUME 2
WOONSOCKET
RHODE ISLAND

MISCELANEOUS DETAILS

FISCAL SHEET TOTAL YEAR NO. SHEETS

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RHODE ISLAND

VOLUME 2

| RI CONTRACT NO. | FISCAL | SHEET | TOTAL |
|-----------------|--------|-------|--------|
| | YEAR | NO. | SHEETS |
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STRUCTURAL STEEL NOTES

- 1. FRAMING DIMENSIONS ARE GIVEN ALONG CENTERLINES OF GIRDERS AND ALONG CENTERLINES OF BEARINGS ON ABUTMENTS AND PIERS. THE FABRICATOR IS RESPONSIBLE FOR INCORPORATING THE CAMBER, CROSS SLOPE, AND OTHER EFFECTS THAT MAY IMPACT THE OVERALL GIRDER LENGTHS. DIMENSIONS AND/OR THE DETAILING.
- 2. INSTABILITY DURING CONSTRUCTION OF THE GIRDERS (INCLUDING DURING LIFTING, TRANSPORTING AND ERECTION) MAY PRESENT A HAZARDOUS SITUATION. THE CONTRACTOR SHALL TAKE ALL NECESSARY PRECAUTIONS AND MEASURES TO ENSURE STABILITY AND THEREBY SAFETY DURING THE STEEL ERECTION AND CONSTRUCTION.
- THE SHOPS FABRICATING THE STRUCTURAL STEEL SHALL, AT A MINIMUM, BE CERTIFIED FOR "SIMPLE STEEL BRIDGE STRUCTURES (SBR)".
- 4. THE STEEL ERECTOR/CONTRACTOR FOR THIS PROJECT SHALL BE CERTIFIED FOR "ADVANCED CERTIFIED STEEL ERECTOR (ASCE)" IN ACCORDANCE WITH THE AISC QUALITY CERTIFICATION PROGRAM. THE ERECTOR/CONTRACTOR OF THE STRUCTURAL STEEL SHALL BE REQUIRED TO SUBMIT PROOF OF CURRENT CERTIFICATION AS SPECIFIED.
- 5. THIS BRIDGE CONTAINS FRACTURE CRITICAL MEMBERS (FCM). THESE DETAILS HAVE BEEN DESIGNATED ON THE STEEL FRAMING AND/OR THE STEEL DETAIL SHEETS.
- 6. THIS BRIDGE CONTAINS FATIGUE SENSITIVE DETAILS (FSD). THESE DETAILS HAVE BEEN DESIGNATED ON THE STEEL FRAMING AND/OR THE STEEL DETAIL SHEETS.
- 7. SHOP DRAWINGS FOR ALL FABRICATED STEEL INCLUDING BEARINGS, EXPANSION JOINTS, RAILINGS AND FALSEWORK SHALL BE SUBMITTED TO THE ENGINEER IN SUFFICIENT TIME TO PERMIT CAREFUL CHECKING PRIOR TO FABRICATION.
- 8. INSPECTION OF WELDS INCLUDING RADIOGRAPHIC TESTING (RT) AND MAGNETIC PARTICLE TESTING (MT) SHALL BE IN ACCORDANCE WITH THE RI STANDARD SPECIFICATIONS AND THE AASHTO/AWS BRIDGE WELDING CODE, EXCEPT THAT THE REMAINING PERCENTAGE OF ALL GROOVE WELDS NOT RT TESTED SHALL BE MT OR DYE-PENETRANT TESTED
- 9. STRUCTURAL STEEL SHAPES AND PLATES SHALL CONFORM TO THE LATEST PROVISIONS OF AASHTO DESIGNATION M 270 GRADE 36, GRADE 50, AND 50W AS DESIGNATED ON THE PLANS.
- 10. ALL AASHTO M 270 STRUCTURAL STEEL USED IN GIRDERS (INCLUDING CONNECTION PLATES AND STIFFENERS), SHALL MEET THE ZONE 2 CHARPY V-NOTCH FRACTURE TOUGHNESS TEST REQUIREMENTS AS SPECIFIED IN TABLE 6.6.2-2 OF THE AASHTO LRFD BRIDGE DESIGN SPECIFICATIONS FOR "NONFRACTURE-CRITICAL" AND "FRACTURE-CRITICAL" COMPONENTS. ZONE 2 FRACTURE TOUGHNESS REQUIREMENTS ARE AS FOLLOWS:

NONFRACTURE-CRITICAL

GRADE 36 GRADE 50 OR 50W GRADE 50 OR 50W

15 FT-LBS @ 40°F (UP TO 4 INCHES THICK) 15 FT-LBS @ 40°F (UP TO AND INCLUDING 2 INCHES THICK) 20 FT-LBS @ 40°F (FROM 2 INCH THICK UP TO AND INCLUDING 4 INCHES

FRACTURAL-CRITICAL

GRADE 36 GRADE 50 OR 50W GRADE 50 OR 50W THICK)

25 FT-LBS @ 40°F (UP TO 4 INCHES THICK) 25 FT-LBS @ 40°F (UP TO AND INCLUDING 2 INCHES THICK) 30 FT-LBS @ 40°F (FROM 2 INCH THICK UP TO AND INCLUDING 4 INCHES

SAMPLING AND TESTING PROCEDURES SHALL BE IN ACCORDANCE WITH AASHTO T 243. THE FREQUENCY OF TESTING SHALL BE IN ACCORDANCE WITH THE AASHTO LRFD BRIDGE DESIGN SPECIFICATIONS.

THE CHARPY V-NOTCH FRACTURE TOUGHNESS TEST REQUIREMENT IS NOT MANDATORY FOR THE FOLLOWING STEEL COMPONENTS:

- BEARINGS, MASONRY PLATES AND SOLE PLATES
- EXPANSION JOINTS AND MODULAR BRIDGE JOINT SYSTEMS
- DRAINAGE MATERIAL
- RAILINGS
- 11. WELDING SHALL BE IN ACCORDANCE WITH THE LATEST BRIDGE WELDING CODE AASHTO/AWS D1.5 (INCLUDING ALL INTERIMS TO DATE) AND APPLICABLE SUPPLEMENTAL AWS PUBLICATIONS.
- 12. ALL HIGH STRENGTH BOLTS SHALL CONFORM TO ASTM F3125, GRADE 325, AND THEY SHALL BE INSTALLED IN ACCORDANCE WITH SECTION 824 OF THE RI STANDARD SPECIFICATIONS.
- 13. WASHERS MEETING ASTM F436 ARE TO BE USED OVER ALL HOLES THAT ARE MORE THAN 1/16" IN DIAMETER GREATER THAN THE BOLT DIAMETER AND UNDER ALL PARTS TURNED DURING ASSEMBLY.

- 14. WELDING ELECTRODES SHALL HAVE THE SAME CORROSION RESISTANCE AS THE BASE METAL AND SHALL BE FREE OF MOISTURE AT THE TIME OF USE
- 15. STRUCTURAL STEEL SHALL BE PREPARED AND PAINTED IN ACCORDANCE WITH THE RI STANDARD SPECIFICATIONS. SEE NOTES BELOW FOR COLOR.
- 15. UNLESS OTHERWISE SPECIFIED. THE UPPER SURFACES OF FLOORBEAM AND STRINGER TOP FLANGES THAT WILL COME IN CONTACT WITH CONCRETE SHALL BE FREE OF PAINT. OIL OR OTHER IMPURITIES THAT WOULD IN ANY WAY REDUCE THE BOND OF CONCRETE TO STEEL
- 16. PRIOR TO FABRICATION, ALL MATERIALS SHALL FIRST BE SOLVENT CLEANED TO SSPC-SP1 TO REMOVE ALL OIL, GREASE AND DIRT; FOLLOWED BY BLAST-CLEANING TO SSPC-SP10 TO REMOVE ALL MILL SCALE, RUST, AND OTHER DELETERIOUS MATERIALS FROM THE SURFACES OF THE STEEL TO BE FABRICATED.
- 17. PRIOR TO SHOP COATING AS SPECIFIED IN SECTION 825 OF THE RI STANDARD SPECIFICATIONS ALL CORNERS AND EDGES OF STEEL WHICH HAVE BEEN FLAME CUT OR OTHERWISE HARDENED SHALL BE SOFTENED BY GRINDING OR BLAST-CLEANING TO PROVIDE A SURFACE SUITABLE FOR APPLICATION OF THE SPECIFIED PAINT SYSTEM.
- 18. UPON COMPLETION OF ALL FABRICATION AND PRIOR TO THE APPLICATION OF THE SHOP PRIMER COAT THE STRUCTURAL STEEL SHALL BE RESTORED TO AN SSPC-SP10 CONDITION.
- 19. WELDING OF ATTACHMENTS TO GIRDER FLANGES OR WEBS FOR CONSTRUCTION PURPOSES IS NOT PERMITTED EXCEPT WHEN APPROVED BY THE ENGINEER
- 20. THE ENDS OF ALL GIRDERS SHALL BE VERTICAL AFTER ALL DEAD LOADS HAVE BEEN PLACED.
- 21. BOLTED CONNECTIONS SHALL BE DESIGNED AS SLIP-CRITICAL CONNECTIONS. THE FAYING SURFACES SHALL SATISFY CLASS B SURFACE CONDITION AS DEFINED IN THE AASHTO LRFD BRIDGE DESIGN SPECIFICATIONS.
- 22. ALL SHOP CONNECTIONS AND SPLICES SHALL BE WELDED. WELDING PROCEDURES AND TECHNIQUES TO BE USED IN FABRICATION AND ERECTION OF THE GIRDERS SHALL BE AS SHOWN ON THE SHOP DRAWINGS AND SHALL INCORPORATE THE FOLLOWING:
 - BOTH FLANGES AND THE WEB SHALL BE COMPLETELY FABRICATED FOR THEIR ENTIRE LENGTHS BEFORE THE WELDING OF THE FLANGES TO THE WEB IS PERFORMED.
- ALL WEB AND FLANGE SPLICES OTHER THAN THOSE SHOWN ON THE PLANS MUST BE APPROVED BY THE ENGINEER. ALTERNATE OR ADDITIONAL SPLICES ARE TO BE LOCATED AND DESIGNED BY THE FABRICATOR AND SHOWN ON THE SHOP DRAWINGS. THESE SPLICES ARE TO FULLY DEVELOP THE STRENGTH OF THE WEB AND FLANGE PLATES. WEB SPLICES, IF USED, SHALL BE LOCATED 2'-0" MINIMUM FROM ANY STIFFENER.
- NO MORE THAN TWO SHOP WEB SPLICES WILL BE PERMITTED BETWEEN FIELD SPLICES. SPLICING OF GIRDERS BY FIELD WELDING WILL NOT BE PERMITTED.
- 23. ALL FILLET WELDS SHALL BE IN ACCORDANCE WITH THE BRIDGE WELDING CODE AASHTO/AWS D1.5 TABLE 2.1 (1/4" MINIMUM)
- 24. ALL SHEAR STUD CONNECTORS SHALL BE WELDED BY THE AUTOMATIC TIMED ELECTRIC ARC PROCESS. SHEAR STUDS SHALL BE INSPECTED AND TESTED IN ACCORDANCE WITH SECTION 824 OF THE RI STANDARD SPECIFICATIONS.
- 25. WHEN STEEL DIE STAMPS ARE USED TO IDENTIFY PIECES AND MEMBERS. FABRICATORS SHALL UTILIZE LOW STRESS STAMPS.
- 26. FOR SIZE AND LOCATION OF ANCHOR BOLTS, SEE PIER, ABUTMENT, AND BEARING DRAWINGS.
- 27. IT SHALL BE THE CONTRACTOR'S RESPONSIBILITY TO ENSURE THAT THE EXPANSION JOINT SYSTEM PROVIDED WILL BE COMPATIBLE WITH BOTH THE END OF DECK OR PIER HAUNCHES AND/OR THE STRUCTURAL STEEL FRAMING CONFIGURATION. THAT IS, THE EXPANSION JOINT SYSTEM AND ALL ITS INHERENT COMPONENTS AND ATTACHMENT DEVICES SHALL BE SIZED OR ARRANGED TO BE COMPATIBLE WITH THE GIRDER AND DIAPHRAGM FLANGES. CONNECTION PLATES, BOLTS, SHEAR STUDS AND REINFORCING STEEL THAT SHARE THE END HAUNCH REGION.

PAINT NOTES

- 1. BRIDGE STEEL (TRUSS ELEMENTS, SUPERSTRUCTURE STEEL) -FEDERAL COLOR 24272 (GREEN, SEMI-GLOSS). THIS INCLUDES ALL ELEMENTS AFTER REPAIRS.
- 2 4-BAR TRAFFIC RAIL FEDERAL COLOR 17038 (BLACK, GLOSS).

METALIZING/GALVANIZING NOTES

EXISTING BRIDGE STEEL (TRUSS ELEMENTS, SUPERSTRUCTURE STEEL) SHALL BE FIELD METALIZED.

PROPOSED REPAIR PLATES, STRUCTURAL STEEL SHALL BE SHOP METALIZED.

TRAFFIC RAILING SHALL BE GALVANIZED.



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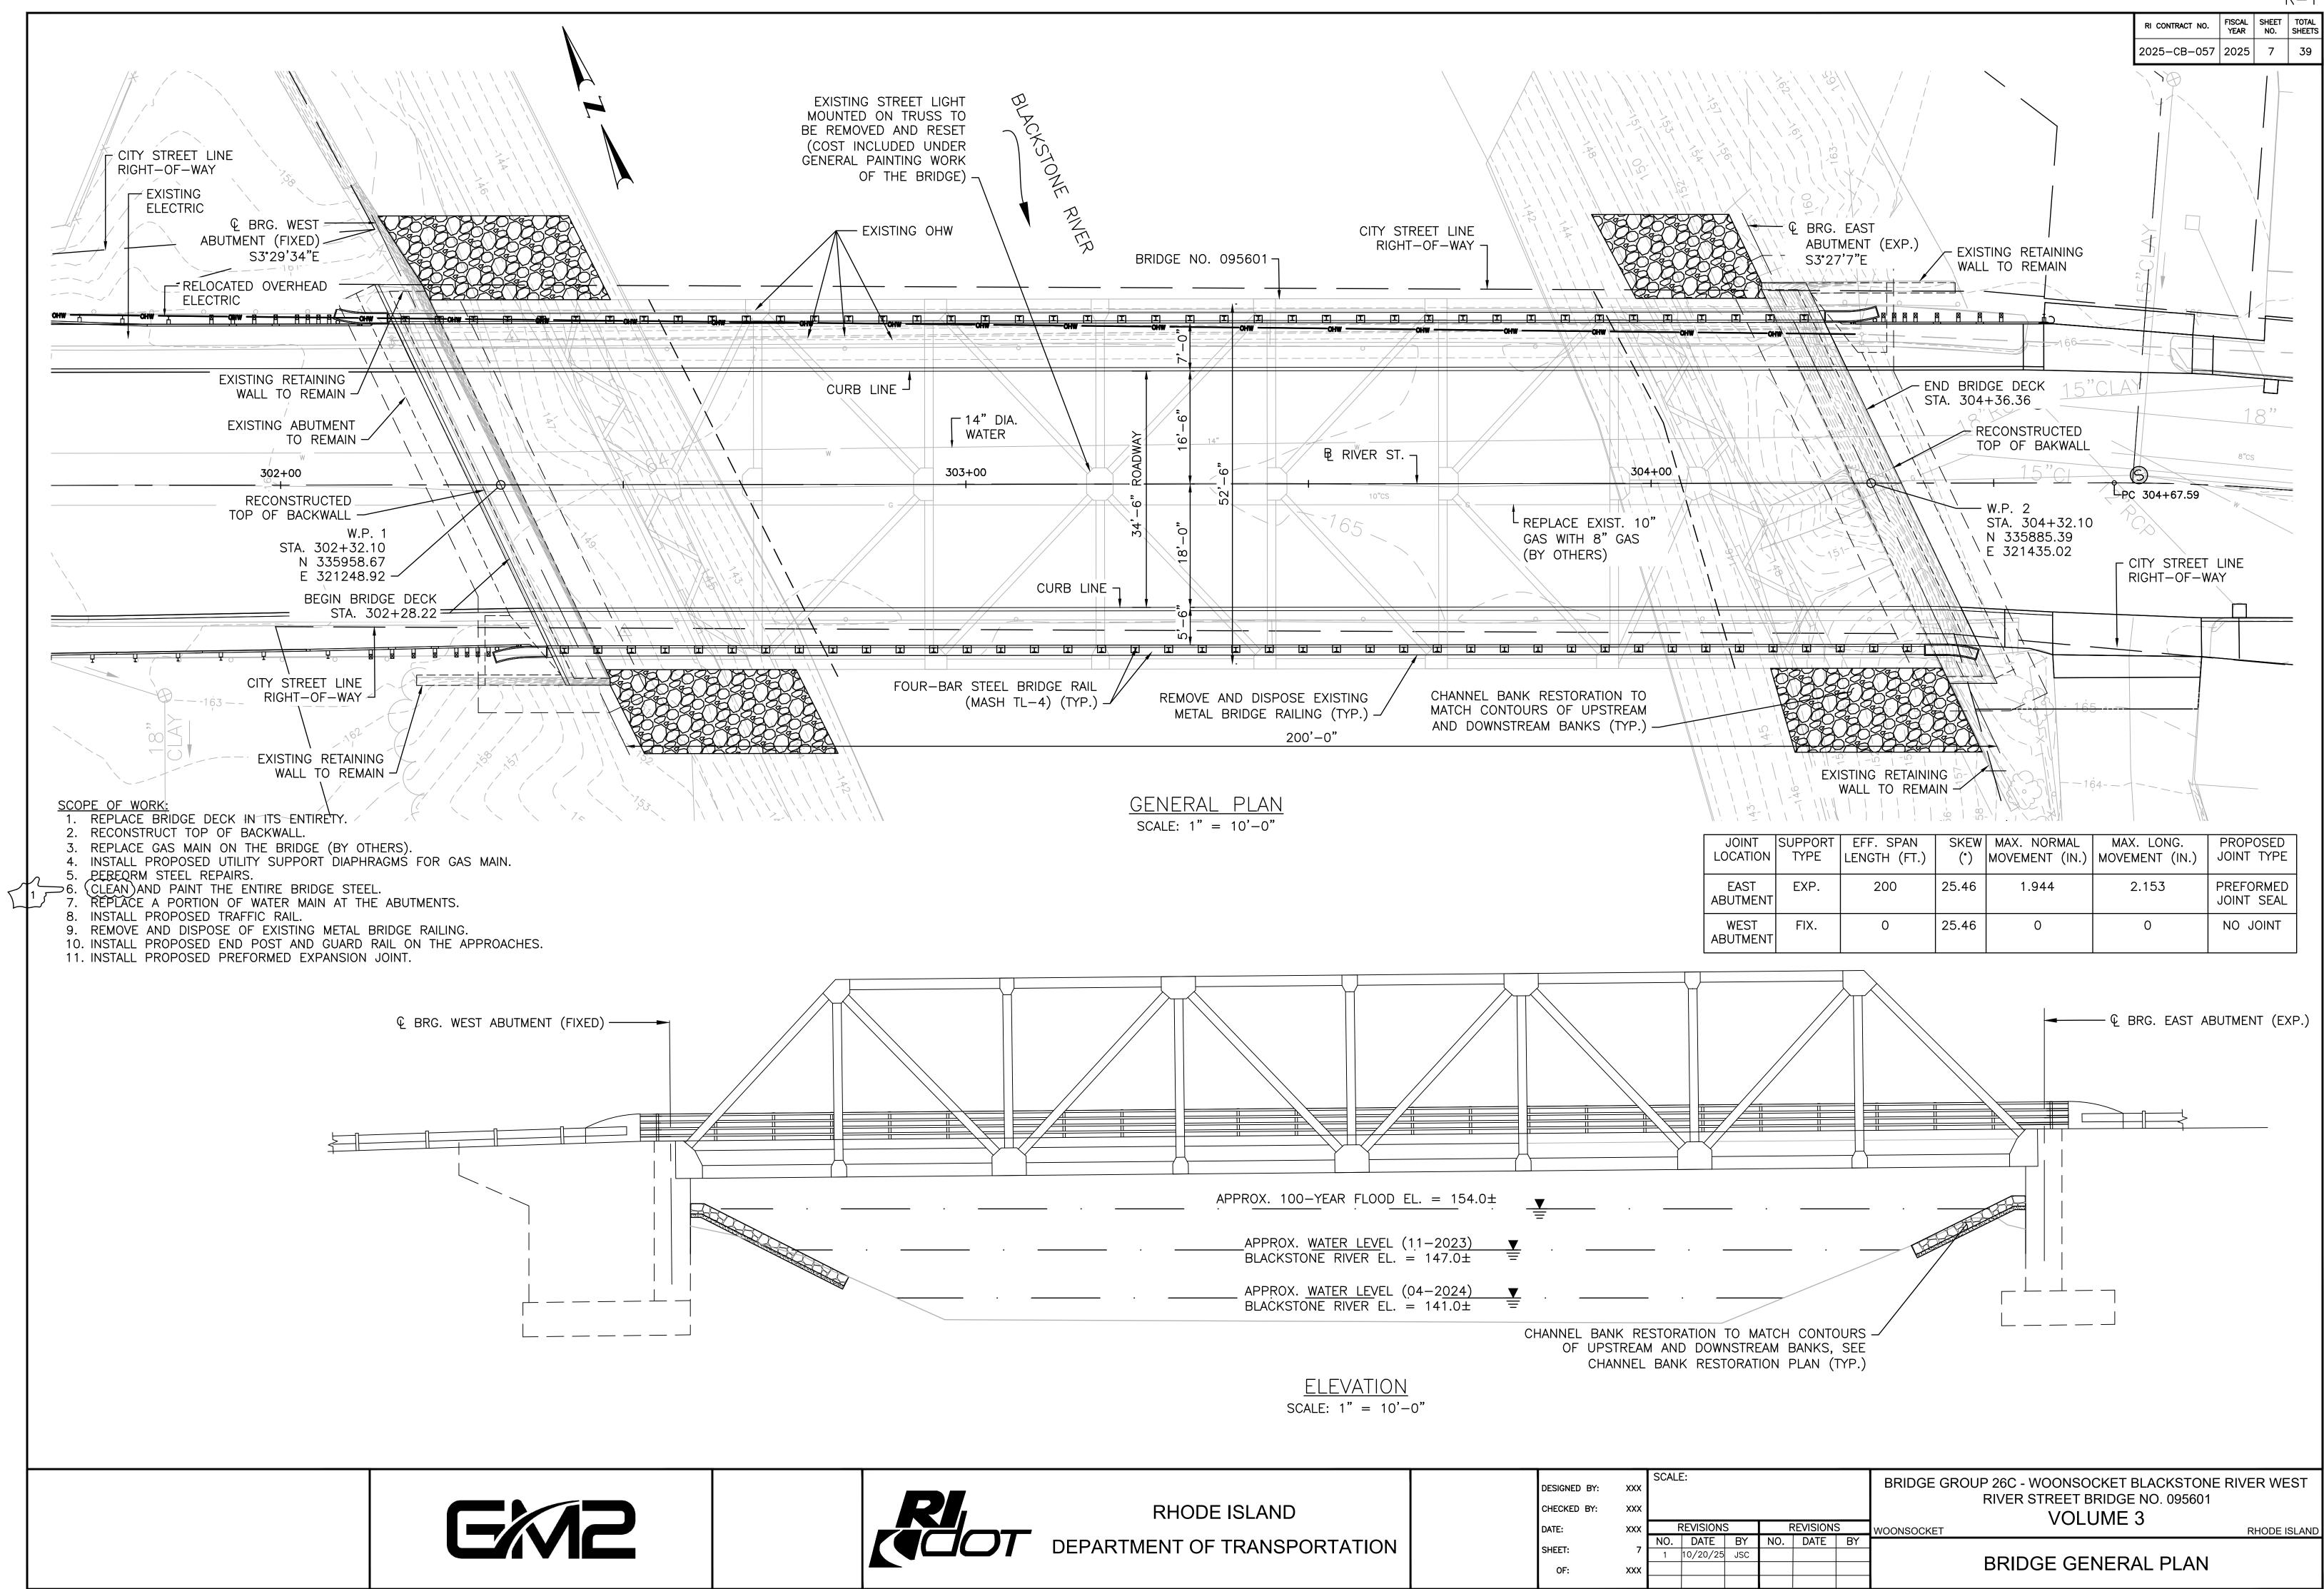
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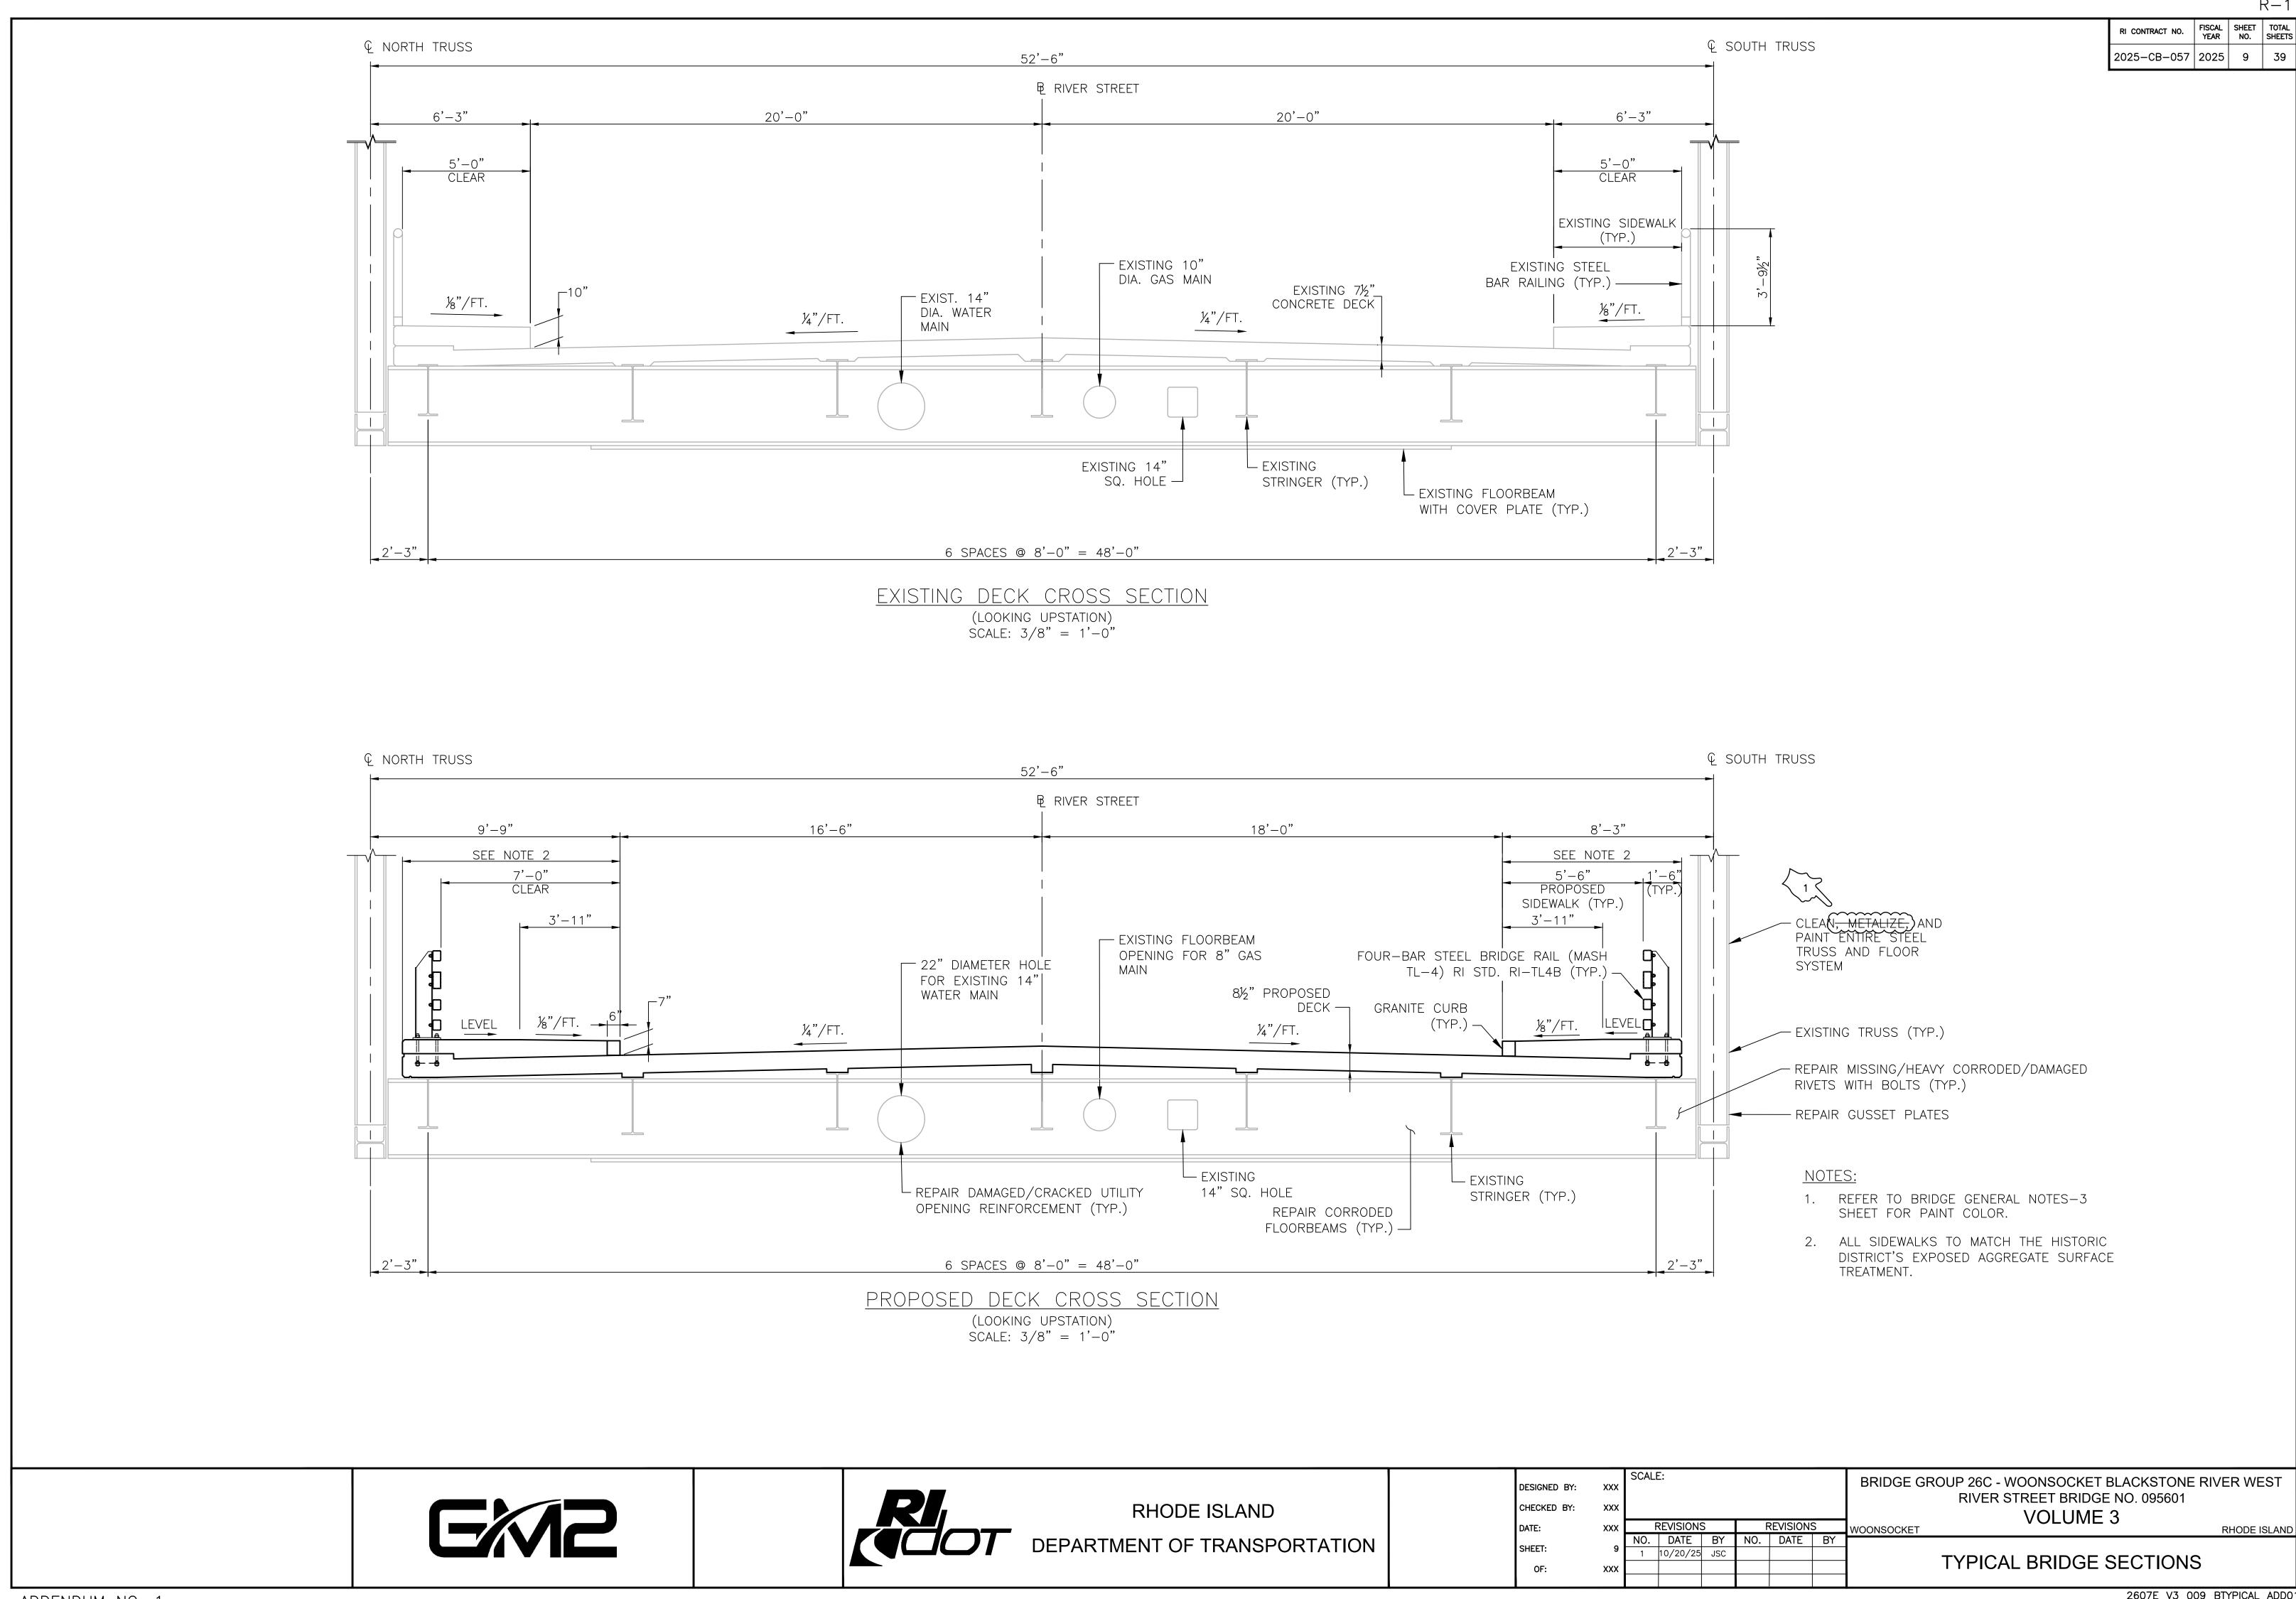
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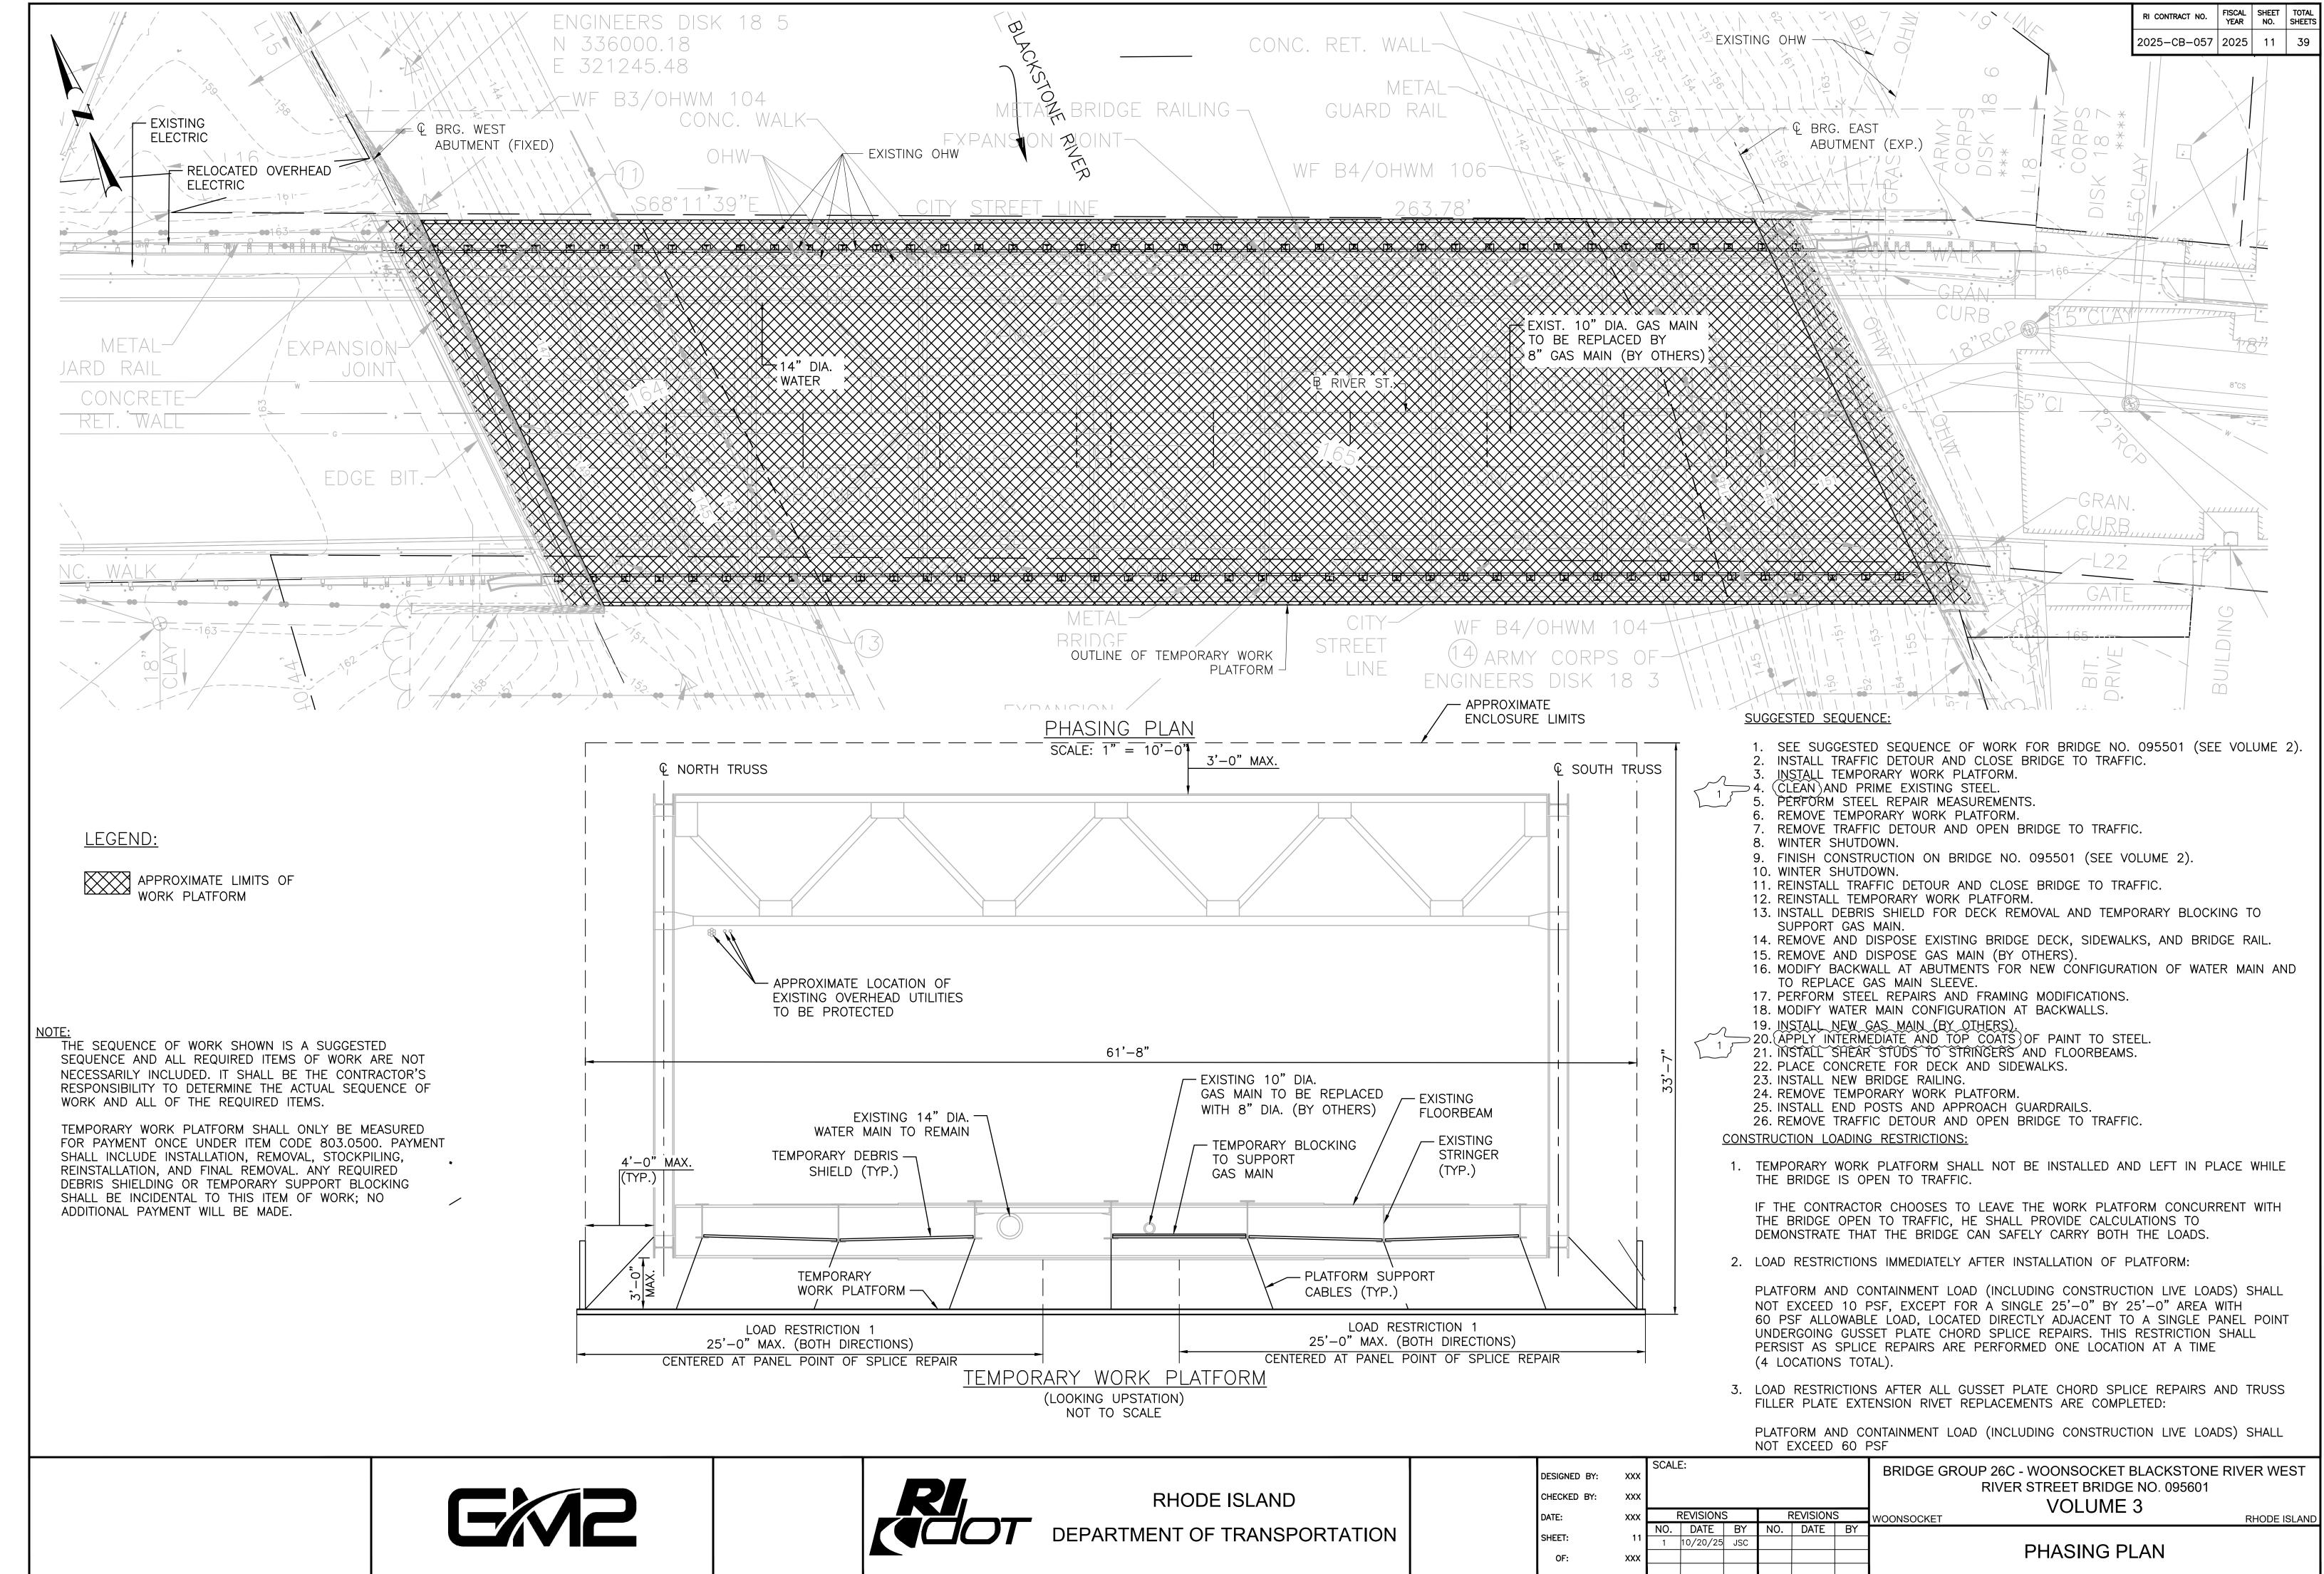
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BRIDGE GROUP 26C - WOONSOCKET BLACKSTONE RIVER WEST RIVER STREET BRIDGE NO. 095601 **VOLUME 3** VOONSOCKET RHODE ISLAND

BRIDGE GENERAL NOTES - 3

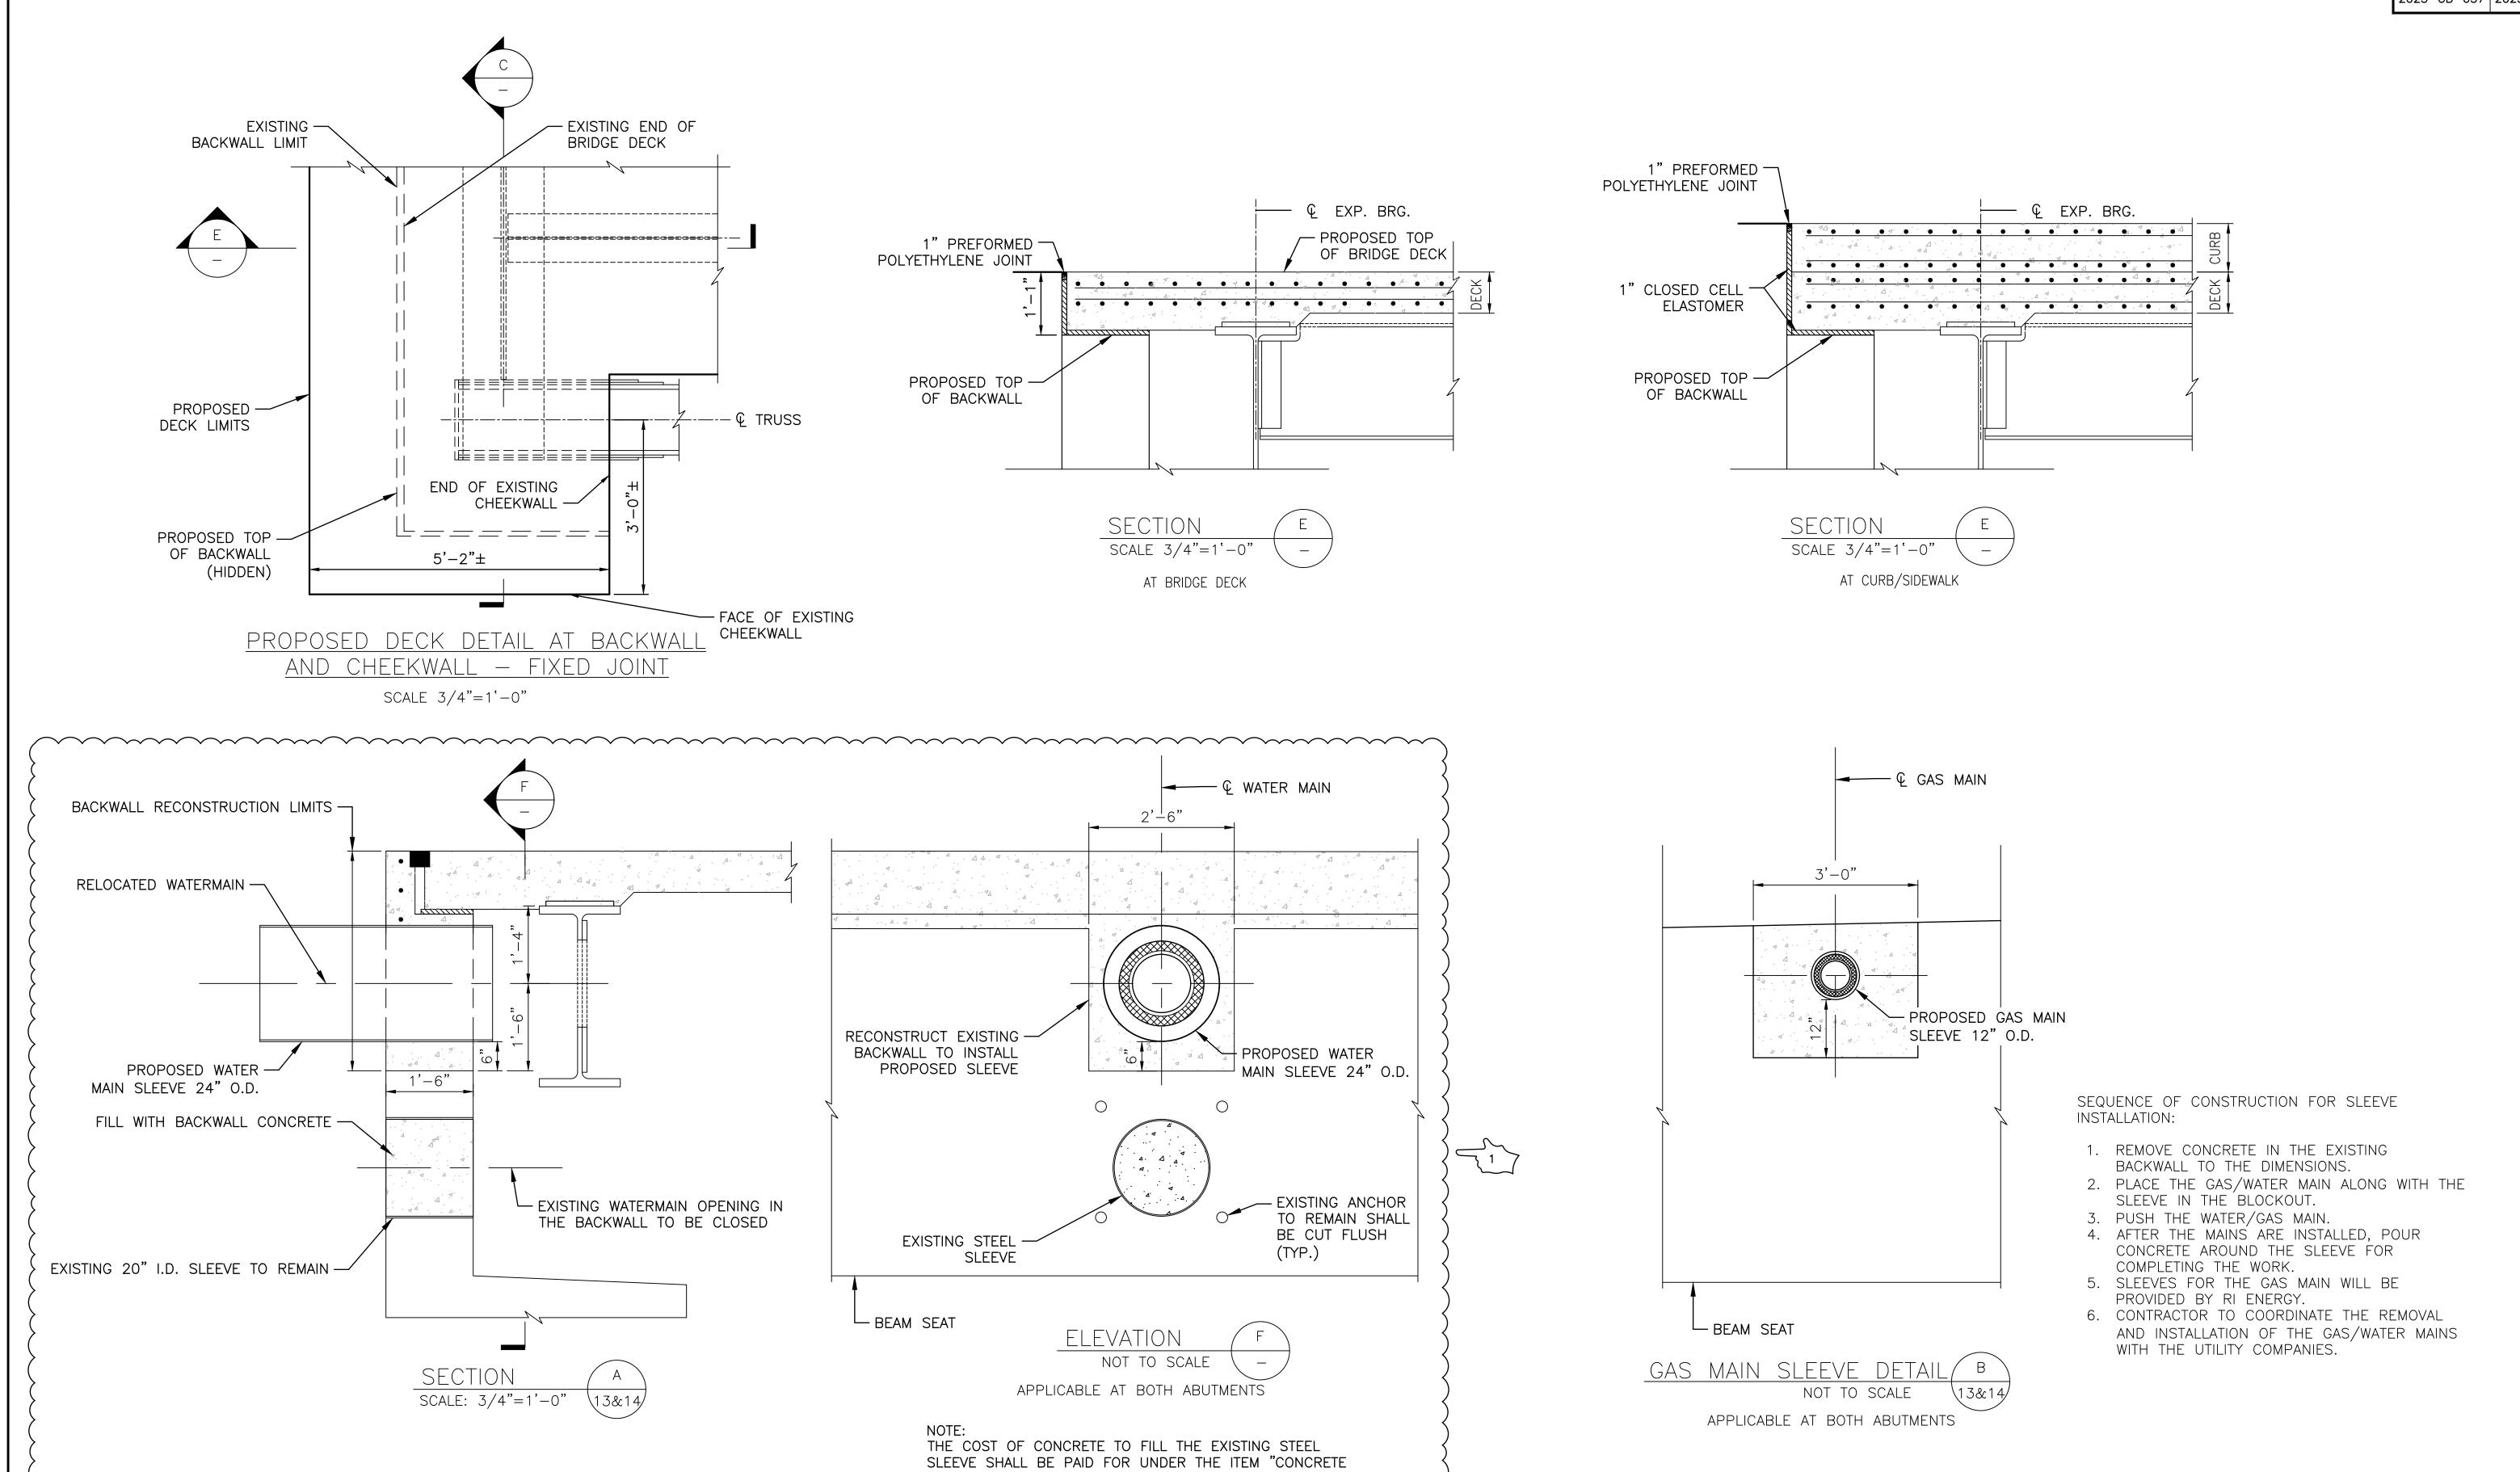






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SUBSTRUCTURE CLASS HP 3" BACKWALLS".

RHODE ISLAND
DEPARTMENT OF TRANSPORTATION

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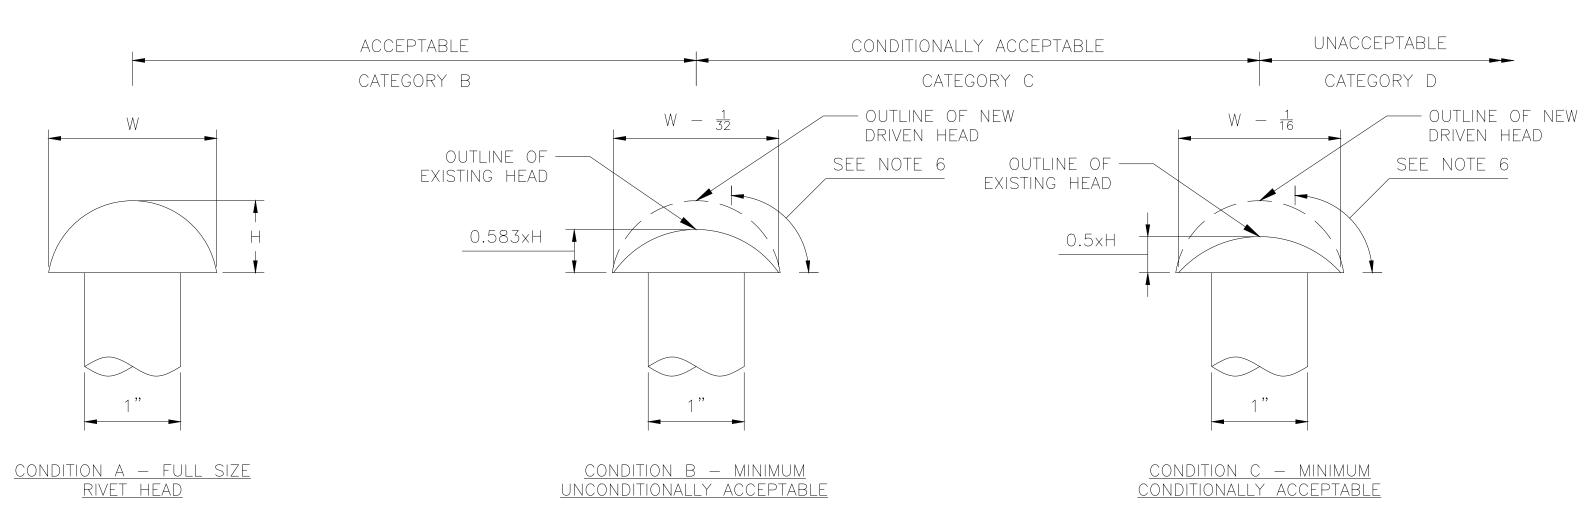
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BACKWALL AND CHEEKWALL MODIFICATION DETAILS - 2

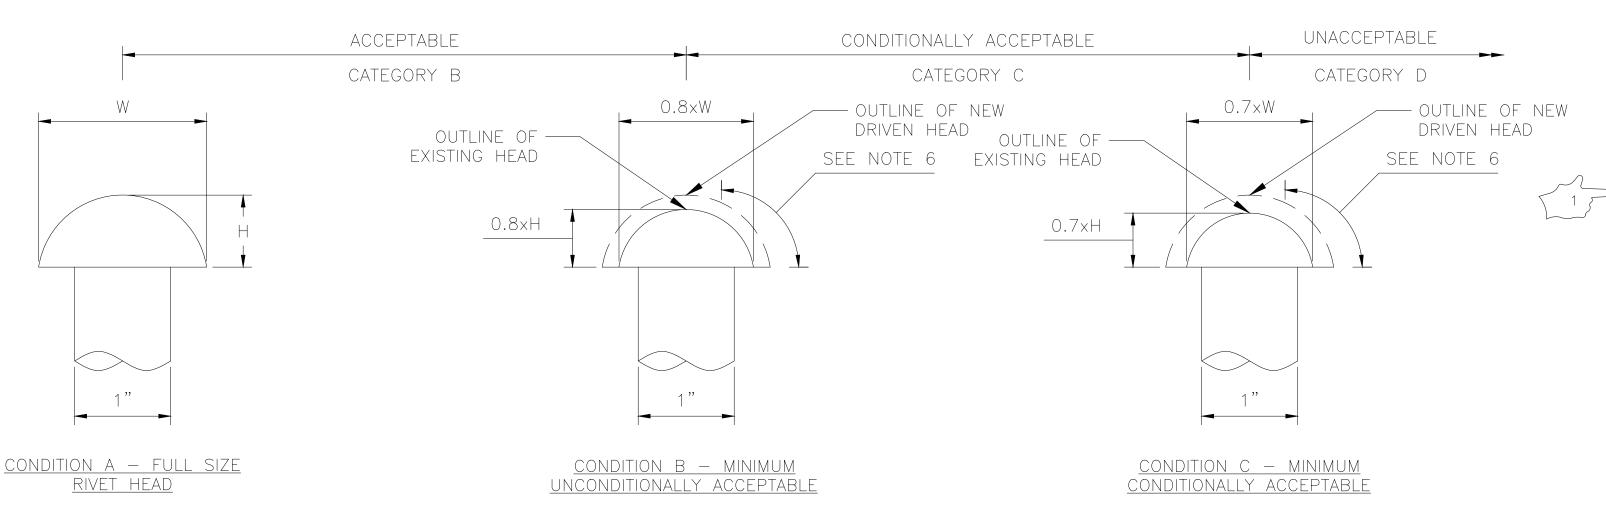
RHODE ISLAND

RI CONTRACT NO. FISCAL SHEET TOTAL SHEETS

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RIVET REPLACEMENT CRITERIA FOR DETERIORATION IN HEAD CROWN SCALE: 1'=1'-0"



RIVET REPLACEMENT CRITERIA FOR DETERIORATION IN OVERALL HEAD SCALE: 1'=1'-0"

RIVET REPLACEMENT NOTES

- 1. REMOVAL OF RIVETS FOR THE PURPOSE OF MAKING VARIOUS STRUCTURAL STEEL REPAIRS INDICATED ON THE PLANS OR AS ORDERED BY THE ENGINEER ARE NOT INCLUDED IN THE CRITERIA.
- 2. DETERIORATED RIVETS NOT COVERED UNDER NOTE 1 ABOVE WILL BE INSPECTED BY THE ENGINEER, WHO WILL ORDER THAT SPECIFIC RIVETS BE REPLACED WITH HIGH STRENGTH BOLTS IN ACCORDANCE WITH FOLLOWING GUIDELINES.
- 3. RIVETS (CONDITION B) WITH DIMENSIONS OF BOTH HEADS MEETING OR SURPASSING EACH OF THE MINIMUM DIMENSIONS SHOWN FOR CONDITION B MAY BE LEFT IN PLACE SUBJECT TO CONDITIONS DESCRIBED IN NOTE 6.
- 4. RIVETS (CONDITION C) NOT MEETING THE REQUIREMENTS OF CONDITION B, BUT HAVING DIMENSIONS WHICH MEET OR SURPASS AT BOTH HEADS EACH OF THE MINIMUM REQUIREMENTS SHOWN FOR CONDITION C MAY BE LEFT IN PLACE SUBJECT TO THE FOLLOWING CONDITIONS:
 - A) THERE IS NO PRYING ACTION FROM APPLIED STRESS WHICH TENDS TO SEPARATE THE CONNECTED PARTS.
 - B) RIVETS HEADS DO NOT HAVE ADDITIONAL LOSSES DESCRIBED IN NOTE 6.
 - C) RIVETS MAY BE LEFT IN PLACE TO THE EXTENT THAT THEIR NUMBER DOES NOT EXCEED 15% OF CONNECTION RIVETS IN ANY ONE CONNECTION OR 40% OF STITCH RIVETS.
 - D) WHERE THE ABOVE PERCENTAGES ARE EXCEEDED THE NUMBER OF RIVETS OVER THE PRESCRIBED PERCENTAGE SHALL BE REPLACED WITH HIGH STRENGTH BOLTS.
 - E) WHEN SELECTING RIVETS FOR REPLACEMENT TO MEET THE ABOVE PERCENTAGE REQUIREMENTS, THE WORST RIVETS IN ANY GROUP OR CONNECTION SHALL BE SELECTED FOR REPLACEMENT.
- 5. RIVETS (CONDITION D) NOT MEETING THE REQUIREMENTS OF CONDITION C AT EITHER HEAD SHALL BE REPLACED (CONDITION D NOT SHOWN).
- 6. REPLACEMENT WILL ALSO BE REQUIRED FOR ANY RIVET EXHIBITING ADDITIONAL LOSS IN THE FORM OF PITS OR GOUGES
 OF THE EDGE OF EITHER HEAD PROJECTING BEYOND THE SHANK WHERE SUCH LOSS REDUCES THE SECTION BELOW THE
- 7. RIVETS REPLACED IN ACCORDANCE WITH NOTES 2 THROUGH 6 WILL BE PAID FOR UNDER THE ITEM "REPLACE REMOVED OR —— MISSING RIVETS AND BOLTS WITH HIGH STRENGTH BOLTS". "RIVET REPLACEMENT".
- 8. DIMENSIONS SHOWN ON THESE DETAILS FOR CONDITION B AND C ARE MINIMUM REQUIREMENTS FOR BOTH DRIVEN AND MANUFACTURED HEADS. THE MINIMUM HEIGHT OF A RIVET HEAD IS MEASURED TO THE CENTER OF THE RIVET. THE MINIMUM DIAMETER APPLIES TO THAT DIRECTION IN WHICH IT IS THE SMALLEST.
- 9. THE SELECTION AND INSTALLATION OF BOLTS SHALL BE IN ACCORDANCE WITH THE SPECIFICATIONS. FOR EACH BOLT IN THESE ITEMS, A MINIMUM OF TWO WASHERS SHALL BE USED, ONE UNDER EACH HEAD AND NUT. THE CONTRACTOR SHALL TAKE ALL NECESSARY FIELD MEASUREMENTS TO DETERMINE PROPER GRIP LENGTHS.
- 10. ONLY ONE RIVET SHALL BE REPLACED AT A TIME WITHIN A REPAIR LOCATION.
- 11. THE NEW BOLTS TO BE INSTALLED SHALL BE 7/8" DIA. AT THE APPROACH SPANS AND 1" DIA. AT THE RIVER SPAN, ASTM F3125, TYPE 1 HIGH STRENGTH BOLTS WITH NUT AND WASHER.



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DEPARTMENT OF TRANSPORTATION

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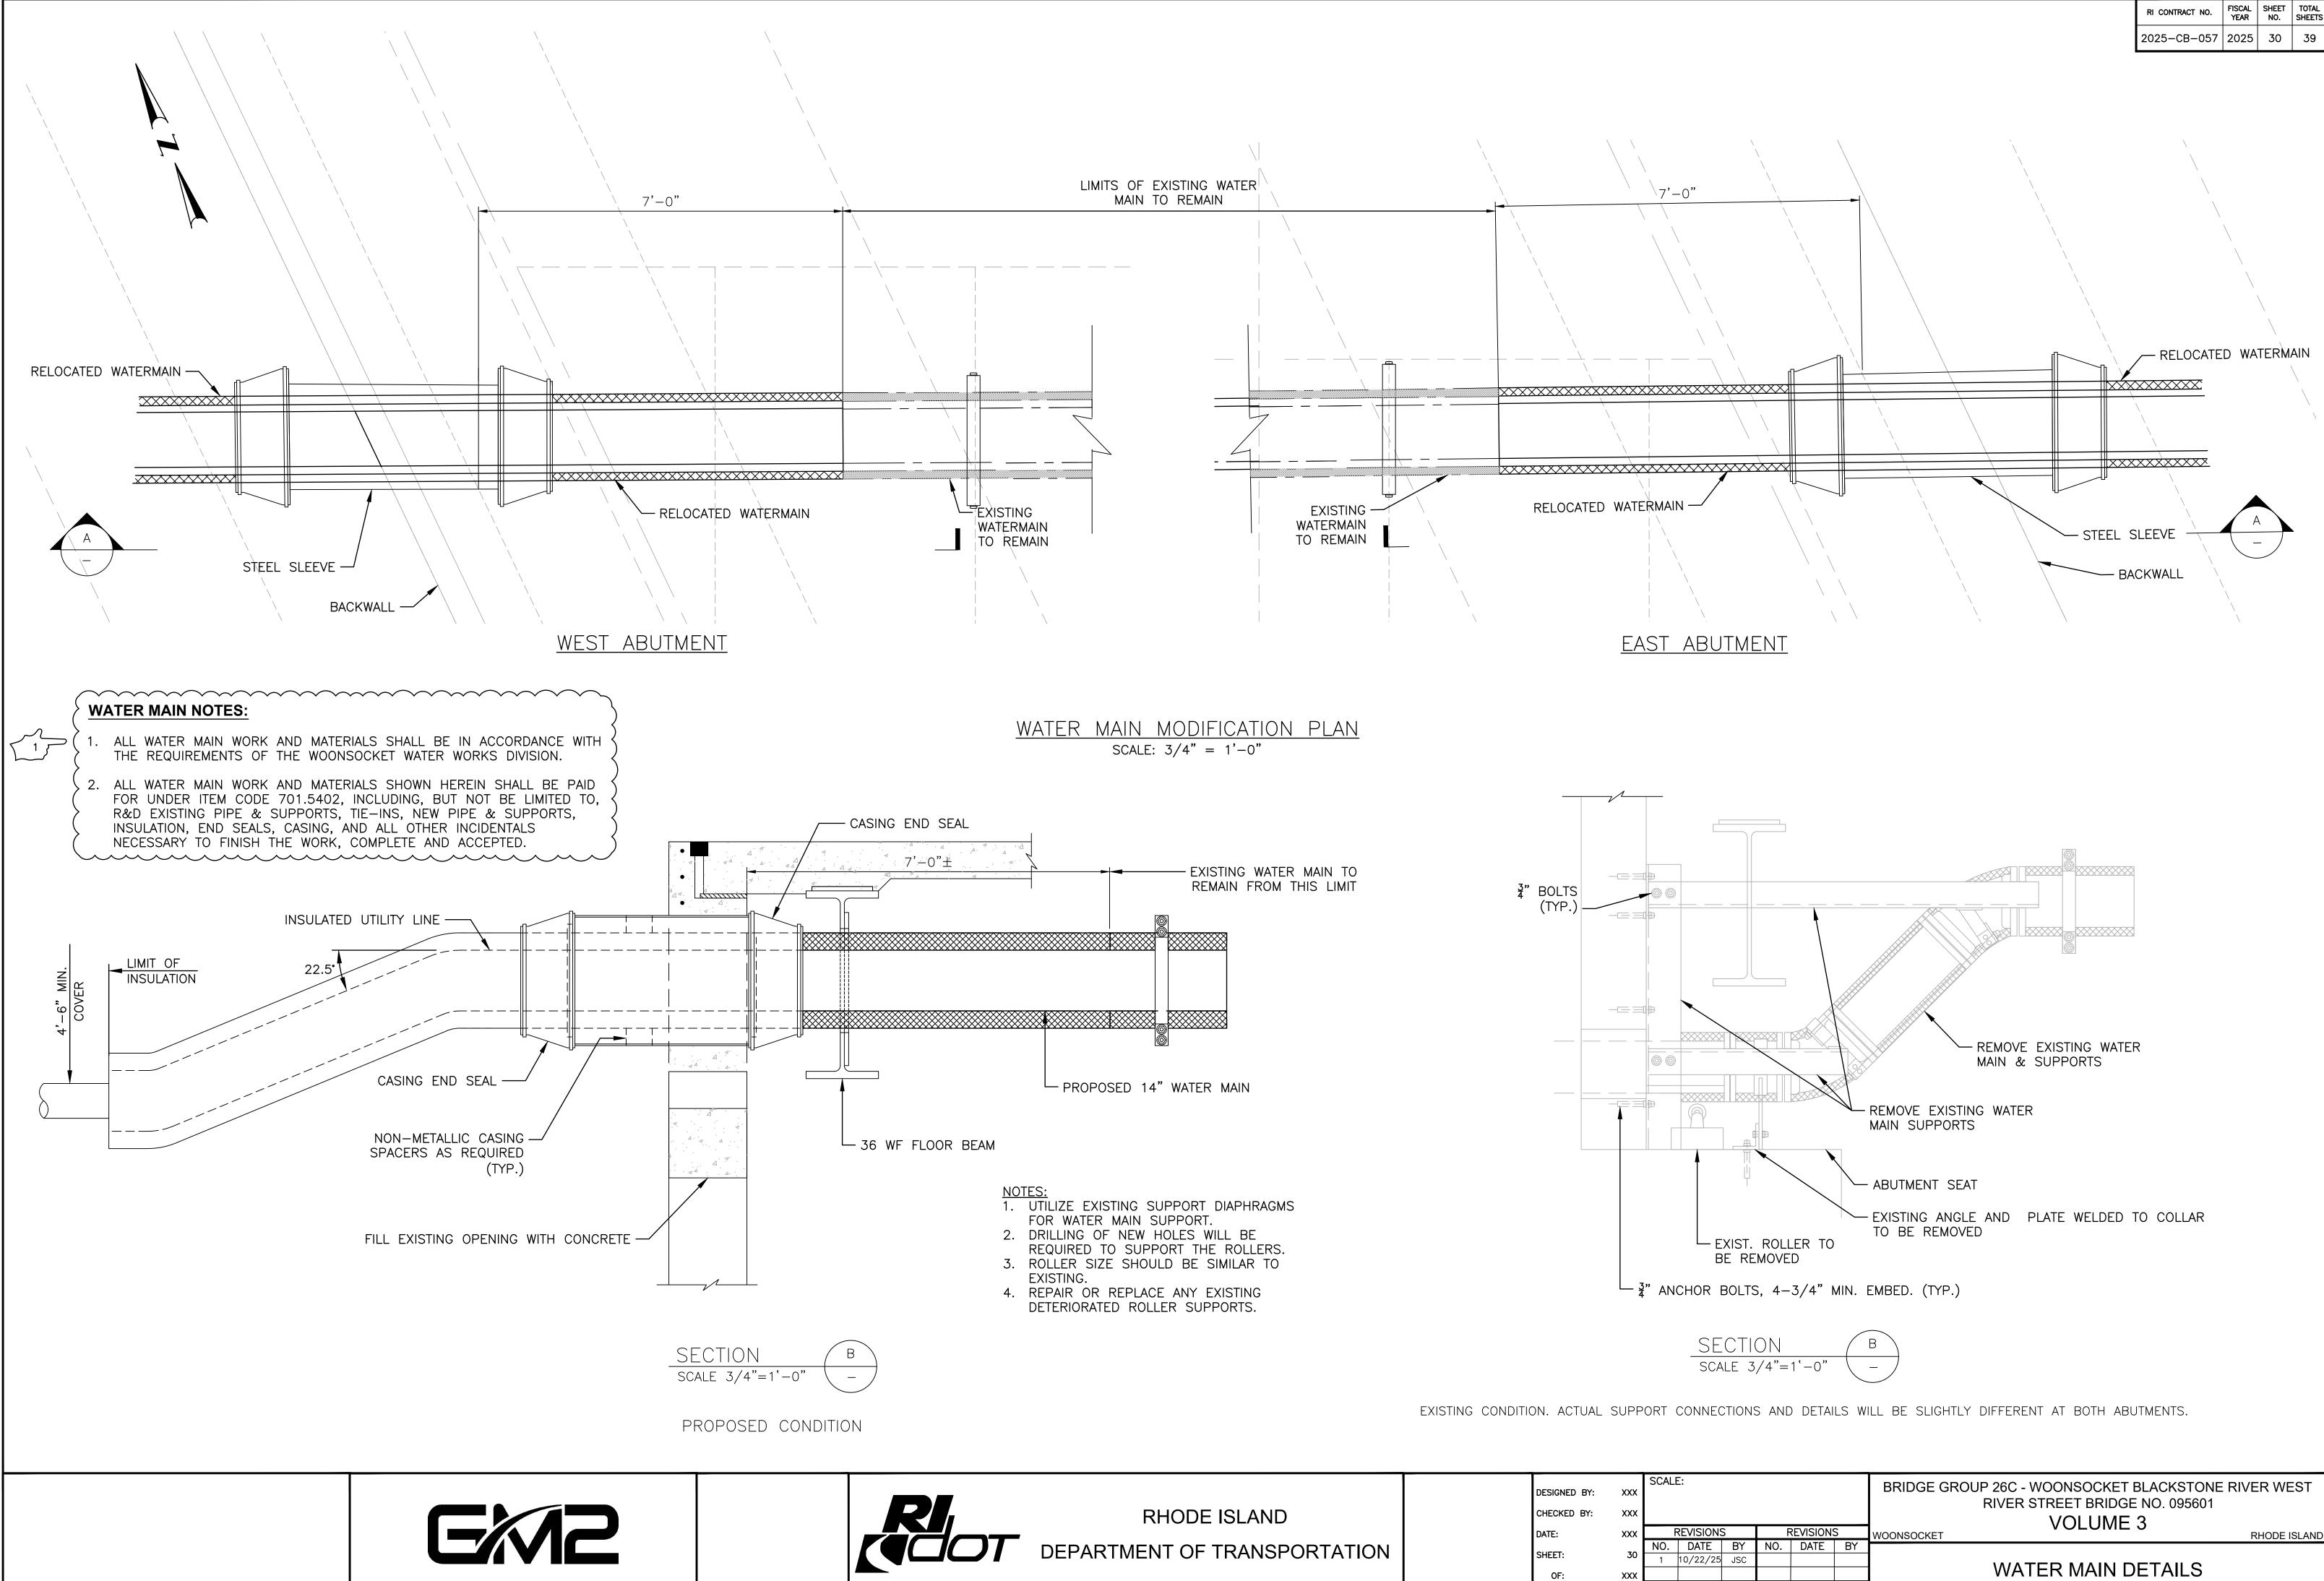
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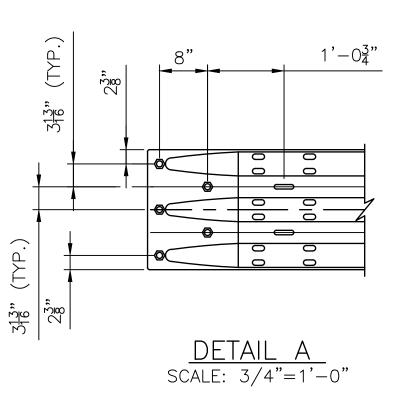
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RIVER STREET BRIDGE NO. 095601
VOLUME 3
RHODE ISLAND

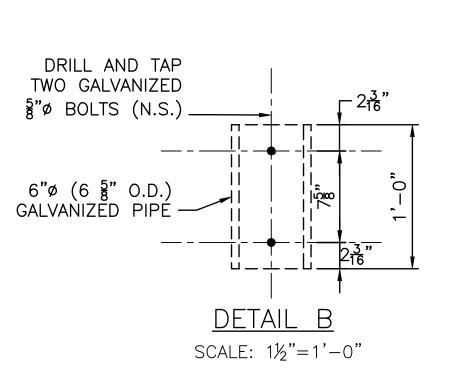
STEEL REPAIR DETAILS - 1

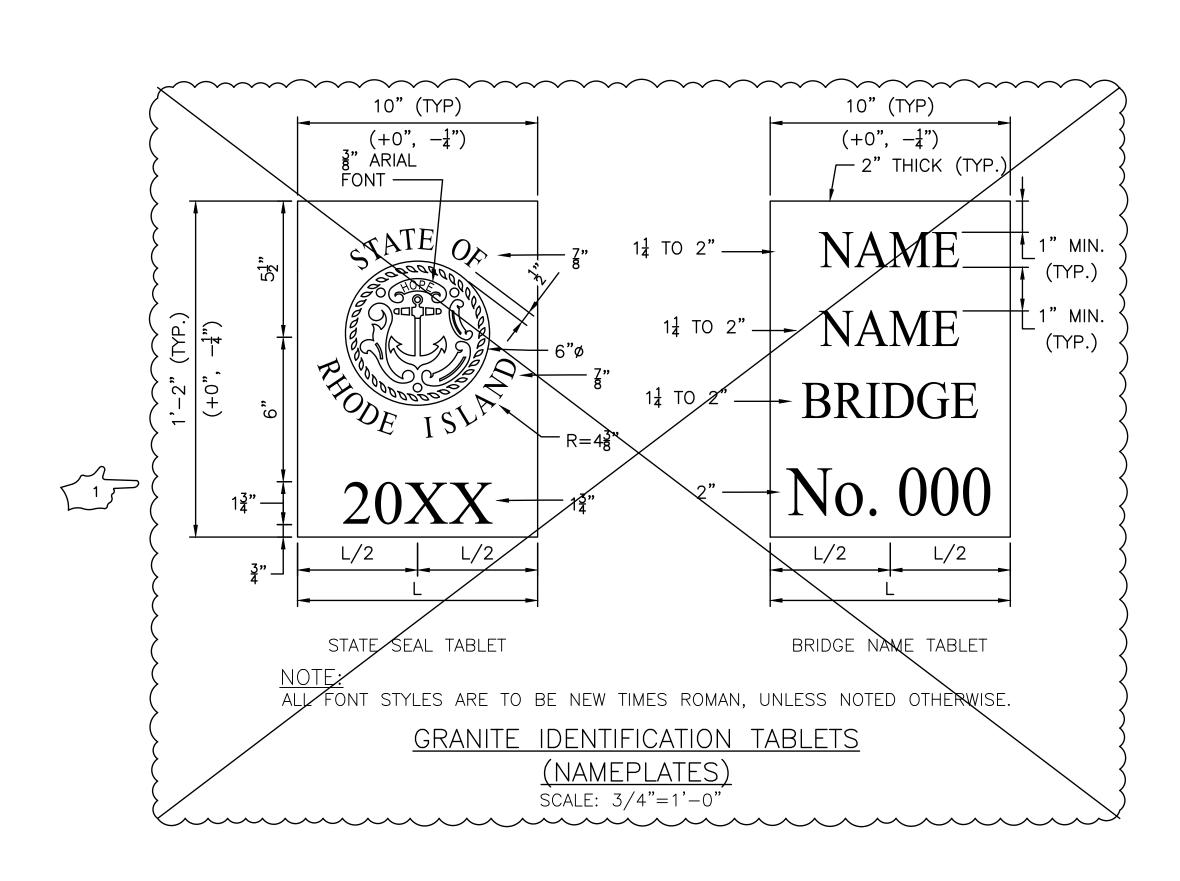


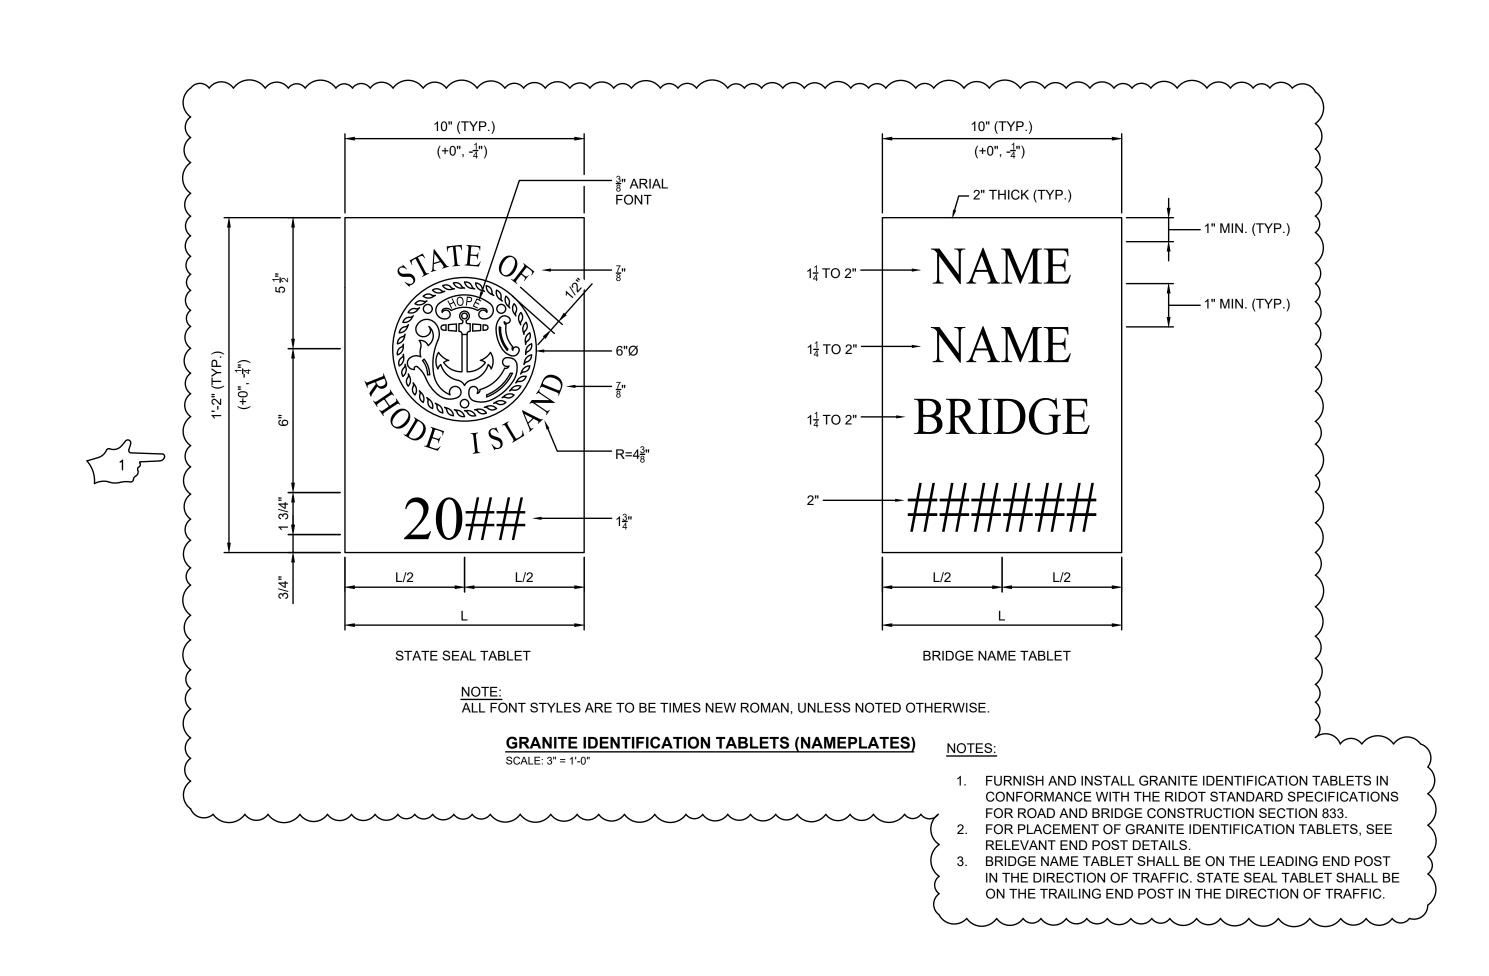
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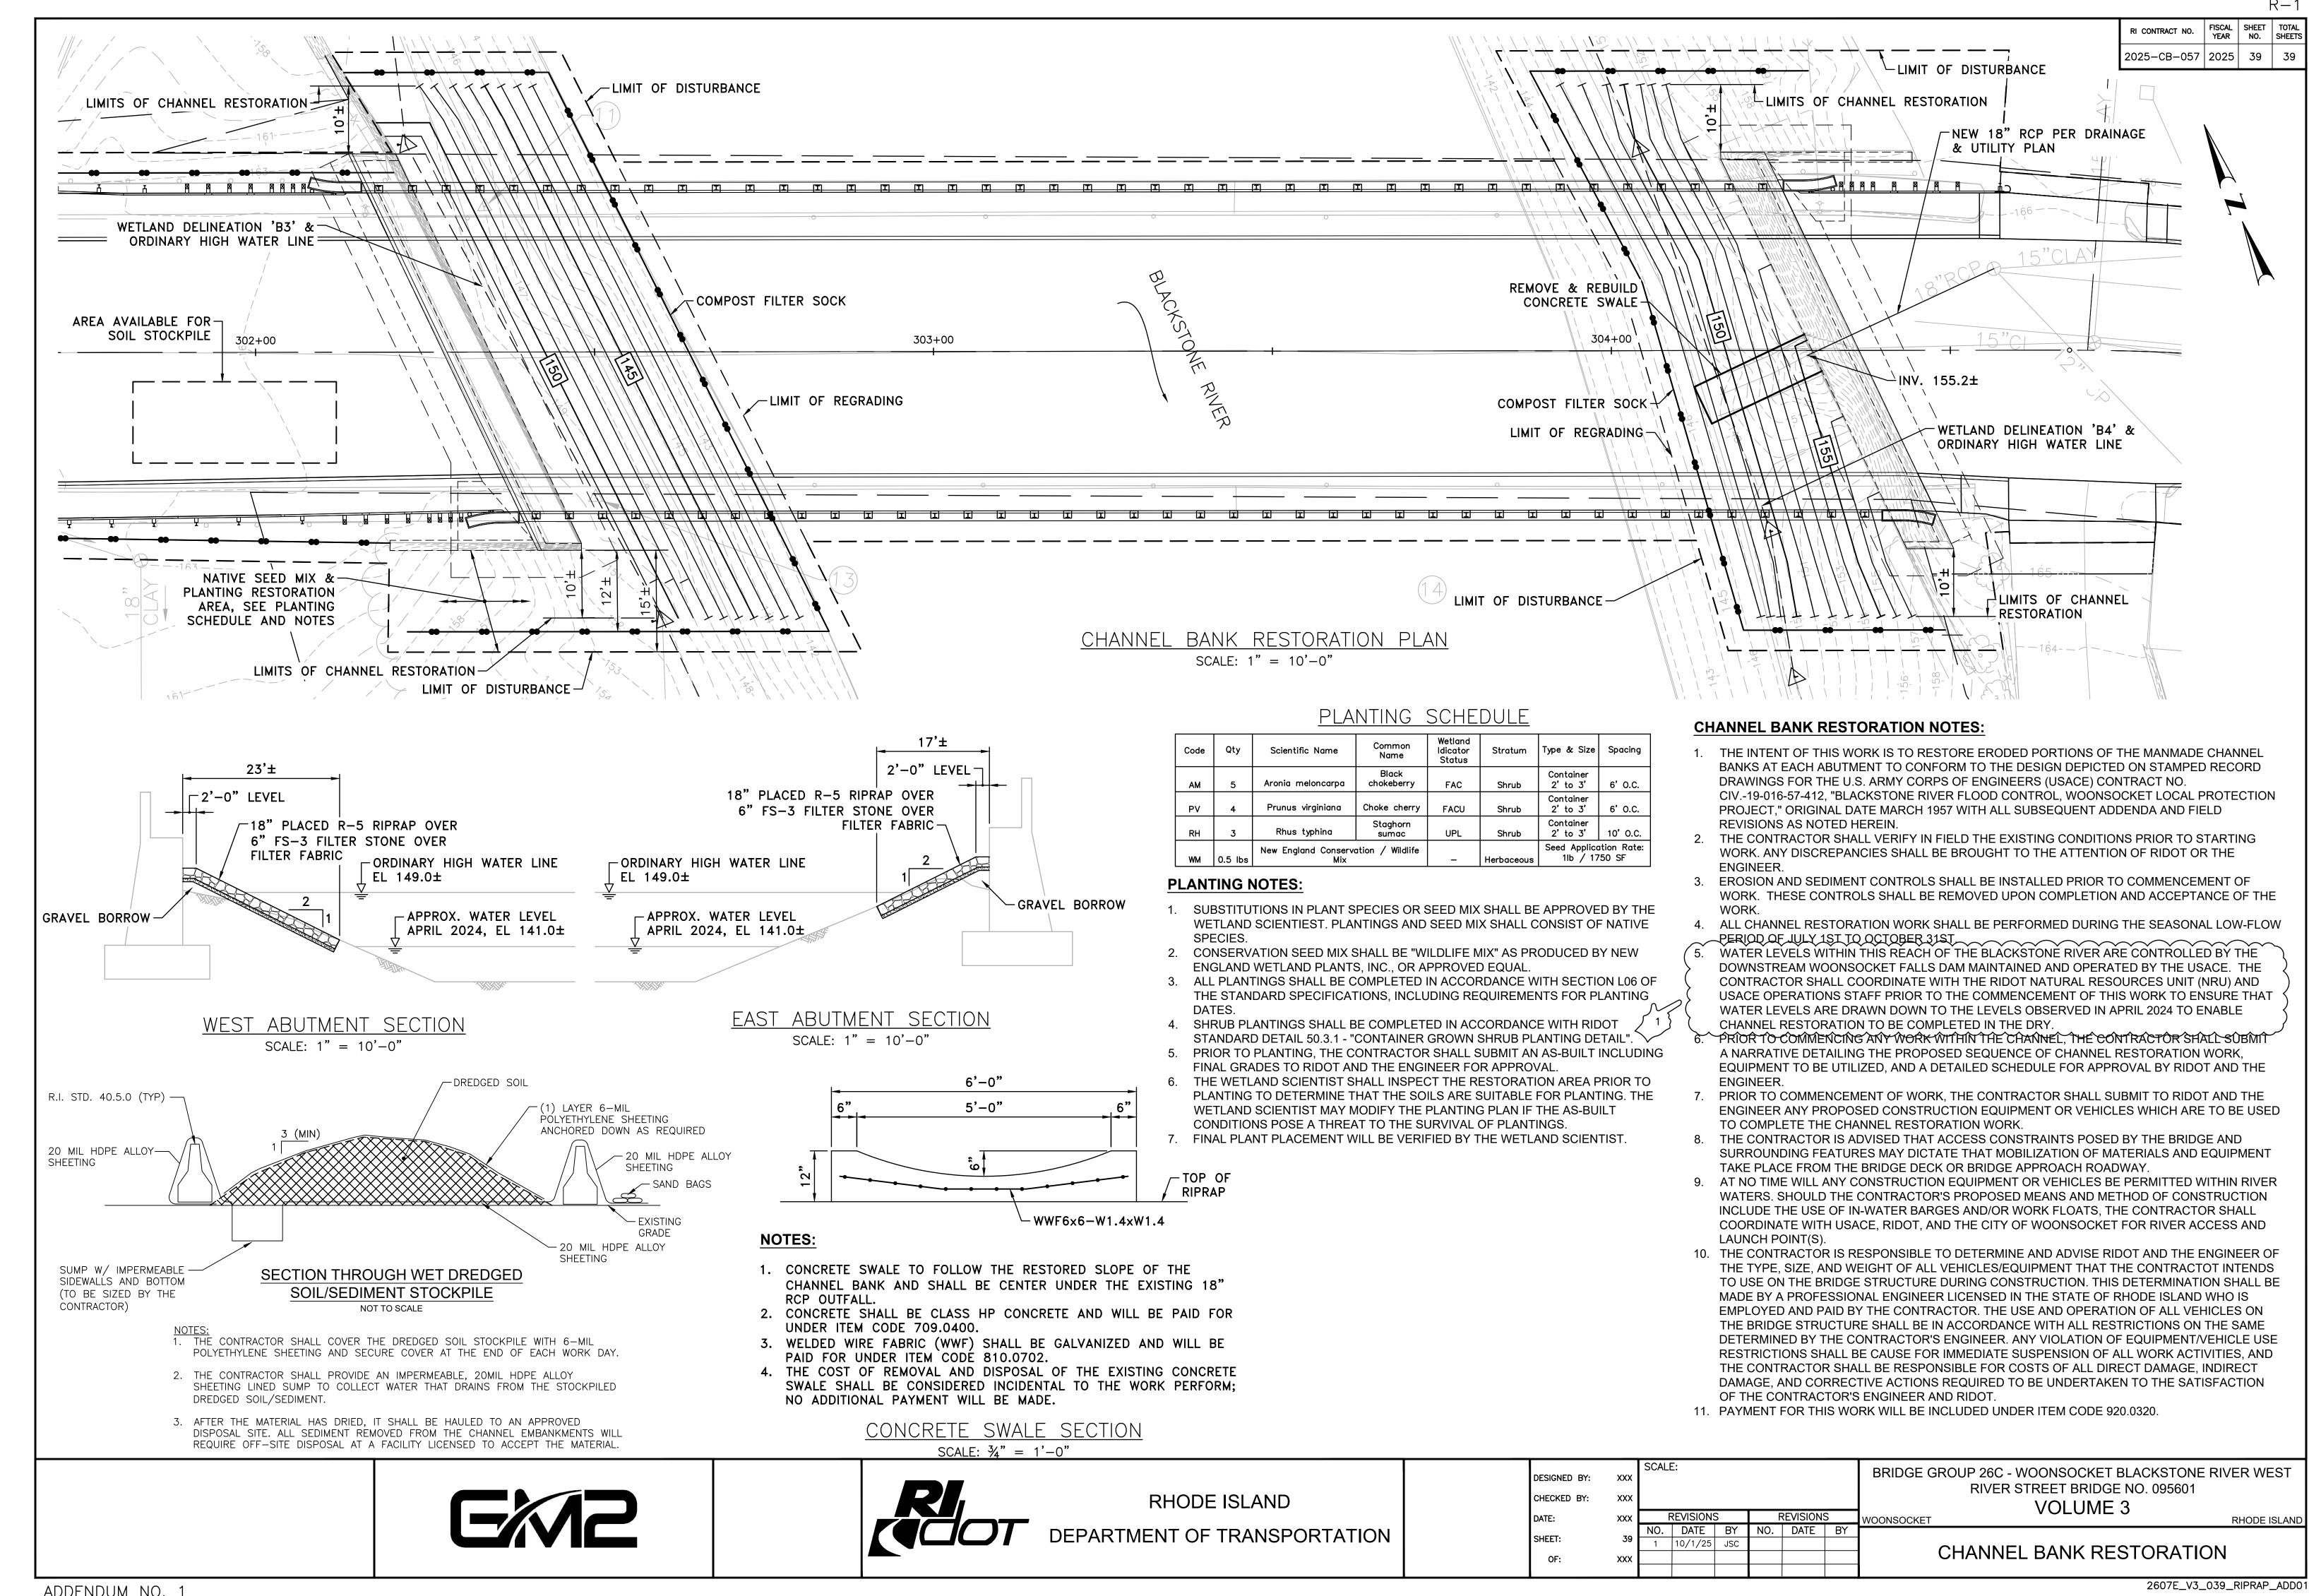




RHODE ISLAND
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BRIDGE GROUP 26C - WOONSOCKET BLACKSTONE RIVER WEST
RIVER STREET BRIDGE NO. 095601
VOLUME 3
WOONSOCKET RHODE ISLAND

MISCELANEOUS DETAILS



Date:10/22/2025



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SINGLETON & RIVER STREET RECONSTRUCTION, BRIDGE GROUP 26C

R.I. Contract No. 2025-CB-057 FAP No. BHO-026C(001)

| Item | Item Code | Description | UM | Quantity | Page |
|------|-----------|---|------|----------|------|
| 1 | 201.0321 | CLEARING AND GRUBBING | SY | 650 | 1 |
| 2 | 201.0414 | REMOVE AND DISPOSE PIPE - ALL TYPES | LF | 40 | 2 |
| 3 | 201.0415 | REMOVE AND DISPOSE GUARDRAIL AND POST ALL TYPES | LF | 500 | 3 |
| 4 | 201.0428 | REMOVE AND DISPOSE FRAME AND GRATE OR FRAME AND COVER | EACH | 4 | 4 |
| 5 | 201.0436 | REMOVAL AND DISPOSAL OF CURBING | LF | 525 | 5 |
| 6 | 201.0438 | REMOVAL AND DISPOSAL OF FENCES AND RAILINGS | LF | 60 | 6 |
| 7 | 201.0610 | REMOVE AND DISPOSE DIRECTIONAL, WARNING, REGULATORY, SERVICE, AND STREET SIGNS | EACH | 18 | 7 |
| 8 | 202.0100 | EARTH EXCAVATION | CY | 600 | 8 |
| 9 | 202.0900 | HANDLE, HAUL, AND STOCKPILE MANAGEMENT OF CONTAMINATED SOILS AND UNCLASSIFIED SOILS | TON | 1050 | 9 |
| 10 | 202.0920 | LOAD AND HAUL CONTAMINATED SOIL, TYPE 2 | TON | 425 | 10 |
| 11 | 202.0921 | DISPOSAL OF CONTAMINATED SOIL, TYPE 2 | TON | 425 | 11 |
| 12 | 202.0930 | LOAD AND HAUL CONTAMINATED SOIL, TYPE 3 | TON | 620 | 12 |
| 13 | 202.0931 | DISPOSAL OF CONTAMINATED SOIL, TYPE 3 | TON | 620 | 13 |
| 14 | 202.0960 | LOAD, HAUL, AND DISPOSAL OF OTHER WASTE | TON | 5 | 14 |
| 15 | 203.0100 | STRUCTURE EXCAVATION EARTH | CY | 110 | 15 |
| 16 | 206.0301 | COMPOST FILTER SOCK | LF | 1000 | 16 |
| 17 | 209.0220 | SACK INSERT INLET PROTECTION | EACH | 3 | 17 |
| 18 | 212.2200 | MAINTENANCE AND CLEANING OF EROSION, SEDIMENT, AND POLLUTION PREVENTION CONTROLS | LS | 1 | 18 |
| 19 | 213.0100 | PLACEMENT OF MILLINGS BENEATH GUARDRAIL | LF | 500 | 19 |
| 20 | 302.0100 | GRAVEL BORROW SUBBASE COURSE | CY | 600 | 20 |
| 21 | 401.0510 | HOT MIX ASPHALT PREPARATION - PARTIAL DEPTH | SV | 350 | 21 |
| 22 | 401.0520 | HOT MIX ASPHALT PREPARATION - FULL DEPTH | SY | 1475 | 22 |
| 23 | 401.1000 | CLASS 19.0 HMA | TON | 525 | 23 |
| 24 | 401.3005 | CLASS 9.5 HMA FOR MISCELLANEOUS USE | TON | 25 | 24 |
| 25 | 401.3100 | MODIFIED CLASS 9.5 HMA | TON | 200 | 25 |
| 26 | 603.1000 | CONTROLLED LOW STRENGTH MATERIAL | CY | 20 | 26 |
| 27 | 701.0300 | REINFORCED CONCRETE PIPE M 170 - ALL SIZES | LF | 60 | 27 |
| 28 | 701.5402 | DUCTILE IRON WATER PIPE, MECHANICAL JOINT - ALL SIZES | LF | 100 | 28 |
| 29 | 701.8003 | PIPE BEDDING CLASS C | CY | 40 | 29 |
| 30 | 702.0501 | FRAME AND GRATE - ALL SIZES AND TYPES | EACH | 4 | 30 |
| 31 | 702.0502 | FRAME AND COVER - ALL SIZES AND TYPES | EACH | 2 | 31 |
| 32 | 702.0529 | INLET STONE - ALL SIZES AND TYPES | EACH | 2 | 32 |
| 33 | 702.0545 | APRON STONE - ALL SIZES AND TYPES | EACH | 1 | 33 |
| 34 | 702.1000 | MANHOLE, CATCH BASIN, OR DROP INLET ASSEMBLY - (0' - 12' DEPTH) | EACH | 1 | 34 |
| 35 | 704.0500 | RECONSTRUCT DRAINAGE STRUCTURE | EACH | 3 | 35 |
| 36 | 707.0100 | ADJUST DRAINAGE OR UTILITY STRUCTURE TO GRADE | EACH | 8 | 36 |
| 37 | 708.9040 | CLEANING AND FLUSHING PIPE ALL SIZES | LF | 200 | 37 |
| 38 | 708.9044 | CLEANING AND FLUSHING VERTICAL STRUCTURE | EACH | 7 | 38 |
| 39 | 709.0400 | CONCRETE FOR THRUST BLOCKS, HEADWALLS, AND MISC PURPOSES | CY | 5 | 39 |
| 40 | 712.0300 | GATE BOX - ALL TYPES | EACH | 1 | 40 |
| 41 | 713.0100 | ADJUST CURB STOP OR UTILITY BOX TO GRADE | EACH | 7 | 41 |
| 42 | 803.0350 | REMOVAL AND DISPOSAL OF EXISTING CONCRETE MASONRY | CY | 725 | 42 |

Date:10/22/2025



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SINGLETON & RIVER STREET RECONSTRUCTION, BRIDGE GROUP 26C

R.I. Contract No. 2025-CB-057 FAP No. BHO-026C(001)

| Item | Item Code | Description | UM | Quantity | Page |
|------|-----------|---|------|----------|------|
| 43 | 803.0500 | TEMPORARY DECK UNDERSIDE AND SIDE PROTECTIVE SHIELDING | SF | 27000 | 43 |
| 44 | 808.0322 | CONCRETE SUBSTRUCTURE CLASS HP 3/4" END POSTS | CY | 75 | 44 |
| 45 | 808.0602 | CONCRETE SUBSTRUCTURE CLASS XX 3/4" BACKWALLS | CY | 10 | 45 |
| 46 | 808.9901 | LIGHTWEIGHT CONCRETE SUPERSTRUCTURE CLASS HP 3/4" BRIDGE DECKS | CY | 560 | 46 |
| 47 | 808.9902 | LIGHTWEIGHT CONCRETE SUPERSTRUCTURE CLASS HP 3/4" BRIDGE SIDEWALKS | CY | 150 | 47 |
| 48 | 808.9903 | EXPOSED AGGREGATE SURFACE TREATMENT | SF | 10750 | 48 |
| 49 | 810.0210 | GALVANIZED BAR REINFORCEMENT GRADE 60 | LBS | 160000 | 49 |
| 50 | 810.0702 | WELDED WIRE FABRIC (GALVANIZED) | SF | 1300 | 50 |
| 51 | 817.2142 | REPAIRS TO STRUCTURE CONCRETE MASONRY - FORM AND CAST IN PLACE CONCRETE | CF | 475 | 51 |
| 52 | 819.0800 | DRILL AND GROUT REINFORCING DOWELS | EACH | 125 | 52 |
| 53 | 820.0100 | CONCRETE SURFACE TREATMENT PROTECTIVE SEALER | SF | 16600 | 53 |
| 54 | 823.9901 | PREFORMED JOINT SEAL | LF | 120 | 54 |
| 55 | 824.2000 | STRUCTURAL STEEL | LBS | 16600 | 55 |
| 56 | 824.2200 | WELDED STUD SHEAR CONNECTORS | EACH | 6250 | 56 |
| 57 | 824.9901 | STRUCTURAL STEEL REPAIRS | LBS | 115000 | 57 |
| 58 | 824.9902 | RIVET REPLACEMENT | EACH | 1000 | 58 |
| 59 | 825.8040 | PAINTING EXISTING STRUCTURAL STEEL | SF | 81500 | 59 |
| 60 | 825.8050 | SURFACE PREPARATION FOR EXISTING STEEL | SF | 86000 | 60 |
| 61 | 827.8038 | THERMAL SRAYED ZINC COATING STRUCTURAL STEEL | SF | 0 | 61 |
| 62 | 830.1000 | METAL BRIDGE RAILING | LF | 850 | 62 |
| 63 | 834.0100 | GRANITE CURB FOR BRIDGES | LF | 850 | 63 |
| 64 | 836.0100 | STRUCTURAL CONCRETE CRACK REPAIR BY EPOXY-RESIN BASE ADHESIVE INJECTION | LF | 75 | 64 |
| 65 | 841.0100 | PRE AND POST CONSTRUCTION CONDITION SURVEY | LS | 1 | 65 |
| 66 | 901.1000 | STEEL BEAM GUARDRAIL | LF | 350 | 66 |
| 67 | 901.1050 | GUARDRAIL CONNECTION TO END POST | EACH | 7 | 67 |
| 68 | 901.1100 | STEEL BEAM GUARDRAIL APPROACH END TREATMENT | EACH | 3 | 68 |
| 69 | 901.1200 | GUARDRAIL END TREATMENT PLATFORM | EACH | 3 | 69 |
| 70 | 901.1300 | STEEL BEAM GUARDRAIL ANCHORAGE TRAILING END SECTIONS | EACH | 2 | 70 |
| 71 | 903.0510 | FENCE - PERMANENT ALL TYPES AND SIZES | LF | 50 | 71 |
| 72 | 904.0100 | REMOVE AND RESET FENCE AND/OR RAILING | LF | 100 | 72 |
| 73 | 905.1000 | PORTLAND CEMENT CONCRETE SIDEWALKS AND DRIVEWAYS | SY | 575 | 73 |
| 74 | 906.0310 | GRANITE CURB | LF | 520 | 74 |
| 75 | 906.0700 | REMOVE, HANDLE, HAUL TRIM RESET CURB EDGING, STRAIGHT, CIRCULAR ALL TYPES | LF | 275 | 75 |
| 76 | 919.0101 | TEST PITS | EACH | 5 | 76 |
| 77 | 920.0320 | RIPRAP R-3, R-4, R-5 STANDARD 8.3.0 | SY | 1000 | 77 |
| 78 | 929.0110 | FIELD OFFICE | PMO | 42 | 78 |
| 79 | 936.0110 | MOBILIZATION | LS | 1 | 79 |
| 80 | 937.0100 | FURNISH, INSTALL, MAINTAIN, AND MOVE TEMPORARY TRAFFIC PROTECTION | LS | 1 | 80 |
| 81 | 943 .0300 | TRAINEE HOURS | HR | 2000 | 81 |
| 82 | 999.9901 | MISCELLANEOUS WORK | EACH | 75000 | 82 |
| 83 | L01.0102 | LOAM BORROW 4 INCHES DEEP | SY | 125 | 83 |
| 84 | L02.0107 | SEEDING | SY | 125 | 84 |

Date:10/22/2025



Quantity Backup Table of Contents

SINGLETON & RIVER STREET RECONSTRUCTION, BRIDGE GROUP 26C

R.I. Contract No. 2025-CB-057 FAP No. BHO-026C(001)

| Item | Item Code | Description | UM | Quantity | Page |
|------|-----------|---|------|----------|------|
| 85 | L06.9901 | ARONIA MELONCARPA - BLACK CHOKEBERRY | EACH | 5 | 85 |
| 86 | L06.9902 | PRUNUS VIRGINIANA - CHOKE CHERRY | EACH | 4 | 86 |
| 87 | L06.9903 | RHUS TYPHINA - STAGHORN SUMAC | EACH | 3 | 87 |
| 88 | L06.9904 | NEW ENGLAND CONSERVATION - WILDLIFE SEED MIX | SY | 100 | 88 |
| 89 | T15.0100 | DIRECTIONAL REGULATORY AND WARNING SIGNS | SF | 85 | 89 |
| 90 | T15.0200 | REMOVE AND RELOCATE DIRECTIONAL REGULATORY AND WARNING SIGN | EACH | 2 | 90 |
| 91 | T20.0101 | PAVEMENT MARKINGS | LF | 2000 | 91 |
| 92 | T20.0102 | TEMPORARY PAVEMENT MARKINGS | LS | 1 | 92 |
| 93 | T20.0103 | ARROWS, WORDS, OR SYMBOLS PAVEMENT MARKINGS | EACH | 5 | 93 |
| 94 | 401.0510 | HOT MIX ASPHALT PREPARATION - PARTIAL DEPTH | SY | 350 | 21 |
| 95 | 833.0400 | GRANITE IDENTIFICATION TABLET | EACH | 8 | 94 |
| 96 | 202.0800 | GRAVEL BORROW | CY | 125 | 95 |



ITEM CODE:

| Project: | Singleton & River St. Reconstruction, Bridge Group 26C | Estimator | Date |
|-----------|--|-----------|------------|
| RICN | 2025-CB-057 | JSC | 9/24/2025 |
| PTS ID | 2607E | Rev. | Date |
| OSP ID | TCB26005787 | JSC | 10/13/2025 |
| Office ID | 41110.06 | | |
| | DISTRIBUTION OF QUANTITIES | | |
| | | Sheet | 43 |

803.0500 TEMPORARY DECK UNDERSIDE AND SIDE PROTECTIVE SHIELDING

| | | | UM: | SF |
|--------------|-----------------|-----------|--------------|----|
| PROJECT WIDE | <u>Location</u> | <u>SF</u> | <u>TOTAL</u> | |
| | | | | |
| | Bridge 095501 | 12500 | 12500 | |
| | Bridge 095601 | 13250 | 13250 | |

As Directed by Engineer

1250

TOTAL 27000 SF



| | | | (R-1) |
|-----------|--|-----------|------------|
| Project: | Singleton & River St. Reconstruction, Bridge Group 26C | Estimator | Date ´ |
| RICN | 2025-CB-057 | JSC | 9/24/2025 |
| PTS ID | 2607E | Rev. | Date |
| OSP ID | TCB26005787 | JSC | 10/21/2025 |
| Office ID | 41110.06 | | |
| | DISTRIBUTION OF QUANTITIES | | |
| | | Sheet | 55 |

| ITEM CODE: | 824.2000 STRUCTURAL STEEL | |
|--------------|---------------------------|--------------|
| | | UM: LBS |
| PROJECT WIDE | <u>Location</u> | <u>TOTAL</u> |
| | Bridge 095501 | 7,145 |
| | Bridge 095601 | 7,945 |

As Directed by Engineer

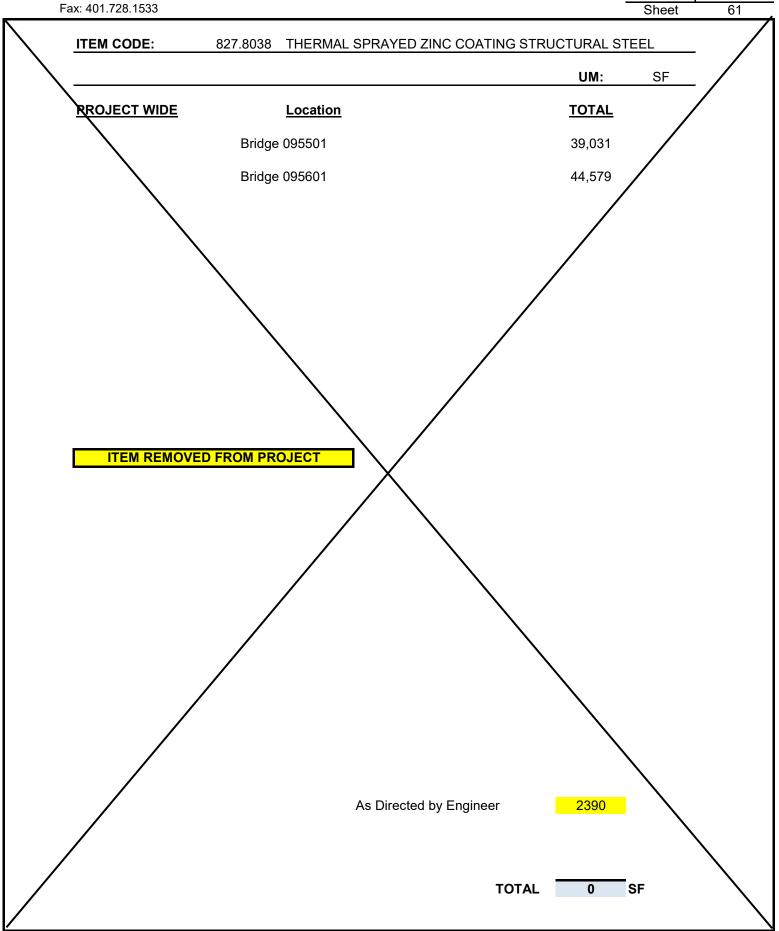
1510

TOTAL 16600 LBS



| | | | (R-1) |
|-----------|--|-----------|-------------------|
| Project: | Singleton & River St. Reconstruction, Bridge Group 26C | Estimator | Date [′] |
| RICN | 2025-CB-057 | JSC | 9/24/2025 |
| PTS ID | 2607E | Rev. | Date |
| OSP ID | TCB26005787 | | |
| Office ID | 41110.06 | | |
| | | | |

DISTRIBUTION OF QUANTITIES





| Project: | Singleton & River St. Reconstruction, Bridge Group 26C | Estimator | Date |
|-----------|--|-----------|------------|
| RICN | 2025-CB-057 | JSC | 10/13/2025 |
| PTS ID | 2607E | Rev. | Date |
| OSP ID | TCB26005787 | | |
| Office ID | 41110.06 | | |
| | | | |
| | DISTRIBUTION OF QUANTITIES | | |

| Wtdokot, 111 02000 | | | | |
|--------------------------------------|---|-------|-------|---|
| el. 401.726.4084 ax: 401.728.1533 | DISTRIBUTION OF QUANTITIES | | Sheet | (|
| ITEM CODE: | 833.0400 GRANITE IDENTIFICATION TABLET | | • | |
| | OCCUPATION OF THE PROPERTY OF | UM: | EACH | |
| DBO IECT WIDE | Location | | LAOIT | |
| PROJECT WIDE | <u>Location</u> | TOTAL | | |
| | Bridge 095501 | 4 | | |
| | Bridge 095601 | 4 | | |
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As Directed by Engineer

0

TOTAL 8 LF



| Project: | Singleton & River St. Reconstruction, Bridge Group 26C | Estimator | Date |
|----------------------------|--|-----------|------------|
| RICN | 2025-CB-057 | JSC | 10/21/2025 |
| PTS ID | 2607E | Rev. | Date |
| OSP ID | TCB26005787 | | |
| Office ID | 41110.06 | | |
| | | | |
| DISTRIBUTION OF QUANTITIES | | | |

Sheet

95

| ITEM CODE: | 202.0800 | GRAVEL BORROW | | |
|-----------------------|----------|-----------------|--------------|----|
| | | | UM: | CY |
| PROJECT WIDE Location | | <u>Location</u> | <u>TOTAL</u> | |
| | Bridge | 095501 | 55 | |
| | Bridge | 095601 | 50 | |

As Directed by Engineer

20

TOTAL

125 CY

"General Decision Number: RI20250001 10/03/2025

Superseded General Decision Number: RI20240001

State: Rhode Island

Construction Types: Building, Heavy (Heavy and Marine) and

Highway

Counties: Rhode Island Statewide.

BUILDING CONSTRUCTION PROJECTS (does not include residential construction consisting of single family homes and apartments up to and including 4 stories) HEAVY, HIGHWAY AND MARINE CONSTRUCTION PROJECTS

Note: Contracts subject to the Davis-Bacon Act are generally required to pay at least the applicable minimum wage rate required under Executive Order 14026 or Executive Order 13658. Please note that these Executive Orders apply to covered contracts entered into by the federal government that are subject to the Davis-Bacon Act itself, but do not apply to contracts subject only to the Davis-Bacon Related Acts, including those set forth at 29 CFR 5.1(a)(1).

If the contract is entered into on or after January 30, 2022, or the contract is renewed or extended (e.g., an |. The contractor must pay option is exercised) on or after January 30, 2022:

- |. Executive Order 14026 generally applies to the contract.
- all covered workers at least \$17.75 per hour (or the applicable wage rate listed on this wage determination, if it is higher) for all hours spent performing on the contract in 2025.

or between January 1, 2015 and January 29, 2022, and the contract is not renewed or extended on or after January 30, 2022:

- If the contract was awarded on . Executive Order 13658 generally applies to the contract.
 - . The contractor must pay all covered workers at least \$13.30 per hour (or the applicable wage rate listed on this wage determination, if it is higher) for all hours spent performing on that contract in 2025.

The applicable Executive Order minimum wage rate will be adjusted annually. If this contract is covered by one of the Executive Orders and a classification considered necessary for performance of work on the contract does not appear on this wage determination, the contractor must still submit a conformance request.

Additional information on contractor requirements and worker protections under the Executive Orders is available at http://www.dol.gov/whd/govcontracts.

| Modification Number | Publication Date | |
|---|--------------------------|-----------|
| 0 1 | 01/03/2025 | |
| 2 | 03/07/2025 03/14/2025 | |
| 3 | 05/16/2025 | |
| 4 5 | 06/13/2025 07/04/2025 | |
| 6 | 07/04/2025 | |
| 7 | 08/08/2025 | |
| 8 | 08/22/2025 | |
| 9 1 0 | 09/05/2025 10/03/2025 | |
| ASBE0006-006 09/01/20 | | |
| , , | Rates | Fringes |
| | | 11 Tilges |
| HAZARDOUS MATERIAL HANI (Includes preparation, | DLER | |
| wetting, stripping, re | moval | |
| scrapping, vacuuming, l | bagging | |
| & disposing of all insomaterials, whether they | | |
| contain asbestos or no | t, from | |
| ${\tt mechanical\ systems)}$ | \$ 49.91 | 36.63 |
| ASBE0006-008 09/01/20 | | |
| | Rates | Fringes |
| Asbestos Worker/Insula | tor | |
| Includes applicat | ion of | |
| all insulating ma | | |
| protective covering coatings & finished | | |
| | al systems.\$ 49.91 | 36.63 |
| BOIL0029-001 01/01/20 | 25 | |
| 00110029 001 01/01/20 | | |
| | Rates | Fringes |
| BOILERMAKER | \$ 50.62 | 28.82 |
| BRRI0003-001 06/01/202 | 22 | |
| | Rates | Fringes |
| Bricklayer, Stonemason | _ | |
| Pointer, Caulker & Clea | aner\$ 46.86 | |
| BRRI0003-002 09/01/20 | 22 | |
| | Dates | - Frings |
| | Rates | Fringes |
| Marble Setter, Terrazzo Worker & Tile Setter | | 30.34 |
| BRRI0003-003 09/01/20 | | |
| 22.2 22.2 25, 22, 20. | | |
| | Rates | Fringes |
| Marble, Tile & Terrazzo | 0 | |
| Finisher | \$ 38.78 | 29.61 |
| | | |

Addendum No. 1

| I | Rates | Fringes |
|--------------------------|-------|---------|
| CARPENTER (Includes Soft | | |
| Floor Layer)\$ | 47.88 | 30.50 |
| Diver Tender\$ | 48.68 | 30.50 |
| DIVER\$ | 60.83 | 30.50 |
| Piledriver\$ | 41.53 | 29.35 |
| WELDER\$ | 48.68 | 30.50 |

FOOTNOTES:

When not diving or tending the diver, the diver and diver tender shall receive the piledriver rate. Diver tenders shall receive \$1.00 per hour above the pile driver rate when tending the diver.

Work on free-standing stacks, concrete silos & public utility electrical power houses, which are over 35 ft. in height when constructed: \$.50 per hour additional.

Work on exterior concrete shear wall gang forms, 45 ft. or more above ground elevation or on setback: \$.50 per hour additional.

The designated piledriver, known as the ""monkey"": \$1.00 per hour additional.

* CARP1121-002 04/21/2025

| | Rates | Fringes |
|-------------------------|-----------|---------|
| MILLWRIGHT | .\$ 45.72 | 31.50 |
| ELEC0099-002 06/01/2025 | | |

| R | ates | Fringes |
|-----------------------------|-------|--------------|
| ELECTRICIAN\$ | 56.11 | 44.10% |
| Teledata System Installer\$ | 42.09 | 10.45%+15.31 |

FOOTNOTES:

Work of a hazardous nature, or where the work height is 30 ft. or more from the floor, except when working OSHA-approved lifts: 20% per hour additional.

Work in tunnels below ground level in combined sewer outfall: 20% per hour additional.

ELEV0039-001 01/01/2025

| | F | Rates | Fringes |
|----------|------------|-------|------------|
| ELEVATOR | MECHANIC\$ | 64.52 | 38.435+a+b |

FOOTNOTES:

a. PAID HOLIDAYS: New Years Day; Memorial Day; Independence Day; Labor Day; Veterans' Day; Thanksgiving Day; the Friday after Thanksgiving Day; and Christmas Day.

b. Employer contributes 8% basic hourly rate for 5 years or more of service of 6% basic hourly rate for 6 months to 5 years of service as vacation pay credit.

ENGI0057-001 06/01/2025

| Rates | Fringes |
|-------|---------|
| | |

Operating Engineer: (power plants, sewer treatment plants, pumping stations, tunnels, caissons, piers, docks, bridges, wind turbines, subterranean & other marine and heavy construction work)

| GROUP | 1\$ 50.30 | 29.70 |
|-------|-----------|-------|
| GROUP | 2\$ 48.30 | 29.70 |
| GROUP | 3\$ 43.92 | 29.70 |
| GROUP | 4\$ 41.07 | 29.70 |
| GROUP | 5\$ 47.35 | 29.70 |
| GROUP | 6\$ 38.15 | 29.70 |
| GROUP | 7\$ 32.15 | 29.70 |
| GROUP | 8\$ 44.00 | 29.70 |
| GROUP | 9\$ 47.92 | 29.70 |

a. BOOM LENGTHS, INCLUDING JIBS:

150 feet and over + \$ 2.00 180 feet and over + \$ 3.00 210 feet and over + \$ 4.00 240 feet and over + \$ 5.00 270 feet and over + \$ 7.00 300 feet and over + \$ 8.00 350 feet and over + \$ 9.00 400 feet and over + \$ 10.00

a. PAID HOLIDAYS:

New Year's Day, President's Day, Memorial Day, July Fourth, Victory Day, Labor Day, Columbus Day, Veterans Day, Thanksgiving Day, Christmas Day. a: Any employee who works 3 days in the week in which a holiday falls shall be paid for the holiday.

a. FOOTNOTES:

Hazmat work: \$2.00 per hour additional.
Tunnel/Shaft work: \$5.00 per hour additional.

POWER EQUIPMENT OPERATORS CLASSIFICATIONS

GROUP 1: Cranes, lighters, boom trucks and derricks

GROUP 2: Digging machine, Ross Carrier, locomotive, hoist, elevator, bidwell-type machine, shot & water blasting machine, paver, spreader, graders, front end loader (3 yds. and over), vibratory hammer & vacuum truck, roadheaders, forklifts, economobile type equipment, tunnel boring machines, concrete pump and on site concrete plants.

GROUP 3: Oilers on cranes.

GROUP 4: Oiler on crawler backhoe.

GROUP 5: Bulldozer, bobcats, skid steer loader, tractor, scraper, combination loader backhoe, roller, front end loader (less than 3 yds.), street and mobile-powered sweeper (3-yd. capacity), 8-ft. sweeper minimum 65 HP).

GROUP 6: Well-point installation crew.

GROUP 7: Utility Engineers and Signal Persons

GROUP 8: Heater, concrete mixer, stone crusher, welding machine, generator and light plant, gas and electric driven pump and air compressor.

GROUP 9: Boat & tug operator.

ENGI0057-003 06/01/2025

BUILDING CONSTRUCTION

| | | Rates | Fringes |
|-------------|---------------|-------|---------|
| Power Equip | ment Operator | | |
| GROUP | 1 | 49.57 | 29.50 |
| GROUP | 2 | 47.57 | 29.50 |
| GROUP | 3 | 47.35 | 29.50 |
| GROUP | 4 | 43.35 | 29.50 |
| GROUP | 5 | 40.50 | 29.50 |
| GROUP | 6 | 46.65 | 29.50 |
| GROUP | 7 | 46.65 | 29.50 |
| GROUP | 8 | 43.54 | 29.50 |

a.BOOM LENTHS, INCLUDING JIBS:

150 ft. and over: + \$ 2.00 180 ft. and over: + \$ 3.00 210 ft. and over: + \$ 4.00 240 ft. and over: + \$ 5.00 270 ft. and over: + \$ 7.00 300 ft. and over: + \$ 8.00 350 ft. and over: + \$ 9.00 400 ft. and over: + \$10.00

- a. PAID HOLIDAYS: New Year's Day, President's Day, Memorial Day, July Fourth, Victory Day, Labor Day, Columbus Day, Veterans Day, Thanksgiving Day & Christmas Day. a: Any employee who works 3 days in the week in which a holiday falls shall be paid for the holiday.
- a. FOOTNOTE: Hazmat work: \$2.00 per hour additional. Tunnel/Shaft work: \$5.00 per hour additional.

POWER EQUIPMENT OPERATORS CLASSIFICATIONS

GROUP 1: Cranes, lighters, boom trucks and derricks.

GROUP 2: Digging machine, Ross carrier, locomotive, hoist, elevator, bidwell-type machine, shot & water blasting machine, paver, spreader, front end loader (3 yds. and over), vibratory hammer and vacuum truck

GROUP 3: Telehandler equipment, forklift, concrete pump & on-site concrete plant

GROUP 5: Oiler on crawler backhoe

GROUP 6: Bulldozer, skid steer loaders, bobcats, tractor, grader, scraper, combination loader backhoe, roller, front end loader (less than 3 yds.), street and mobile powered sweeper (3 yds. capacity), 8-ft. sweeper (minimum 65 hp)

GROUP 7: Well point installation crew

GROUP 8: Heater, concrete mixer, stone crusher, welding machine, generator for light plant, gas and electric driven pump & air compressor

ENGI0057-005 05/01/2025

Rates Fringes Power Equipment Operator (highway construction projects; water and sewerline projects which are incidental to highway construction projects; and bridge projects that do not span water) GROUP 1.....\$ 45.45 29.70 GROUP 2.....\$ 43.45 29.70 GROUP 3.....\$ 38.15 29.70 GROUP 4.....\$ 24.75 29.70 GROUP 5.....\$ 32.15 29.70 GROUP 6.....\$ 38.73 29.70 GROUP 7.....\$ 42.43 29.70 29.70 GROUP 8.....\$ 37.70

- a. FOOTNOTE: a. Any employee who works three days in the week in which a holiday falls shall be paid for the holiday.
- b. PAID HOLIDAYS: New Year's Day, President's Day, Memorial Day, July Fourth, Victory Day, Labor Day, Columbus Day, Veterans Day, Thanksgiving Day & Christmas Day.

POWER EQUIPMENT OPERATOR CLASSIFICATIONS

- GROUP 1: Cranes, pile drivers, lighters, boom trucks, hoists, derricks
- GROUP 2: Digging machines, excavators, locomotives, John Henry's, directional drilling machines, cold planers, reclaimers, pavers, spreaders, graders, front-end loaders (3yds & over), vacuum truck, drill/boring machine operators, vermeer saw, water blaster, hydraulic-demolition robot, Ross Carriers, concrete pump operators, asphalt/material transfer machines, rotating telehandlers, SPMT type equipment
- GROUP 3: Wellpoint installation and drill/boring machine assistants
- GROUP 4: Utility engineers
- GROUP 5: Signal persons
- GROUP 6: Oilers on cranes and deckhands

GROUP 7: Combination loader / backhoes, front-end loaders (less than 3 yds.), forklift, bulldozers, scrapers, boats, rollers, skid steer loaders (regardless of attachments), street sweepers, mechanics, welders, operators in materials yards, shops and garages

GROUP 8: Gas and electric drive heaters, concrete mixers, light plants, welding machines, pumps and compressors

IRON0037-001 03/16/2025

LAB00271-001 12/03/2023

| | Rates | Fringes |
|------------|----------|---------|
| IRONWORKER | \$ 42.58 | 32.98 |

BUILDING CONSTRUCTION

| | | Rates | Fringes |
|----------|-----------------|----------|---------|
| LABORER | | | |
| GROUP | 1 | \$ 37.00 | 26.90 |
| GROUP | 2 | \$ 37.00 | 26.90 |
| GROUP | 3 | \$ 37.00 | 26.90 |
| GROUP | 4 | \$ 37.00 | 26.90 |
| GROUP | 5 | \$ 39.00 | 26.90 |
| LABORERS | CLASSIFICATIONS | | |

GROUP 1: Laborer, Carpenter Tender, Mason Tender, Cement Finisher Tender, Scaffold Erector, Wrecking Laborer, Asbestos Removal [Non-Mechanical Systems]

GROUP 2: Asphalt Raker, Adzemen, Pipe Trench Bracer,
Demolition Burner, Chain Saw Operator, Fence & Guard Rail
Erector, Setter of Metal Forms for Roadways, Mortar Mixer,
Pipelayer, Riprap & Dry Stonewall Builder, Highway Stone
Spreader, Pneumatic Tool Operator, Wagon Drill Operator, Tree
Trimmer, Barco-Type Jumping Tamper, Mechanical Grinder Operator

GROUP 3: Pre-Cast Floor & Roof Plank Erectors

GROUP 4: Air Track Operator, Hydraulic & Similar Self-Powered Drill, Block Paver, Rammer, Curb Setter, Powderman & Blaster

GROUP 5: Toxic Waste Remover

LABORERS CLASSIFICATIONS

GROUP 1: Laborer, Carpenter Tender, Mason Tender, Cement Finisher Tender, Scaffold Erector, Wrecking Laborer, Asbestos Removal [Non-Mechanical Systems]

GROUP 2: Asphalt Raker, Adzemen, Pipe Trench Bracer, Demolition Burner, Chain Saw Operator, Fence & Guard Rail Erector, Setter of Metal Forms for Roadways, Mortar Mixer, Pipelayer, Riprap & Dry Stonewall Builder, Highway Stone Spreader, Pneumatic Tool Operator, Wagon Drill Operator, Tree Trimmer, Barco-Type Jumping Tamper, Mechanical Grinder Operator

GROUP 3: Pre-Cast Floor & Roof Plank Erectors

GROUP 4: Air Track Operator, Hydraulic & Similar Self-Powered Drill, Block Paver, Rammer, Curb Setter, Powderman & Blaster

GROUP 5: Toxic Waste Remover

LAB00271-002 11/27/2022

HEAVY AND HIGHWAY CONSTRUCTION

| | Rates | Fringes |
|-------------------------|-----------|---------|
| LABORER | | |
| COMPRESSED AIR | | |
| | ¢ | 24 15 |
| Group 1 | | 24.15 |
| Group 2 | | 24.15 |
| Group 3 | .\$ 42.45 | 24.15 |
| FREE AIR | | |
| Group 1 | | 24.15 |
| Group 2 | .\$ 45.00 | 24.15 |
| Group 3 | .\$ 42.45 | 24.15 |
| LABORER | | |
| Group 1 | .\$ 33.05 | 24.05 |
| Group 2 | | 24.85 |
| Group 3 | | 24.85 |
| Group 4 | | 24.85 |
| Group 5 | | 24.85 |
| OPEN AIR CAISSON, | | |
| UNDERPINNING WORK AND | | |
| BORTNG CREW | | |
| Bottom Man | ¢ 11 50 | 24.15 |
| | | 24.15 |
| Top Man & Laborer | .\$ 33.00 | 24.15 |
| TEST BORING | đ 44 0E | 24.45 |
| Driller | | 24.15 |
| Laborer | .\$ 41.95 | 24.15 |
| LABORER CLASSIFICATIONS | | |

GROUP 1: Laborer; Carpenter tender; Cement finisher tender; Wrecking laborer; Asbestos removers [non-mechanical systems]; Plant laborer; Driller in quarries

GROUP 2: Adzeperson; Asphalt raker; Barcotype jumping tamper; Chain saw operators; Concrete and power buggy operator; Concrete saw operator; Demolition burner; Fence and guard rail erector; Highway stone spreader; Laser beam operator; Mechanical grinder operator; Mason tender; Mortar mixer; Pneumatic tool operator; Riprap and dry stonewall builder; Scaffold erector; Setter of metal forms for roadways; Wagon drill operator; Wood chipper operator; Pipelayer; Pipe trench bracer

GROUP 3: Air track drill operator; Hydraulic and similar powered drills; Brick paver; Block paver; Rammer and curb setter; Powderperson and blaster

GROUP 4: Flagger & signaler

GROUP 5: Toxic waste remover

LABORER - COMPRESSED AIR CLASSIFICATIONS

GROUP 1: Mucking machine operator, tunnel laborer, brake person, track person, miner, grout person, lock tender, gauge tender, miner: motor person & all others in compressed air

- GROUP 2: Change house attendant, powder watchperson, top person on iron
- GROUP 3: Hazardous waste work within the ""HOT"" zone

LABORER - FREE ATR CLASSIFICATIONS

GROUP 1: Grout person - pumps, brake person, track person, form mover & stripper (wood & steel), shaft laborer, laborer topside, outside motorperson, miner, conveyor operator, miner welder, heading motorperson, erecting operator, mucking machine operator, nozzle person, rodperson, safety miner, shaft & tunnel, steel & rodperson, mole nipper, concrete worker, form erector (wood, steel and all accessories), cement finisher (this type of work only), top signal person, bottom person (when heading is 50' from shaft), burner, shield operator and TBM operator

- GROUP 2: Change house attendant, powder watchperson
- GROUP 3: Hazardous waste work within the ""HOT"" zone

LABORER CLASSIFICATIONS

GROUP 1: Laborer; Carpenter tender; Cement finisher tender; Wrecking laborer; Asbestos removers [non-mechanical systems]; Plant laborer; Driller in quarries

GROUP 2: Adzeperson; Asphalt raker; Barcotype jumping tamper; Chain saw operators; Concrete and power buggy operator; Concrete saw operator; Demolition burner; Fence and guard rail erector; Highway stone spreader; Laser beam operator; Mechanical grinder operator; Mason tender; Mortar mixer; Pneumatic tool operator; Riprap and dry stonewall builder; Scaffold erector; Setter of metal forms for roadways; Wagon drill operator; Wood chipper operator; Pipelayer; Pipe trench bracer

GROUP 3: Air track drill operator; Hydraulic and similar powered drills; Brick paver; Block paver; Rammer and curb setter; Powderperson and blaster

GROUP 4: Flagger & signaler

GROUP 5: Toxic waste remover

LABORER - COMPRESSED AIR CLASSIFICATIONS

GROUP 1: Mucking machine operator, tunnel laborer, brake person, track person, miner, grout person, lock tender, gauge tender, miner: motor person & all others in compressed air

GROUP 2: Change house attendant, powder watchperson, top person on iron

GROUP 3: Hazardous waste work within the ""HOT"" zone

LABORER - FREE AIR CLASSIFICATIONS

GROUP 1: Grout person - pumps, brake person, track person, form mover & stripper (wood & steel), shaft laborer, laborer topside, outside motorperson, miner, conveyor operator, miner welder, heading motorperson, erecting

operator, mucking machine operator, nozzle person, rodperson, safety miner, shaft & tunnel, steel & rodperson, mole nipper, concrete worker, form erector (wood, steel and all accessories), cement finisher (this type of work only), top signal person, bottom person (when heading is 50' from shaft), burner, shield operator and TBM operator

GROUP 2: Change house attendant, powder watchperson

GROUP 3: Hazardous waste work within the ""HOT"" zone

PAIN0011-005 06/01/2025

| Rates | Fringes |
|--|---------|
| PAINTER Brush and Roller\$ 39.57 Epoxy, Tanks, Towers, Swing Stage & Structural | 26.60 |
| Steel\$ 41.57 Spray, Sand & Water | 26.60 |
| Blasting\$ 42.57 | 26.60 |
| Taper\$ 38.82 | 25.80 |
| Wall Coverer \$ 38.57 | 25.80 |

PAIN0011-006 06/01/2024

| | Rates | Fringes |
|---------|----------|---------|
| GLAZIER | \$ 41.63 | 26.15 |

FOOTNOTES:

SWING STAGE: \$1.00 per hour additional.

PAID HOLIDAYS: Labor Day & Christmas Day.

PAIN0011-011 06/01/2024

| | Rates | Fringes | |
|-------------------------|----------|---------|--|
| Painter (Bridge Work) | \$ 57.85 | 26.40 | |
| PATN0035-008 06/01/2011 | | | |

PAIN0035-008 06/01/2011

| | Rates | Fringes | |
|-------------------------|----------|---------|--|
| Sign Painter | \$ 24.79 | 13.72 | |
| DI ACQUA QQ1 Q1/Q1/2Q2E | | | |

PLAS0040-001 01/01/2025

BUILDING CONSTRUCTION

| Rates | | Fringes | | |
|--------|----------------|------------|-------|-------|
| CEMENT | MASON/CONCRETE | FINISHER\$ | 44.75 | 29.10 |

FOOTNOTE: Cement Mason: Work on free swinging scaffolds under 3 planks width and which is 20 or more feet above ground and any offset structure: \$.30 per hour additional.

PLAS0040-002 01/01/2025

| | Rates | Fringes |
|--------------------------------|--|---|
| CEMENT MASON/CONCRETE FINISHER | \$ 44.75 | 29.10 |
| PLAS0040-003 01/01/2025 | | |
| | Rates | Fringes |
| PLASTERER | \$ 45.52 | 29.43 |
| * PLUM0051-002 08/25/2025 | | |
| | Rates | Eningos |
| | kates | Fringes |
| Plumbers and Pipefitters | \$ 54.34 | 34.50 |
| ROOF0033-004 08/01/2025 | | |
| | Rates | Fringes |
| ROOFER | \$ 53.53 | 35.69 |
| SFRI0669-001 04/01/2025 | | |
| | Rates | Fringes |
| SPRINKLER FITTER | \$ 53.76 | 33.44 |
| SHEE0017-002 06/01/2025 | | |
| , , | Rates | Fringes |
| | | - |
| Sheet Metal Worker | \$ 44.42 | 41.94 |
| TEAM0251-001 05/01/2025 | | |
| HEAVY AND HIGHWAY CONSTRUCTION | | |
| | Rates | Fringes |
| TRUCK DRIVER GROUP 1 | \$ 32.01 \$ 32.06 \$ 32.11 \$ 32.21 \$ 32.61 \$ 32.81 \$ 32.31 \$ 32.56 | 34.51+a+b |
| EOOTNOTES. | | |

FOOTNOTES:

- A. Paid Holidays: New Year's Day, Memorial Day, Independence Day, Labor Day, Thanksgiving Day and Christmas Day, plus Presidents' Day, Columbus Day, Veteran's Day & V-J Day, providing the employee has worked at least one day in the calendar week in which the holiday falls.
- B. Employee who has been on the payroll for 1 year or more but less than 5 years and has worked 150 Days during the

last year of employment shall receive 1 week's paid vacation; 5 to 10 years - 2 weeks' paid vacation; 10 or more years - 3 week's paid vacation.

C. Employees on the seniority list shall be paid a one hundred dollar (\$100.00) bonus for every four hundred (400) hours worked, up to a maximum of five hundred dollars (\$500.00)

All drivers working on a defined hazard material job site shall be paid a premium of \$2.00 per hour over applicable rate.

TRUCK DRIVER CLASSIFICATIONS

GROUP 1: Pick-up trucks, station wagons, & panel trucks

GROUP 2: Two-axle on low beds

GROUP 3: Two-axle dump truck

GROUP 4: Three-axle dump truck

GROUP 5: Four- and five-axle equipment

GROUP 6: Low-bed or boom trailer.

GROUP 7: Trailers when used on a double hook up (pulling 2 trailers)

GROUP 8: Special earth-moving equipment, under 35 tons

GROUP 9: Special earth-moving equipment, 35 tons or over

GROUP 10: Tractor trailer

WELDERS - Receive rate prescribed for craft performing operation to which welding is incidental.

Note: Executive Order (EO) 13706, Establishing Paid Sick Leave for Federal Contractors applies to all contracts subject to the Davis-Bacon Act for which the contract is awarded (and any solicitation was issued) on or after January 1, 2017. If this contract is covered by the EO, the contractor must provide employees with 1 hour of paid sick leave for every 30 hours they work, up to 56 hours of paid sick leave each year. Employees must be permitted to use paid sick leave for their own illness, injury or other health-related needs, including preventive care; to assist a family member (or person who is like family to the employee) who is ill, injured, or has other health-related needs, including preventive care; or for reasons resulting from, or to assist a family member (or person who is like family to the employee) who is a victim of, domestic violence, sexual assault, or stalking. Additional information on contractor requirements and worker protections under the EO is available at

https://www.dol.gov/agencies/whd/government-contracts.

Unlisted classifications needed for work not included within the scope of the classifications listed may be added after award only as provided in the labor standards contract clauses

The body of each wage determination lists the classifications and wage rates that have been found to be prevailing for the type(s) of construction and geographic area covered by the wage determination. The classifications are listed in alphabetical order under rate identifiers indicating whether the particular rate is a union rate (current union negotiated rate), a survey rate, a weighted union average rate, a state adopted rate, or a supplemental classification rate.

Union Rate Identifiers

A four-letter identifier beginning with characters other than ""SU"", ""UAVG"", ?SA?, or ?SC? denotes that a union rate was prevailing for that classification in the survey. Example: PLUM0198-005 07/01/2024. PLUM is an identifier of the union whose collectively bargained rate prevailed in the survey for this classification, which in this example would be Plumbers. 0198 indicates the local union number or district council number where applicable, i.e., Plumbers Local 0198. The next number, 005 in the example, is an internal number used in processing the wage determination. The date, 07/01/2024 in the example, is the effective date of the most current negotiated rate.

Union prevailing wage rates are updated to reflect all changes over time that are reported to WHD in the rates in the collective bargaining agreement (CBA) governing the classification.

Union Average Rate Identifiers

The UAVG identifier indicates that no single rate prevailed for those classifications, but that 100% of the data reported for the classifications reflected union rates. EXAMPLE: UAVG-OH-0010 01/01/2024. UAVG indicates that the rate is a weighted union average rate. OH indicates the State of Ohio. The next number, 0010 in the example, is an internal number used in producing the wage determination. The date, 01/01/2024 in the example, indicates the date the wage determination was updated to reflect the most current union average rate.

A UAVG rate will be updated once a year, usually in January, to reflect a weighted average of the current rates in the collective bargaining agreements on which the rate is based.

Survey Rate Identifiers

The ""SU"" identifier indicates that either a single non-union rate prevailed (as defined in 29 CFR 1.2) for this classification in the survey or that the rate was derived by computing a weighted average rate based on all the rates reported in the survey for that classification. As a weighted average rate includes all rates reported in the survey, it may include both union and non-union rates. Example: SUFL2022-007 6/27/2024. SU indicates the rate is a single non-union prevailing rate or a weighted average of survey data for that classification. FL indicates the State of Florida. 2022 is the year of the survey on which these classifications and rates are based. The next number, 007 in the example, is an internal number used in producing the wage determination. The date,

6/27/2024 in the example, indicates the survey completion date for the classifications and rates under that identifier.

?SU? wage rates typically remain in effect until a new survey is conducted. However, the Wage and Hour Division (WHD) has the discretion to update such rates under 29 CFR 1.6(c)(1).

State Adopted Rate Identifiers

The ""SA"" identifier indicates that the classifications and prevailing wage rates set by a state (or local) government were adopted under 29 C.F.R 1.3(g)-(h). Example: SAME2023-007 01/03/2024. SA reflects that the rates are state adopted. ME refers to the State of Maine. 2023 is the year during which the state completed the survey on which the listed classifications and rates are based. The next number, 007 in the example, is an internal number used in producing the wage determination. The date, 01/03/2024 in the example, reflects the date on which the classifications and rates under the ?SA? identifier took effect under state law in the state from which the rates were adopted.

WAGE DETERMINATION APPEALS PROCESS

1) Has there been an initial decision in the matter? This can be:

- a) a survey underlying a wage determination
- b) an existing published wage determination
- c) an initial WHD letter setting forth a position on a wage determination matter
- d) an initial conformance (additional classification and rate) determination

On survey related matters, initial contact, including requests for summaries of surveys, should be directed to the WHD Branch of Wage Surveys. Requests can be submitted via email to davisbaconinfo@dol.gov or by mail to:

Branch of Wage Surveys Wage and Hour Division U.S. Department of Labor 200 Constitution Avenue, N.W. Washington, DC 20210

Regarding any other wage determination matter such as conformance decisions, requests for initial decisions should be directed to the WHD Branch of Construction Wage Determinations. Requests can be submitted via email to BCWD-Office@dol.gov or by mail to:

Branch of Construction Wage Determinations Wage and Hour Division U.S. Department of Labor 200 Constitution Avenue, N.W. Washington, DC 20210

2) If an initial decision has been issued, then any interested party (those affected by the action) that disagrees with the decision can request review and reconsideration from the Wage and Hour Administrator (See 29 CFR Part 1.8 and 29 CFR Part 7). Requests for review and reconsideration can be submitted via email to dba.reconsideration@dol.gov or by mail to:

Wage and Hour Administrator U.S. Department of Labor 200 Constitution Avenue, N.W. Washington, DC 20210

The request should be accompanied by a full statement of the interested party's position and any information (wage payment data, project description, area practice material, etc.) that the requestor considers relevant to the issue.

3) If the decision of the Administrator is not favorable, an interested party may appeal directly to the Administrative Review Board (formerly the Wage Appeals Board). Write to:

Administrative Review Board U.S. Department of Labor 200 Constitution Avenue, N.W. Washington, DC 20210.

END OF GENERAL DECISION"

| Question and Answers for RICN 2025-CB-057 | | | | | | | |
|---|---|--|-----------------------|-----------------------|--|--|--|
| Question Ask By | Question | Answer | Date Submitted | Date Responded | | | |
| John Rocchio Corporation | Can you confirm that the return walls are paid under the item "CONCRETE SUBSTRUCTURE CLASS HP 3/4" END POSTS"? Can these also be cast-in-place? | The precast return walls are paid for under Item Code 808.0322. Cast-in-place concrete is an acceptable alternative. | Oct 22, 2025 7:02 AM | Oct 22, 2025 11:50 AM | | | |
| Aetna Bridge Company | Will CIP End Posts be an acceptable alternative to the precast shown at Bridge 095601? | Cast-in-place end posts will be an acceptable alternative to the precast end post shown in the Plans. | Oct 21, 2025 12:57 PM | Oct 21, 2025 2:31 PM | | | |
| Aetna Bridge Company | There is significant erosion to the channel bank under the existing bridges. It will require gravel or common borrow fill to bring the bank up to subgrade elevation for the filter stone and riprap. The contract only has a fill item for gravel borrow subbase. Please indicate how this fill be paid? | | Oct 21, 2025 12:55 PM | Oct 21, 2025 2:30 PM | | | |
| John Rocchio Corporation | Under which items are the new utility sleeves, end seals, rollers, and insulation for the new water main paid? | All of this work and materials will be included for payment under Item Code 701.5402. | Oct 21, 2025 10:34 AM | Oct 21, 2025 2:30 PM | | | |
| John Rocchio Corporation | Details on plan sheet 16 in both Volume 2 and 3 indicate that shear studs are to be welded into the existing utility sleeves to be sealed. Note 2 indicates these will be paid under the item "Structural Steel", which is paid by the lb. Please confirm this is correct. | This detail will be revised and the studs eliminated by addendum. | Oct 21, 2025 10:23 AM | Oct 21, 2025 2:30 PM | | | |
| John Rocchio Corporation | Under which item are the studded angles cast into the deck and sidewalk ends paid? | The steel angles and studs will be paid for under Item Code 824.2000. | Oct 21, 2025 10:18 AM | Oct 21, 2025 2:30 PM | | | |
| Aetna Bridge Company | Can the bridge rails be galvanized or color galvanized in lieu of metalized given the remaining structure is no longer metalized? | Per Metalizing/Galvanizing Note 3 on Sheet No. 4 of Volumes 2 & 3, the railing shall be galvanized. Final color of the topcoat shall be Federal Color 17038 (Black, Gloss) per Paint Note 2 on Sheet No. 4 of Volumes 2 & 3. | Oct 17, 2025 12:23 PM | Oct 20, 2025 8:39 AM | | | |
| John Rocchio Corporation | payment, will an independent debris shield be required in all areas, or will some areas having | Provided the work platform conforms to all the requirements of the temporary shielding included in Section 803 of the RI Standard Specification it will be paid for under that item. | Oct 16, 2025 3:01 PM | Oct 20, 2025 8:43 AM | | | |

| | | Oct 16, 2025 12:40 PM | Oct 16, 2025 4:40 PM |
|--|--|--|---|
| The Job Specific General Provision for Item 824.9901 – Structural Steel Repairs - indicates that the new structural steel should be prepared and primed in the shop in accordance with RI Std. Spec. Sect. 825 while Metalizing/Galvanizing Note No. 2 on the Bridge General Notes – 3 sheet in both Volume 2 & 3 indicate that proposed repair plates, structural steel shall be shop metalized. Please clarify which is correct. | Metalizing will be removed from the contract by addendum. | Oct 16, 2025 12:40 PM | Oct 16, 2025 4:39 PM |
| Is the use of SIP forms acceptable for the interior 3 bays at Singleton bridge and the interior 4 bays at River Street bridge that have haunches? | All deck forms shall be of the removable type. | Oct 14, 2025 2:05 PM | Oct 15, 2025 9:38 AM |
| The concrete protective sealer item includes areas in the DOQ for "Decks". Can you clarify if this is for the top of the deck and if so, what sealer material is to be used? | Per Note 4 on Sheet 32 of Volumes 2 & 3, the exposed top surface of the bridge deck will receive a penetrant sealer (M12.03.2). | Oct 14, 2025 7:10 AM | Oct 14, 2025 9:07 AM |
| Is grooving of the concrete bridge decks required and if so, under which item is this work paid? | Grooving the concrete bridge decks is required as specified in Subsection 814.03.9 of the RI Standard Specifications. As noted in Subsection 814.05, no separate payment will be made for this work. Payment is included in the cost of the bridge deck concrete. | Oct 14, 2025 7:07 AM | Oct 14, 2025 8:59 AM |
| Will the full area of the temporary work platform shown on the plans, as well as any vertical shielding required, be considered the limits of payment for Temporary Deck Underside and Side Protective Shielding? | The Temporary Deck Underside & Side Protective Shielding will be measured in accordance with Subsection 803.04.3 of the RI Standard Specifications. | Oct 10, 2025 12:30 PM | Oct 13, 2025 2:39 PM |
| The OSP site has both Items 21 and 22 listed as "Hot Mix Asphalt Preparation - Full Depth". Can you confirm line Item 21 should be for Partial Depth preparation as in the DOQ? | Item 21 should be Item Code 401.0510 Hot Mix Asphalt Preparation - Partial Depth. This will be corrected by addendum. | Oct 10, 2025 11:31 AM | Oct 13, 2025 2:52 PM |
| | are required to be shop metalized instead of shop primed, would RIDOT accept having these materials being provided as hot-dip galvanized in lieu of metalizing? Galvanizing of these repair materials could be completed in a much more economical and expeditious manner compared to metalizing. Please advise. The Job Specific General Provision for Item 824.9901 – Structural Steel Repairs - indicates that the new structural steel should be prepared and primed in the shop in accordance with RI Std. Spec. Sect. 825 while Metalizing/Galvanizing Note No. 2 on the Bridge General Notes – 3 sheet in both Volume 2 & 3 indicate that proposed repair plates, structural steel shall be shop metalized. Please clarify which is correct. Is the use of SIP forms acceptable for the interior 3 bays at Singleton bridge and the interior 4 bays at River Street bridge that have haunches? The concrete protective sealer item includes areas in the DOQ for "Decks". Can you clarify if this is for the top of the deck and if so, what sealer material is to be used? Is grooving of the concrete bridge decks required and if so, under which item is this work paid? Will the full area of the temporary work platform shown on the plans, as well as any vertical shielding required, be considered the limits of payment for Temporary Deck Underside and Side Protective Shielding? The OSP site has both Items 21 and 22 listed as "Hot Mix Asphalt Preparation - Full Depth". Can you confirm line Item 21 should be for | are required to be shop metalized instead of shop primed, would RIDOT accept having these materials being provided as hot-dip galvanized in lieu of metalizing? Galvanizing of these repair materials could be completed in a much more economical and expeditious manner compared to metalizing. Please advise. The Job Specific General Provision for Item 824.9901 – Structural Steel Repairs - indicates that the new structural steel should be prepared and primed in the shop in accordance with RI Std. Spec. Sect. 825 while Metalizing/Galvanizing Note No. 2 on the Bridge General Notes – 3 sheet in both Volume 2 & 3 indicate that proposed repair plates, structural steel shall be shop metalized. Please clarify which is correct. Is the use of SIP forms acceptable for the interior 3 bays at Singleton bridge and the interior 4 bays at River Street bridge that have haunches? The concrete protective sealer item includes areas in the DOQ for "Decks". Can you clarify if this is for the top of the deck and if so, what sealer material is to be used? The concrete protective sealer item includes areas in the DOQ for "Decks". Can you clarify if this is for the top of the deck and if so, what sealer material is to be used? Grooving the concrete bridge decks required and if so, under which item is this work paid? Will the full area of the temporary work platform shown on the plans, as well as any vertical shielding required, be considered the limits of payment for Temporary Deck Underside and Side Protective Shielding? The OSP site has both Items 21 and 22 listed as "Hot Mix Asphalt Preparation - Full Depth". Can you confirm line Item 21 should be for | are required to be shop metalized instead of shop primed, would RIDOT accept having these materials being provided as hot-dip galvanized in lieu of metalizing? Galvanizing of these repair materials could be completed in a much more economical and expeditious manner compared to metalizing. Please advise. The Job Specific General Provision for Item 824.9901 — Structural Steel Repairs - Indicates that the new structural steel should be prepared and primed in the shop in accordance with RI Std. Spec. Sect. 825 while Metalizing/Galvanizing Note No. 2 on the Bridge General Notes — 3 sheet in both Volume 2 & 3 indicate that proposed repair plates, structural steel shall be shop metalized. Please clarify which is correct. Is the use of SIP forms acceptable for the interior 3 bays at Singleton bridge and the interior 4 bays at Singleton bridge and the interior 4 bays at Singleton bridge and the interior and the interior and the interior is a bays at Singleton bridge and the interior and the interior and the interior and the interior is a bays at Singleton bridge and the interior are simple to the deck and if so, what sealer material is to be used? Per Note 4 on Sheet 32 of Volumes 2 & 3, the exposed top surface of the bridge deck will receive a penetrant sealer (M12.03.2). Grooving the concrete bridge decks is required as specified in Subsection 814.03.9 of the RI Standard Specifications. As noted in Subsection 814.03.9 of the RI Standard Specifications. As noted in Subsection 803.04.3 of the RI Standard Specifications. Will the full area of the temporary work platform shown on the plans, as well as any vertical shielding required, be considered the limits of payment for Temporary Deck Underside & Side Protective Shielding? The OSP site has both Items 21 and 22 listed as "Hot Mix Asphalt Preparation - Full Depth". Can you confirm |

| John Rocchio Corporation | Under which item are the granite ID tablets paid? | Item Code 833.0400 will be added to the Contract by addendum | Oct 10, 2025 11:28 AM | Oct 13, 2025 2:40 PM |
|--------------------------|--|---|-----------------------|----------------------|
| John Rocchio Corporation | What level of AISC certification is required of the shop fabricating the steel repair materials? | The AISC certification for the steel fabricating shop will be changed to "Simple Steel Bridges (SBR)" by addendum. | Oct 10, 2025 8:02 AM | Oct 14, 2025 1:47 PM |
| Aetna Bridge Company | Please consider changing the painting from field metalizing to a standard 3-coat paint system given the following constraints: metalizing is a much slower process and the schedule requires both truss bridges to be completed in the first season while working consecutively; there are few contractors with the QP-6 certification and the experience to do field metalizing; truss bridges will make this work more even difficult and access to metalize non-accessible location that could otherwise be painted will require masking; no local agencies have performed field metalizing on truss bridges; metalizing is needed immediately after blasting making field measuring of steel repairs difficult; currently steel repairs are performed after deck replacement with metalizing, if painted the steel repairs would be completed after blasting and priming making the truss safer for conventional equipment during demo and reconstruction. | Metalizing of the steel will be removed from the contract, and a three coat NEPCOAT paint system will be applied. This will be changed by addendum. | Oct 9, 2025 4:56 PM | Oct 16, 2025 4:39 PM |
| Aetna Bridge Company | The project requires field metalizing of Bridges 095501 and 095601. There is no JS specification for this work and the RIDOT Standard Spec only has a specification for Section 827 - Thermal Sprayed Zinc Coating for New Structural Steel which is a shop applied application. Please provide a JS specification for the field metalizing. | Metalizing of the steel will be removed from the contract, and a three coat NEPCOAT paint system will be applied. This will be changed by addendum. | Oct 9, 2025 4:18 PM | Oct 16, 2025 4:39 PM |